


SITE PLAN Scale: 1" = 30 ft

SCOPE OF WORK: 1. SELECTIVE DEMOLITION AS INDICATATED ON DEMO / PROPOSED PLAN 2. NEW SELECTIVE MODIFICATIONS TO AN EXISTING RETAIL STORE 3. REMOVE AND REPLACE EXISTING STOREFRONT

NOTE TO CONTRACTOR: THESE DOCUMENTS ARE DEVELOPED AND DELIVERED AS A INSTRUMENT TO CONSTRUCT AS A "WHOLE", WHEN A PERMIT IS ISSUED. IT IS THE RESPONSIBILITY OF THE CONTRACTOR TO THOURGHALLY REVIEW AND CROSS REFERANCE DOCUMENT INFORMATION DETINIES IN ALL SUPERIOR AND THOURGHALLT REVIEW AND CROSS REFERANCE DOCUMENT INFORMATION BETWEEN ALL SHEETS AND ALL PERMITS. FAILURE TO PROVIDE SUBCONTRACTORS WITH ALL INFORMATION, DURING BIDDING AND CONSTRUCTION, AS A "WHOLE" SHALL NOT CONSTITUTE ADDITIONAL FEES IN THE FORM OF CHANGE ORDERS CHANGE ORDERS.

PROJECT INFORMATION	
JURISDICATION	TOWN OF PALM BEA
ZONING	
CONSTRUCTION TYPE	VB
USE GROUP	RETAIL
APPLICABLE CODES	2007 FBC WITH 200
LEVEL OF ALTERATION	LEVEL TWO

SPECIAL EXCEPTION #18-2011

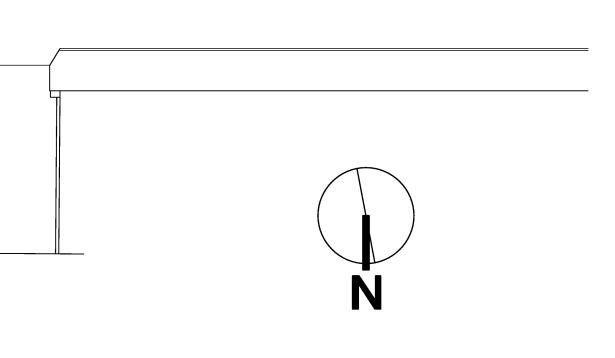

DRAWING TITLE

SHEET





ARCHITECTURAL GENERAL NOTES:

1. THE INTENT OF THE DRAWINGS IS TO INCLUDE ALL ITEMS FOR THE PROPER EXECUTION AND COMPLETION OF THE WORK, AND OMISSIONS IN THE DESCRIPTION DOES NOT RELIEVE THE G.C. OF DELIVERING A COMPLETED PROJECT IN ACCORDANCE WITH GENERALLY ACCEPTED PRACTICE.

2. THE G.C. SHALL CAREFULLY STUDY AND COMPARE THE CONTRACT DOCUMENTS AND SHALL REPORT TO THE DESIGNER ANY ERROR, INCONSISTENCY OR OMISSION HE MAY DISCOVER. THE G.C. SHALL DO NO WORK WITHOUT DRAWINGS, SPECIFICATIONS OR MODIFICATIONS.

3. ANY ITEM NECESSARY FOR THE PROPER COMPLETION OF THE WORK UNDER THIS CONTRACT WHICH IS NOT SPECIFICALLY COVERED IN THE DRAWINGS AND SPECIFICATIONS, SHALL BE PERFORMED IN A MANNER DEEMED GOOD PRACTICE TO THE TRADE.

4. THE G.C. SHALL MAINTAIN A COMPLETE SET OF UP-TO-DATE DRAWINGS, INCLUDING SHOP DRAWINGS, ON THE JOB SITE AT ALL TIMES. 5. WRITTEN DIMENSIONS ON THESE DRAWINGS SHALL HAVE PRECEDENCE OVER SCALED DIMENSIONS.

6. WHERE TWO METALS ADJOIN OR ARE AFFIXED TO EACH OTHER, THE G.C. SHALL PROVIDE THE NECESSARY INSULATING MATERIAL SO THAT NO VIBRATION OR NOISE IS TRANSMITTED BETWEEN THEM.

7. THE SPACE AROUND PIPES, DUCTS, ETC. AND PENETRATING RATED WALLS SHALL NOT EXCEED 1" AND SHALL BE PACKED SOLID WITH MINERAL WOOL, OR EQUAL, AND TO BE CLOSED OFF BY CLOSE FITTING METAL ESCUTCHEONS ON BOTH SIDES AS REQUIRED BY LOCAL CODE. 8. ALL MATERIALS AND METHODS OF CONSTRUCTION SHALL COMPLY WITH LOCAL CODES AND REQUIREMENTS OF ANY AGENCIES HAVING JURISDICTION.

9. THE G.C. SHALL BE RESPONSIBLE FOR PATCHING, REFINISHING, OR OTHER REPAIR WORK WHICH HAS BEEN DAMAGED DURING CONSTRUCTION.

10. THE G.C. SHALL REVIEW ALL SPECIFIED PRODUCTS AND BE RESPONSIBLE FOR DETERMINING AVAILABILITY. NO SUBSTITUTIONS OR ALLOWANCES WILL BE MADE FOR FAILURE TO ORDER ITEMS TO COORDINATE WITH THE PROJECT SCHEDULE. ITEMS WHICH REQUIRE A LEAD TIME INCOMPATIBLE WITH THE PROJECT SCHEDULE SHALL BE BROUGHT TO THE ATTENTION OF THE OWNER IN ORDER THAT PROPER ADJUSTMENTS CAN BE MADE.

11. THE G.C. IS TO PROVIDE EVERYTHING NECESSARY FOR THE COMPLETION OF THE WORK AS SHOWN IN ALL DRAWINGS WITH THE EXCEPTION OF THOSE ITEMS "BY OTHERS" OR "N.I.C.". THE G.C. SHALL COORDINATE HIS WORK WITH THE VARIOUS "BY OTHERS" OR 'N.I.C." CONTRACTORS.

12. THE G.C. SHALL BE RESPONSIBLE FOR CONSTRUCTION MEANS, METHODS, TECHNIQUES, SEQUENCES AND PROCEDURES AND FOR COORDINATING ALL PORTIONS OF THE WORK UNDER THE CONTRACT.

13. THE G.C. SHALL BE RESPONSIBLE AND PAY FOR CONTROLLED INSPECTION OF MATERIALS AND CONSTRUCTION METHODS IN ACCORDANCE WITH ALL LAWS, ORDINANCES, RULES AND REGULATIONS OF THE BUILDING DEPARTMENT AND OTHERS AUTHORITIES HAVING JURISDICTION.

14. THE JOB SITE SHALL BE MAINTAINED IN A REASONABLY NEAT AND ORDERLY CONDITION AND KEPT FREE FROM ACCUMULATION OF WASTE MATERIALS DURING THE ENTIRE CONSTRUCTION PERIOD.

743 BISCAYNE DRIVE WEST PALM BEACH, FLORIDA 33401 561.659.5683

STEPHEN MICHAEL ROY AIA, NCARB FLORIDA REGISTERED ARCHITECT AR91404

PROJECT:

SELECTIVE MODIFICATIONS TO

150 WORTH AVE PALM BEACH UNIT 136 FLORIDA 33480


TITLE SITE PLAN

DRAWING INFO	
DATE	6-1-11
SCALE	VARIES
DESIGNED BY	MESA
DRAWN BY	MESA
PROJECT #	111608

REVISIONS AND ISSUE

A	6/1/11	PERMIT
NO.	DATE	ISSUE NOTE
NO.	DATE	REVISION NOTE

OWNERSHIP AND USE OF THESE DOCUMENTS & SPECIFICATIONS AS INSTRUMENTS OF SERVICE ARE AND SHALL REMAIN THE PROPERITY OF THE ARCHITECT WHETHER THE PROJECT THEY ARE MADE FOR IS EXECUTED OR NOT. THEY SHALL NOT BE USED BY THE OWNER OR OTHERS ON OTHER PROJECTS OR FOR ADDITIONS ON OTHER PROJECTS BY OTHERS, EXCEPT BY AGGREEMENT IN WRITING WITH ARCHITECT

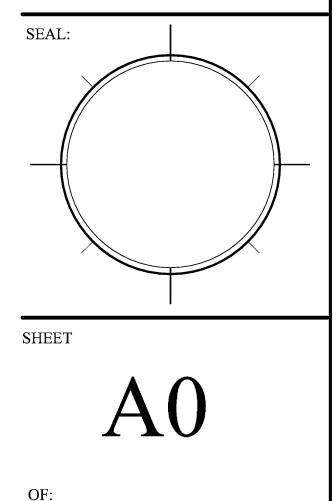


NOTE: TENANT SHALL SUBMIT SIGNAGE SEPERATELY FOR LANDLORD TO REVIEW FOR APPROVAL


FEET.

TOILET ROOM REQUIREMENTS: 403.4.1 LOCATION OF TOILET FACILITIES IN OCCUPANCIES OTHER THAN COVERED MALLS. IN OCCUPANCIES OTHER THAN COVERED MALLS, THE REQUIRED PUBLIC AND EMPLOYEE TOILET FACILITIES SHALL BE LOCATED NOT MORE THAN ONE STORY ABOVE OR BELOM THE SPACE REQUIRED TO BE PROVIDED WITH TOILET FACILITIES, AND THE PATH OF TRAVEL TO SUCH FACILITIES SHALL NOT EXCEED A DISTANCE OF 500 FFET

LIFE SAFTY TABULATIONS:		
CONSTRUCTION TYPE: VB - SF	PRINKLERED	
1. OCCUPANCY CLASSIFICATION	N	
GROUP M - MERCANTILE		
· GROUND FLOOR		
MERCANTILE	= 3425 S.F.X	
TOTAL = OCCUPANT LOAD	= 115 PERSONS	
TABLE 1004 MAX. TRAVEL D EGRESS WIDTH PER PERSON 19 PERSONS X 0.2 = 23" TOT, EXIT WIDTH PROVIDED:	0.2" ;THEREFORE,	BPRINKLED.
1	DOUBLE 36" DOOR	= 72"
T MINIMUM CORRIDOR WIDTH R MINIMUM CORRIDOR WIDTH P		= 72"
MAXIMUM DEAD END COOIDC	DR LENGTH 20'-0"	

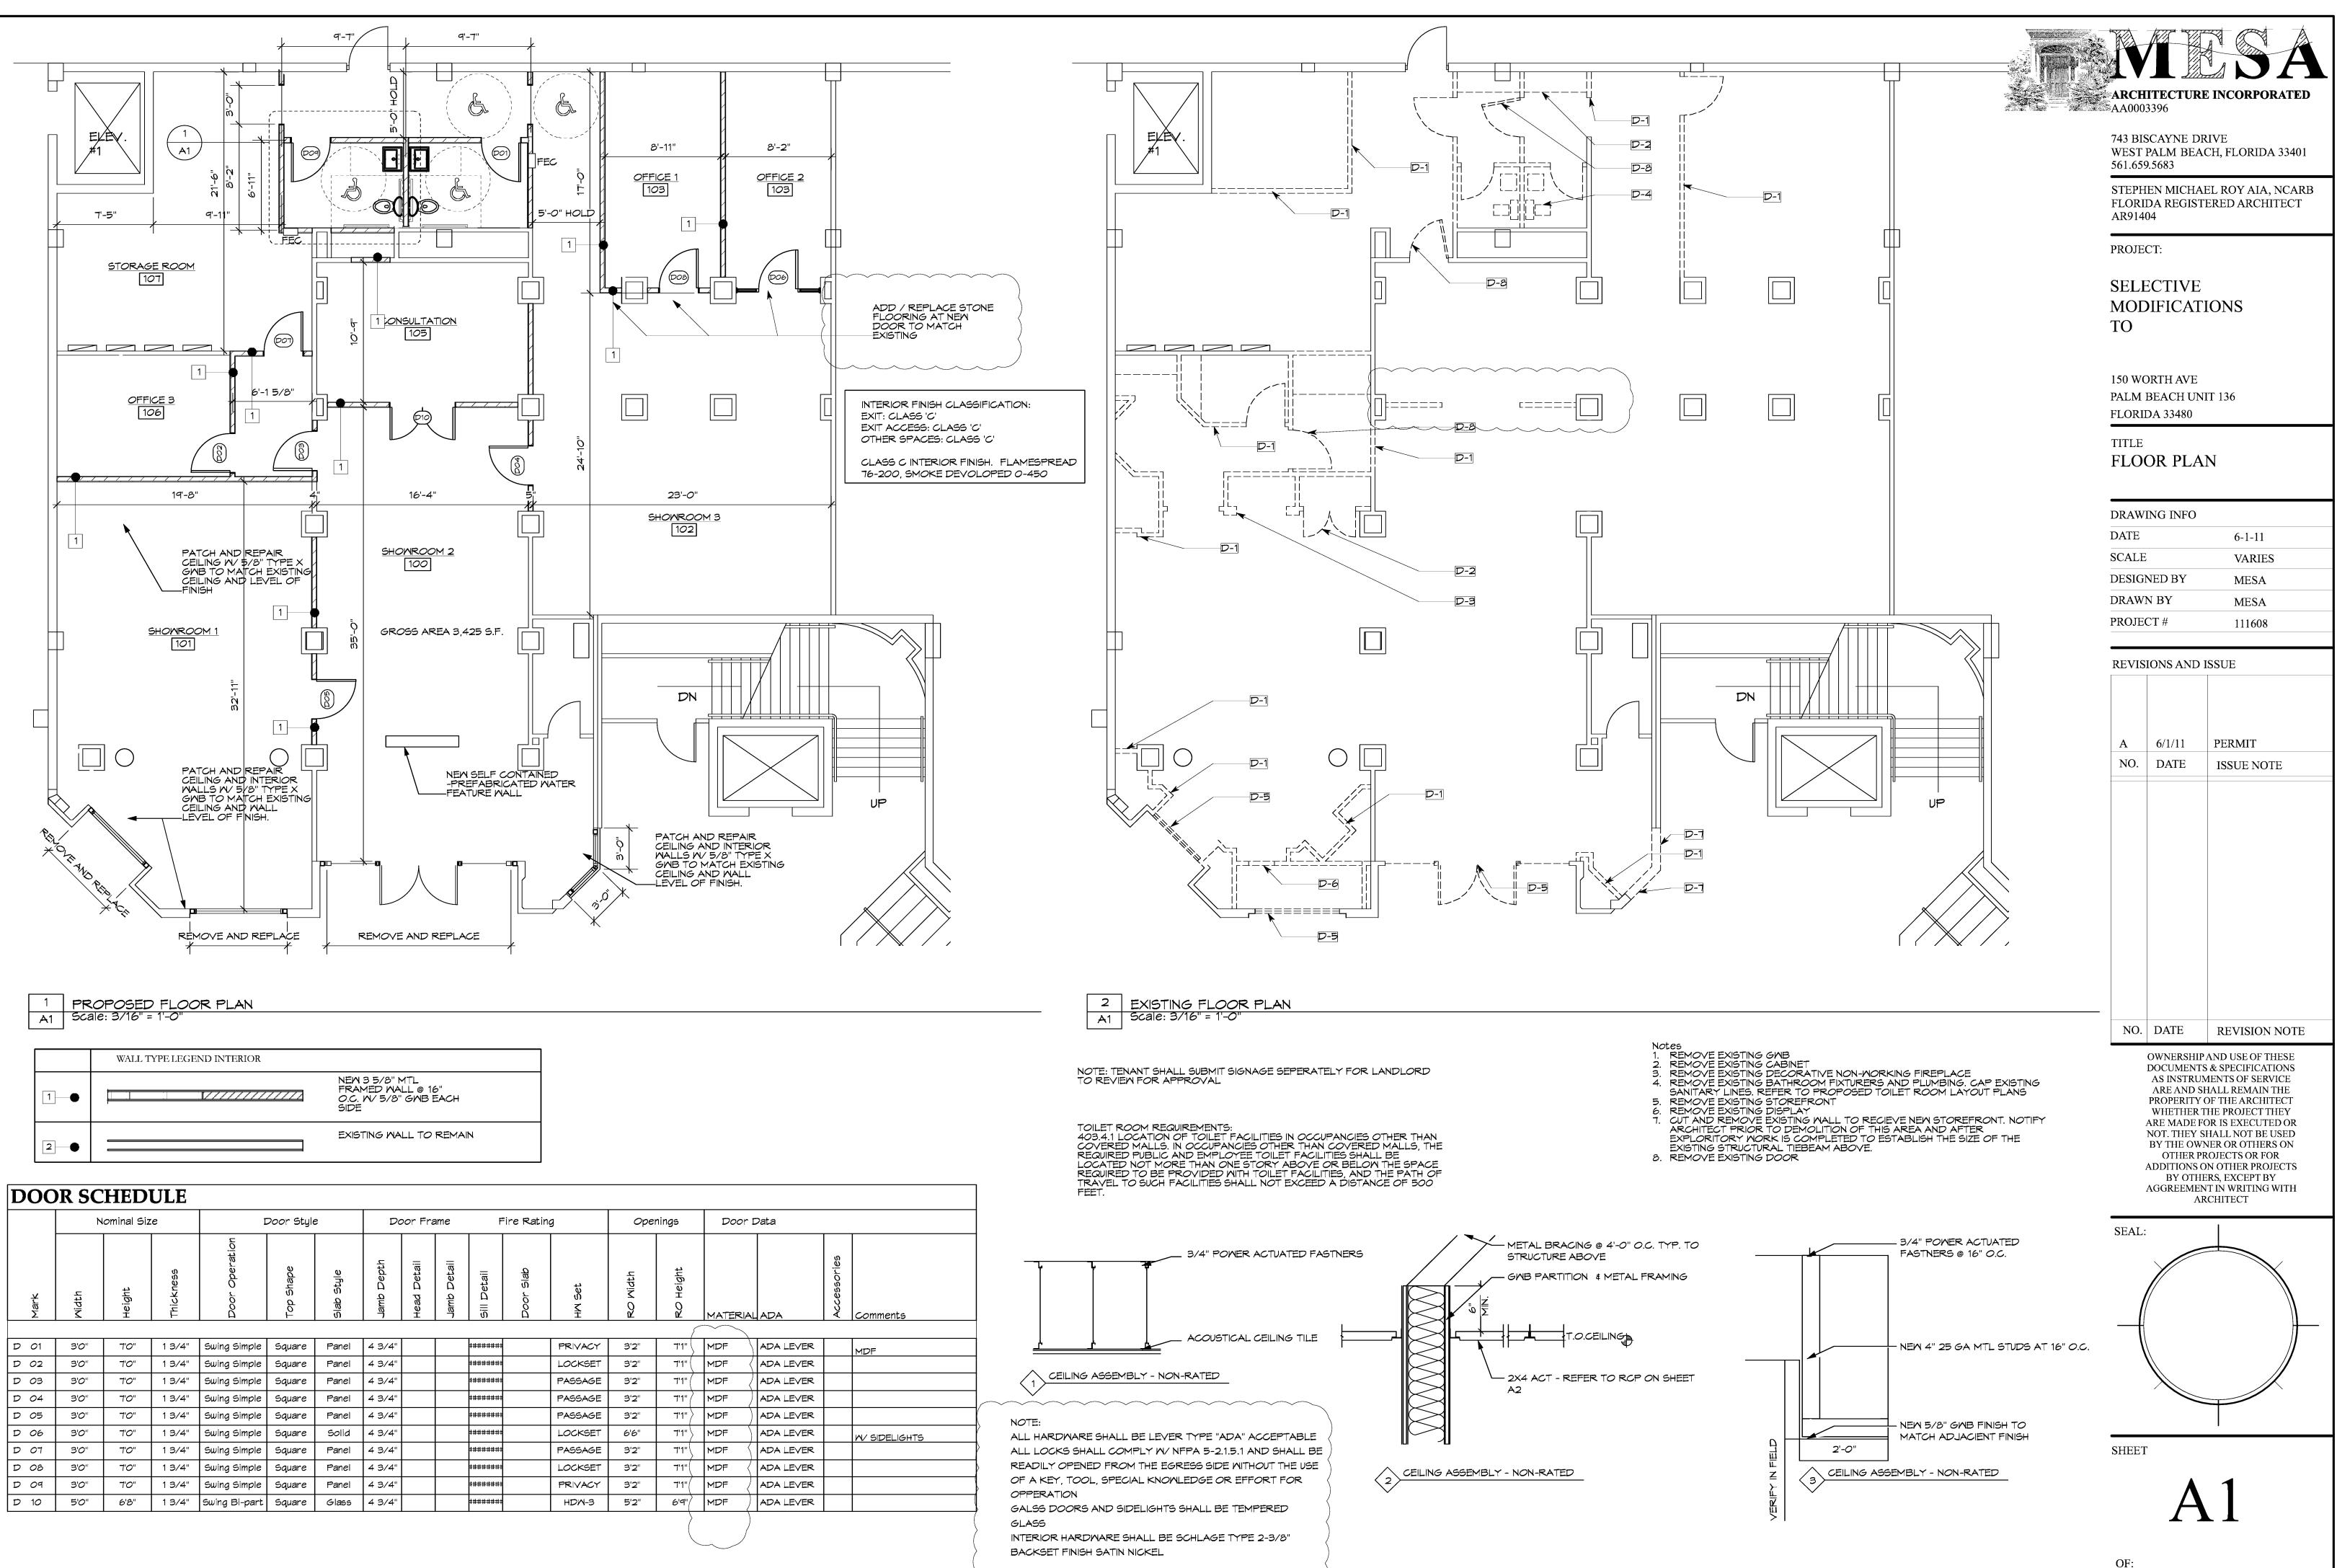


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														{	\sim
D 01	3'0"	י0"	1 3/4"	Swing Simple	Square	Panel	4 3/4"			*######		PRIVACY	3'2"	7'1" \	MDF
D 02	3'0"	7'0"	1 3/4"	Swing Simple	Square	Panel	4 3/4"			+######		LOCKSET	3'2"	7'1" (MDF
D 03	3'0"	י0'ד	1 3/4"	Swing Simple	Square	Panel	4 3/4"			+######		PASSAGE	3'2"	1"(MDF
D 04	3'0"	7'0"	1 3/4"	Swing Simple	Square	Panel	4 3/4"			*****		PASSAGE	3'2"	7'1"	MDF
D 05	3'0"	י0"	1 3/4"	Swing Simple	Square	Panel	4 3/4"			*######		PASSAGE	3'2"	1" >	MDF
D 06	3'0"	7'0"	1 3/4"	Swing Simple	Square	Solid	4 3/4"			+######		LOCKSET	6'6"	7'1"	MDF
TO CT	3'0"	י0"	1 3/4"	Swing Simple	Square	Panel	4 3/4"			*######		PASSAGE	3'2"	7'1"	MDF
D 08	3'0"	7'0"	1 3/4"	Swing Simple	Square	Panel	4 3/4"			+######		LOCKSET	3'2"	7'1"(MDF
D 09	3'0"	7'0"	1 3/4"	Swing Simple	Square	Panel	4 3/4"			*****		PRIVACY	3'2"	7'1"(MDF
D 10	5'0"	6'8"	1 3/4"	Swing Bi-part	Square	Glass	4 3/4"			+######		HDM-3	5'2"	6'9"	MDF
	•	•	÷		.	•	-		•			•	•		-

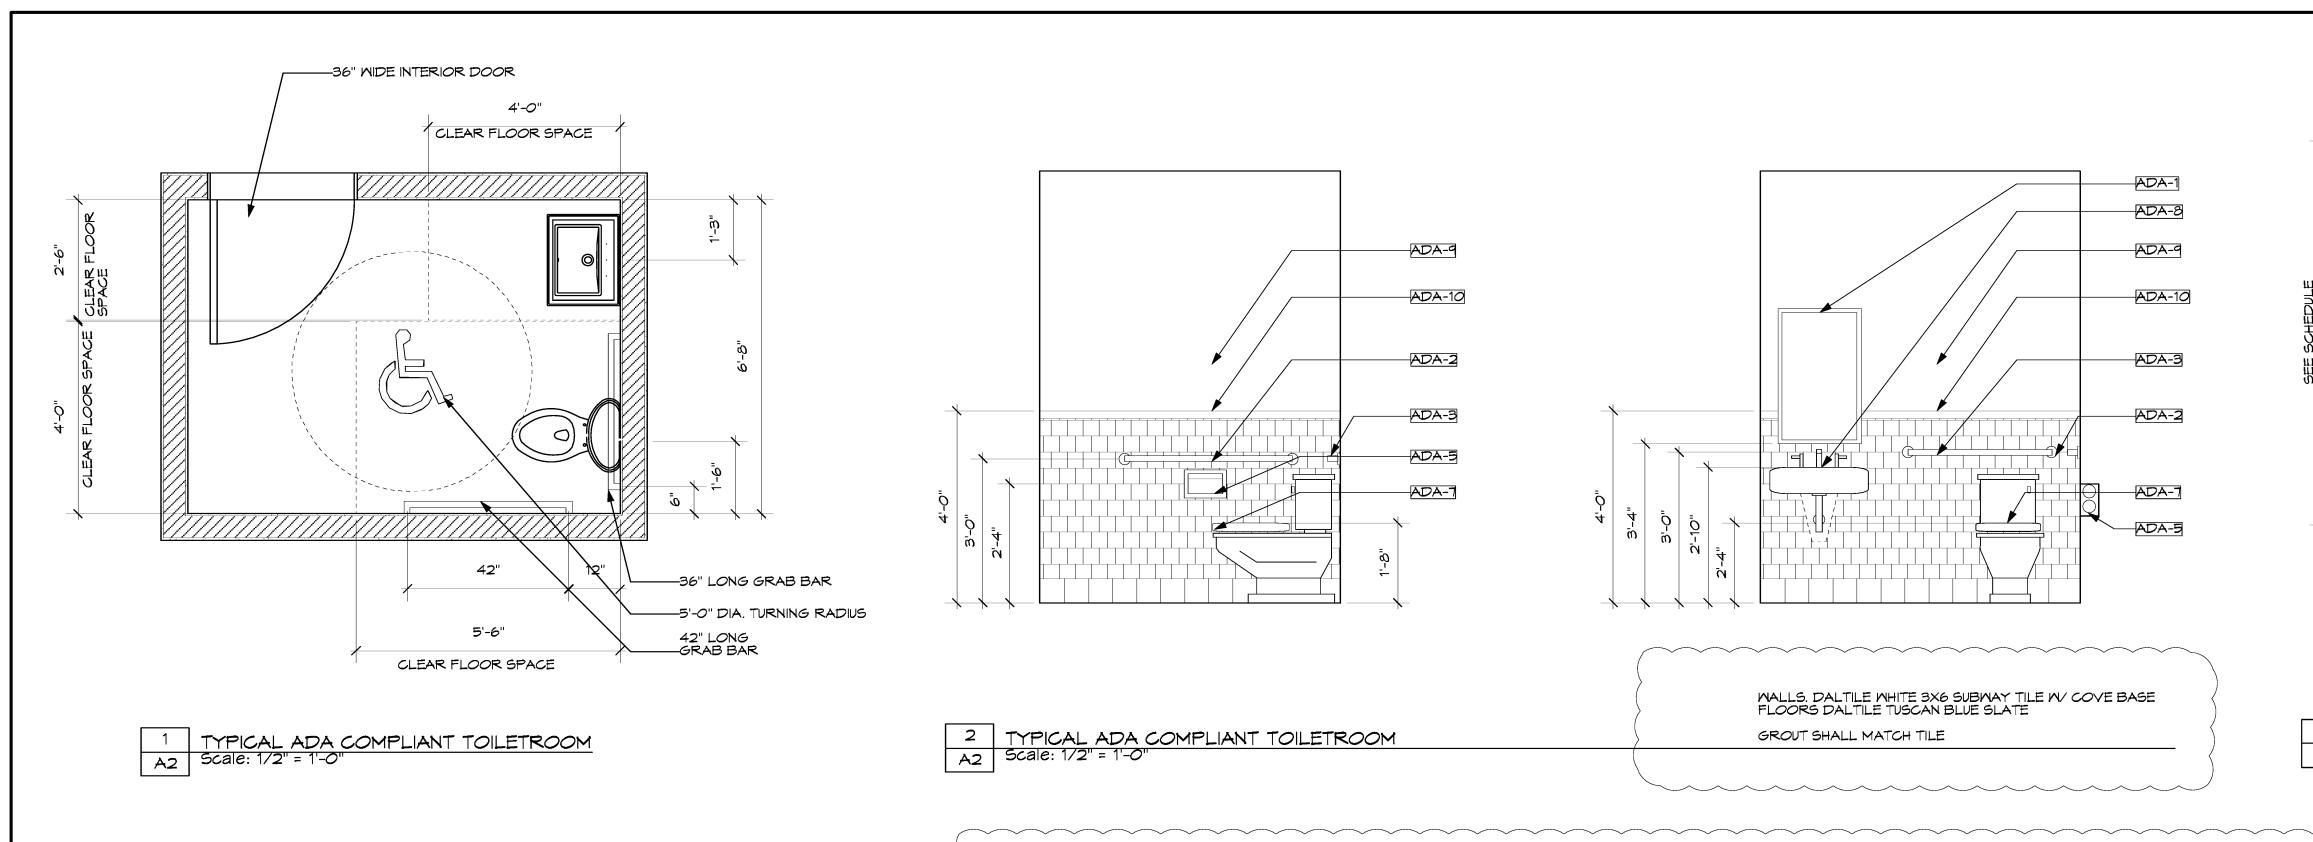


	ADA KEY NOTES:
ADA-1	TILT MIRROW 18X30". BOTTOM @ 40" MAX. A.F.F.
ADA-2	GRAB BAR 42" LONG
ADA-3	GRAB BAR 36" LONG
ADA-4	PAPER TOWEL / WASTE RECEPTACLE (BOBRICK B-369)
ADA-5	TOILET PAPER (BOBRICK B-274)
ADA-6	SOAP DISPENSER (BOBRICK (B-115)
ADA-7	WATER CLOSET. REFER TO PLUMBING DRAWINGS FOR SPECIFICATIONS
ADA-8	LAVATORY ADA COMPLIANT. REFER TO PLUMBING DRAWINGS FOR SPECIFICATIONS
ADA-9	PAINTED GWB OWNER TO SELECT COLOR AND FINISH
ADA-10	CERAMIC TILE OWNER TO SELECT
	NOTE: CONTRACTOR SHALL COORIDINATE WITH PLUMBING DRAWINGS, FIXTURERS & SPECIFICATIONS AND PROVIDE BLOCKING AS REQUIRED. ALL BLOCKING SHALL COMPLY WITH FBC 2007 601


AΓ	DA NOTES:
WA'	FER CLOSET SEAT HEIGHT SHALL BE 17" - 19"
A.F.	F.
CEN	JTERLINE OF WATER CLOSET SHALL BE 18" FROM
SID	E
GR/	AB BAR BEHIND WATER CLOSET SHALL BE 36"
LOI	NG AND 34" A.F.F.
GR/	AB BAR DIAMETER SHALL BE 1 1/2"
SPA	CE BETWEEN WALL AND GRABBAR SHALL BE 1
1/2'	1
TO	LET PAPER DESPENSER SHALL BE 36" MAX. FROM
R E/	AR WALL19" MIN. A.F.F.
KN	EE CLEARANCE AT LAVATORY - APRON 29" MIN.
HEI	GHT 8" MIN. DEPTH
LAV	ATORY DEPTH 17" MIN.
MIR	ROR BOTTOM EDGE SHALL BE 40" MAX. A.F.F.
SUR	FACE MOUNTED PAPER TOWEL/WASTE
REC	CEPTACLE MOUNTED 50 1/2" A.F.F.
ALI	PIPES UNDER LAVITORIES SHALL BE EQUIPTED
WIT	TH PIPE WRAP
THI	E LAVATORY SHALL NOT ENCROACH INTO THE
REG	UIRED CLEAR FLOOR SPACE FOR THE WATER
CLC	DSET
THI	E WATER CLOSET SHALL BE LOCATED IN THE
COI	RNER DIAGONAL TO THE DOOR.
THI	E TOILET STAL DOOR SHALL NOT SWING INTO
THI	E REQUIRED CLEAR FLOOR SPACE FOR ANY
	TURE.

5 TYPICAL ADA COMPLIANT TOILETROOM A2 Scale: 1/4" = 1'-0"

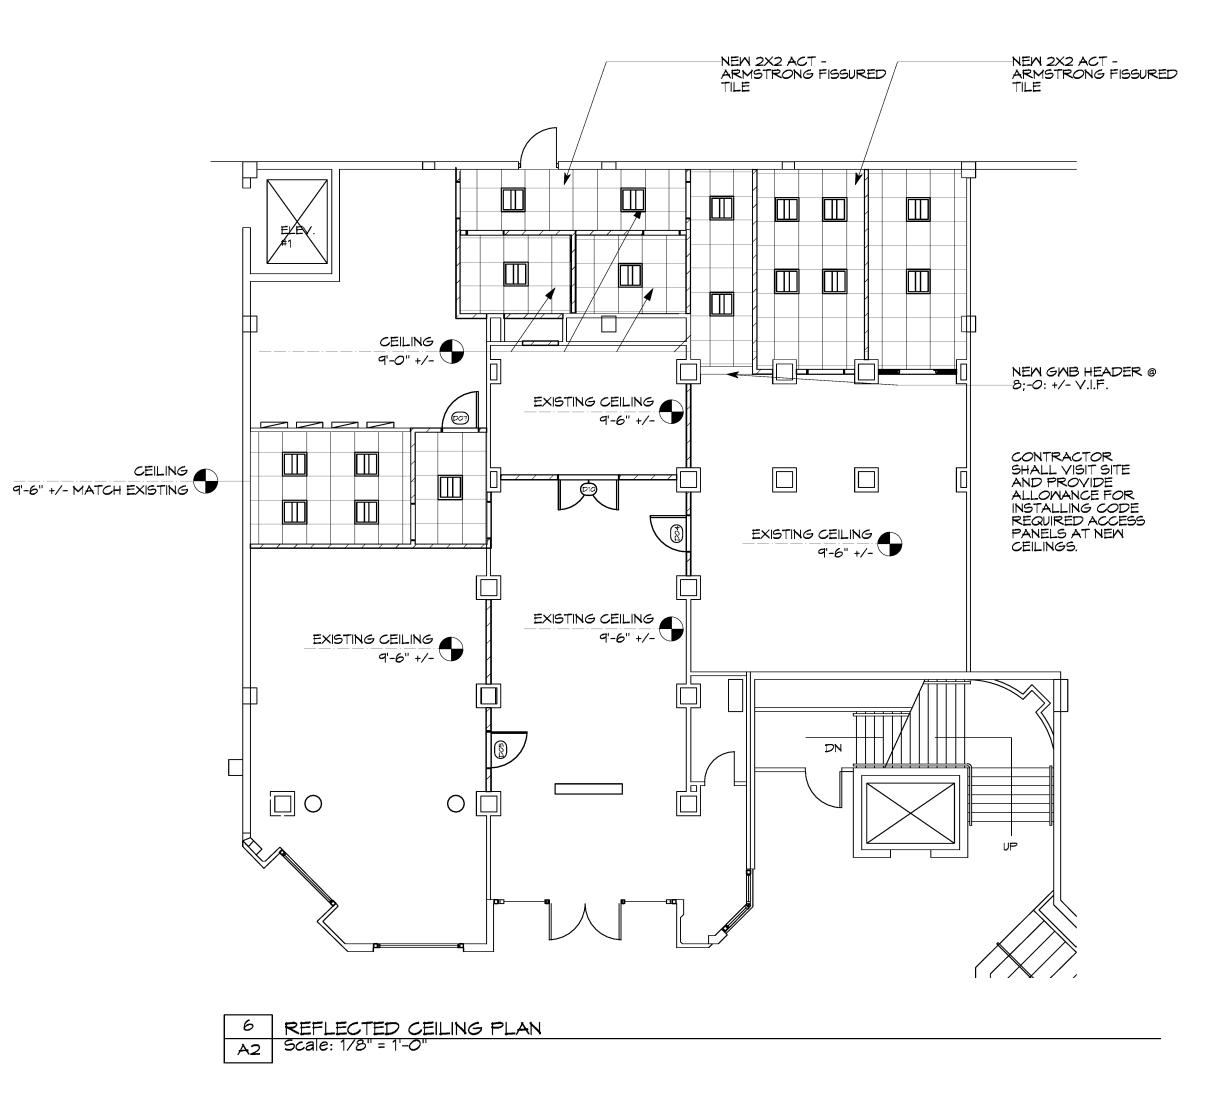

7 A2 |

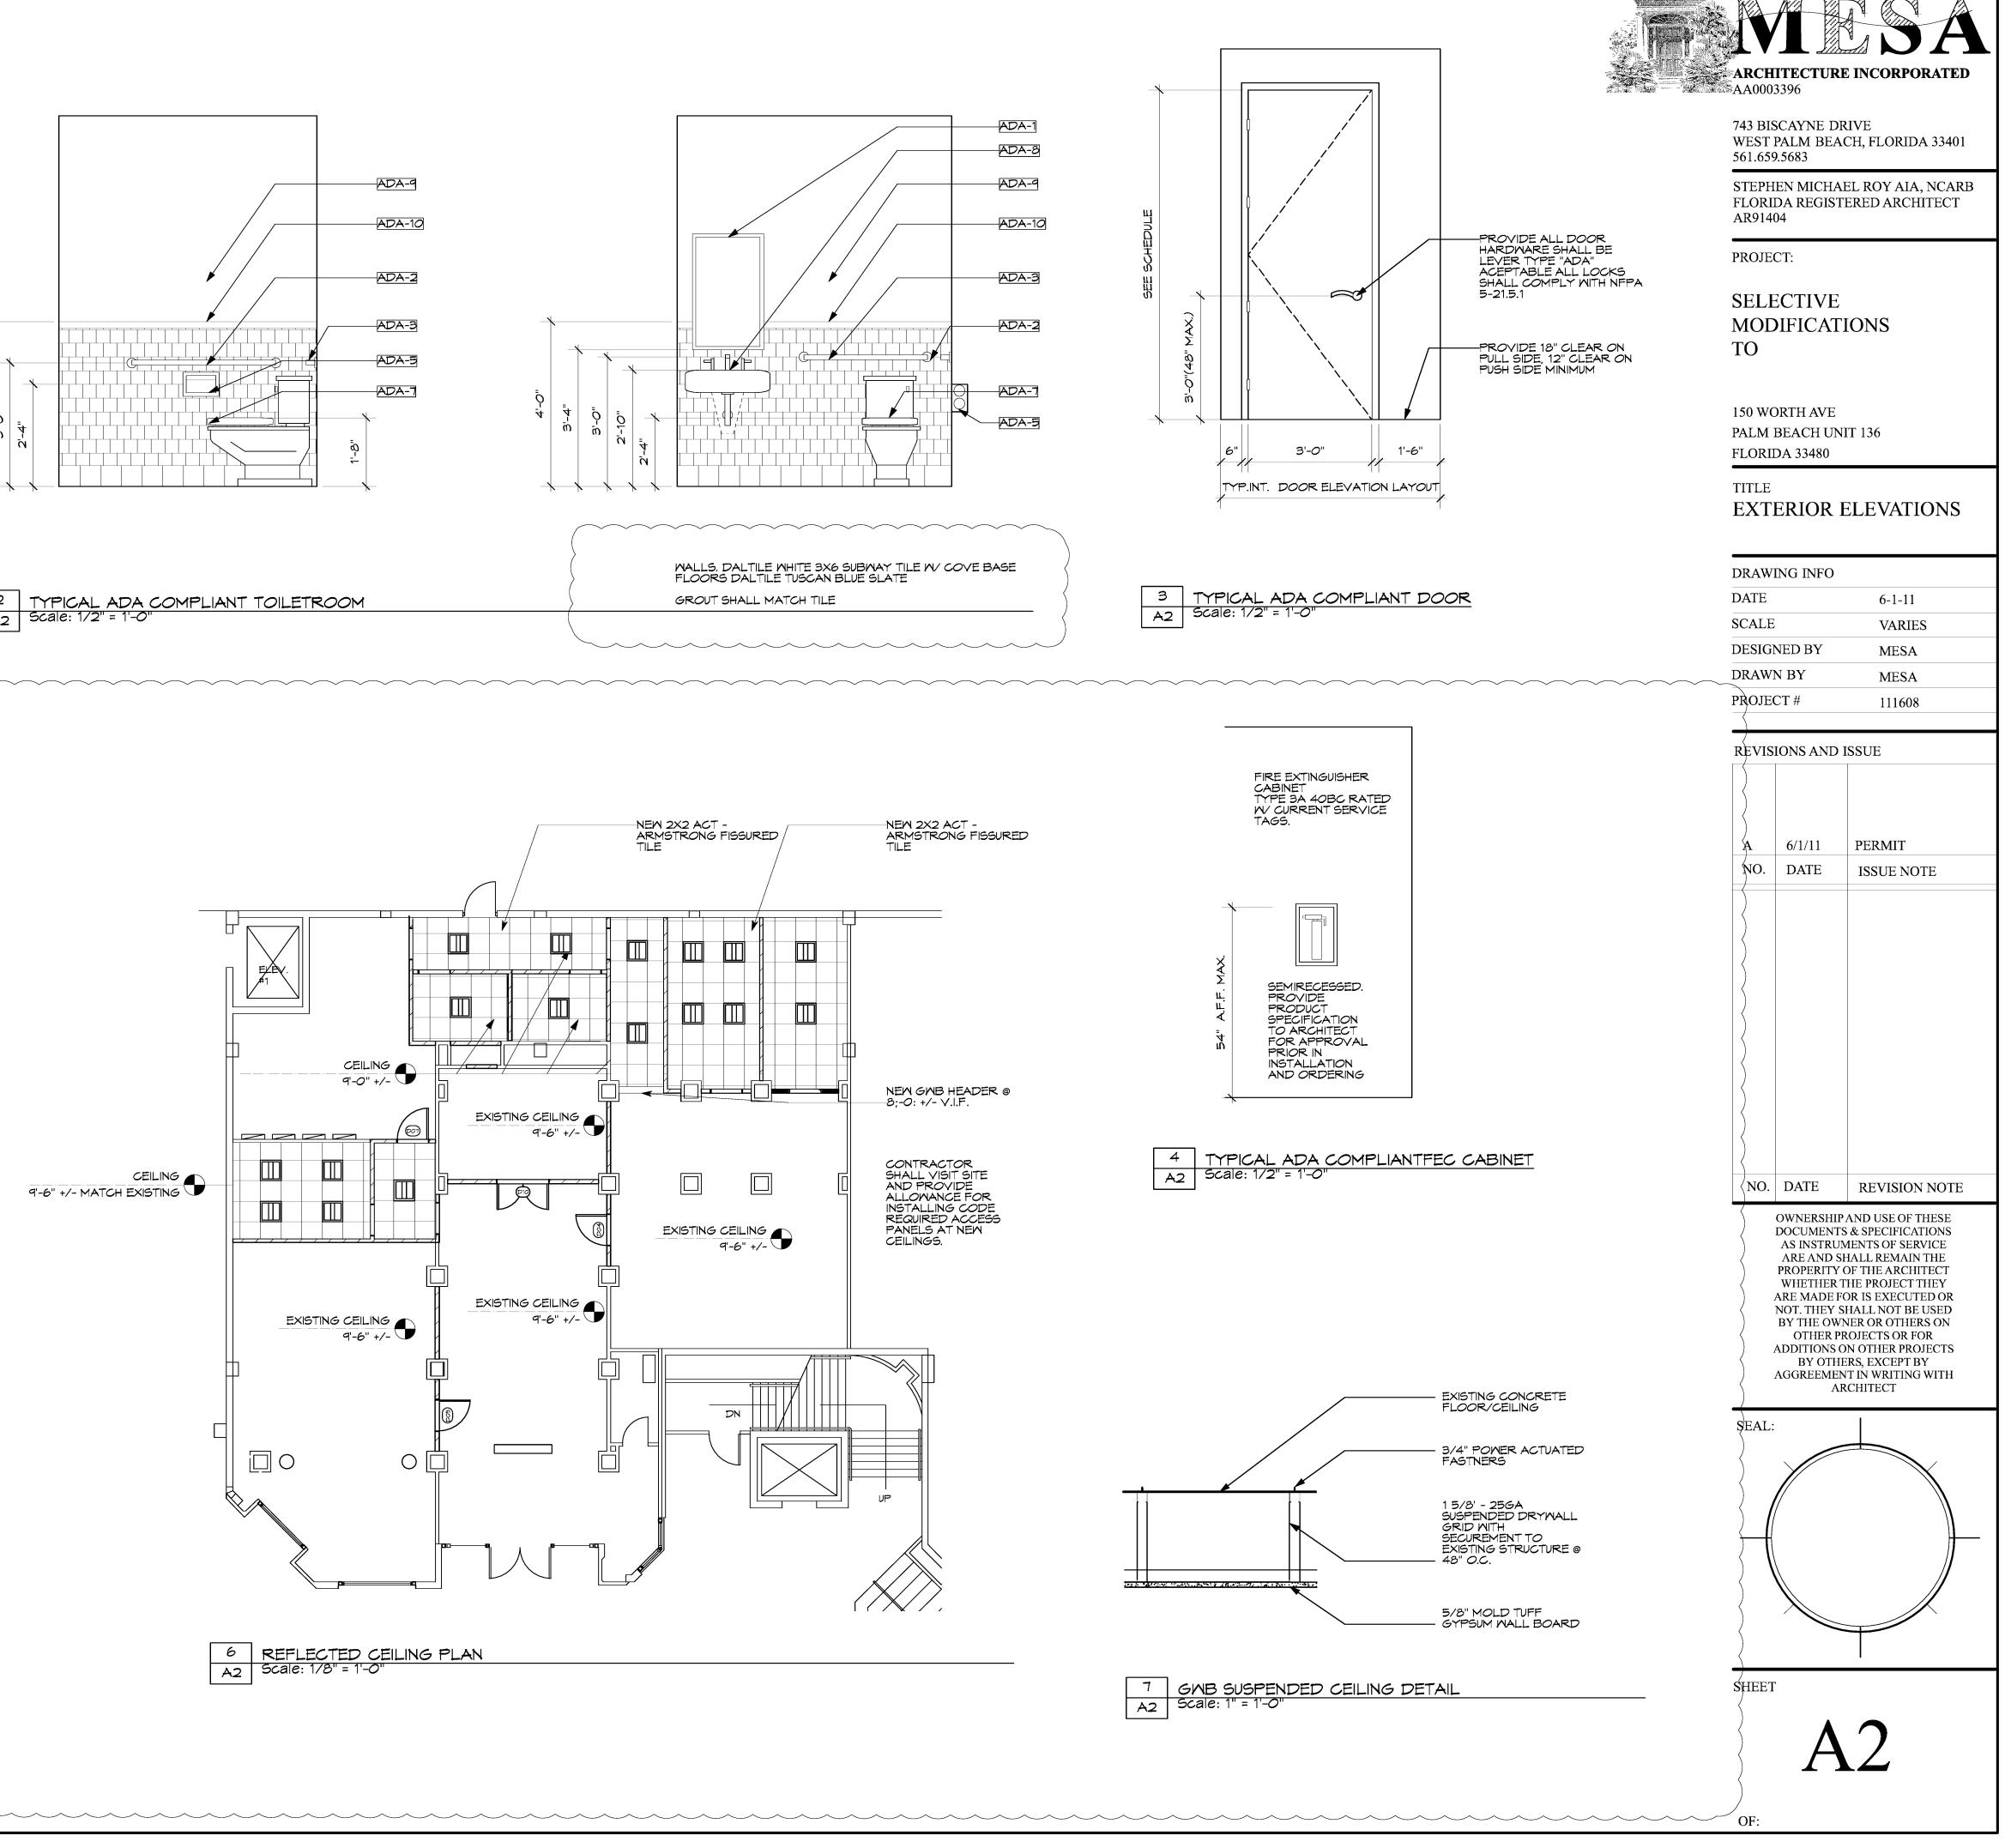


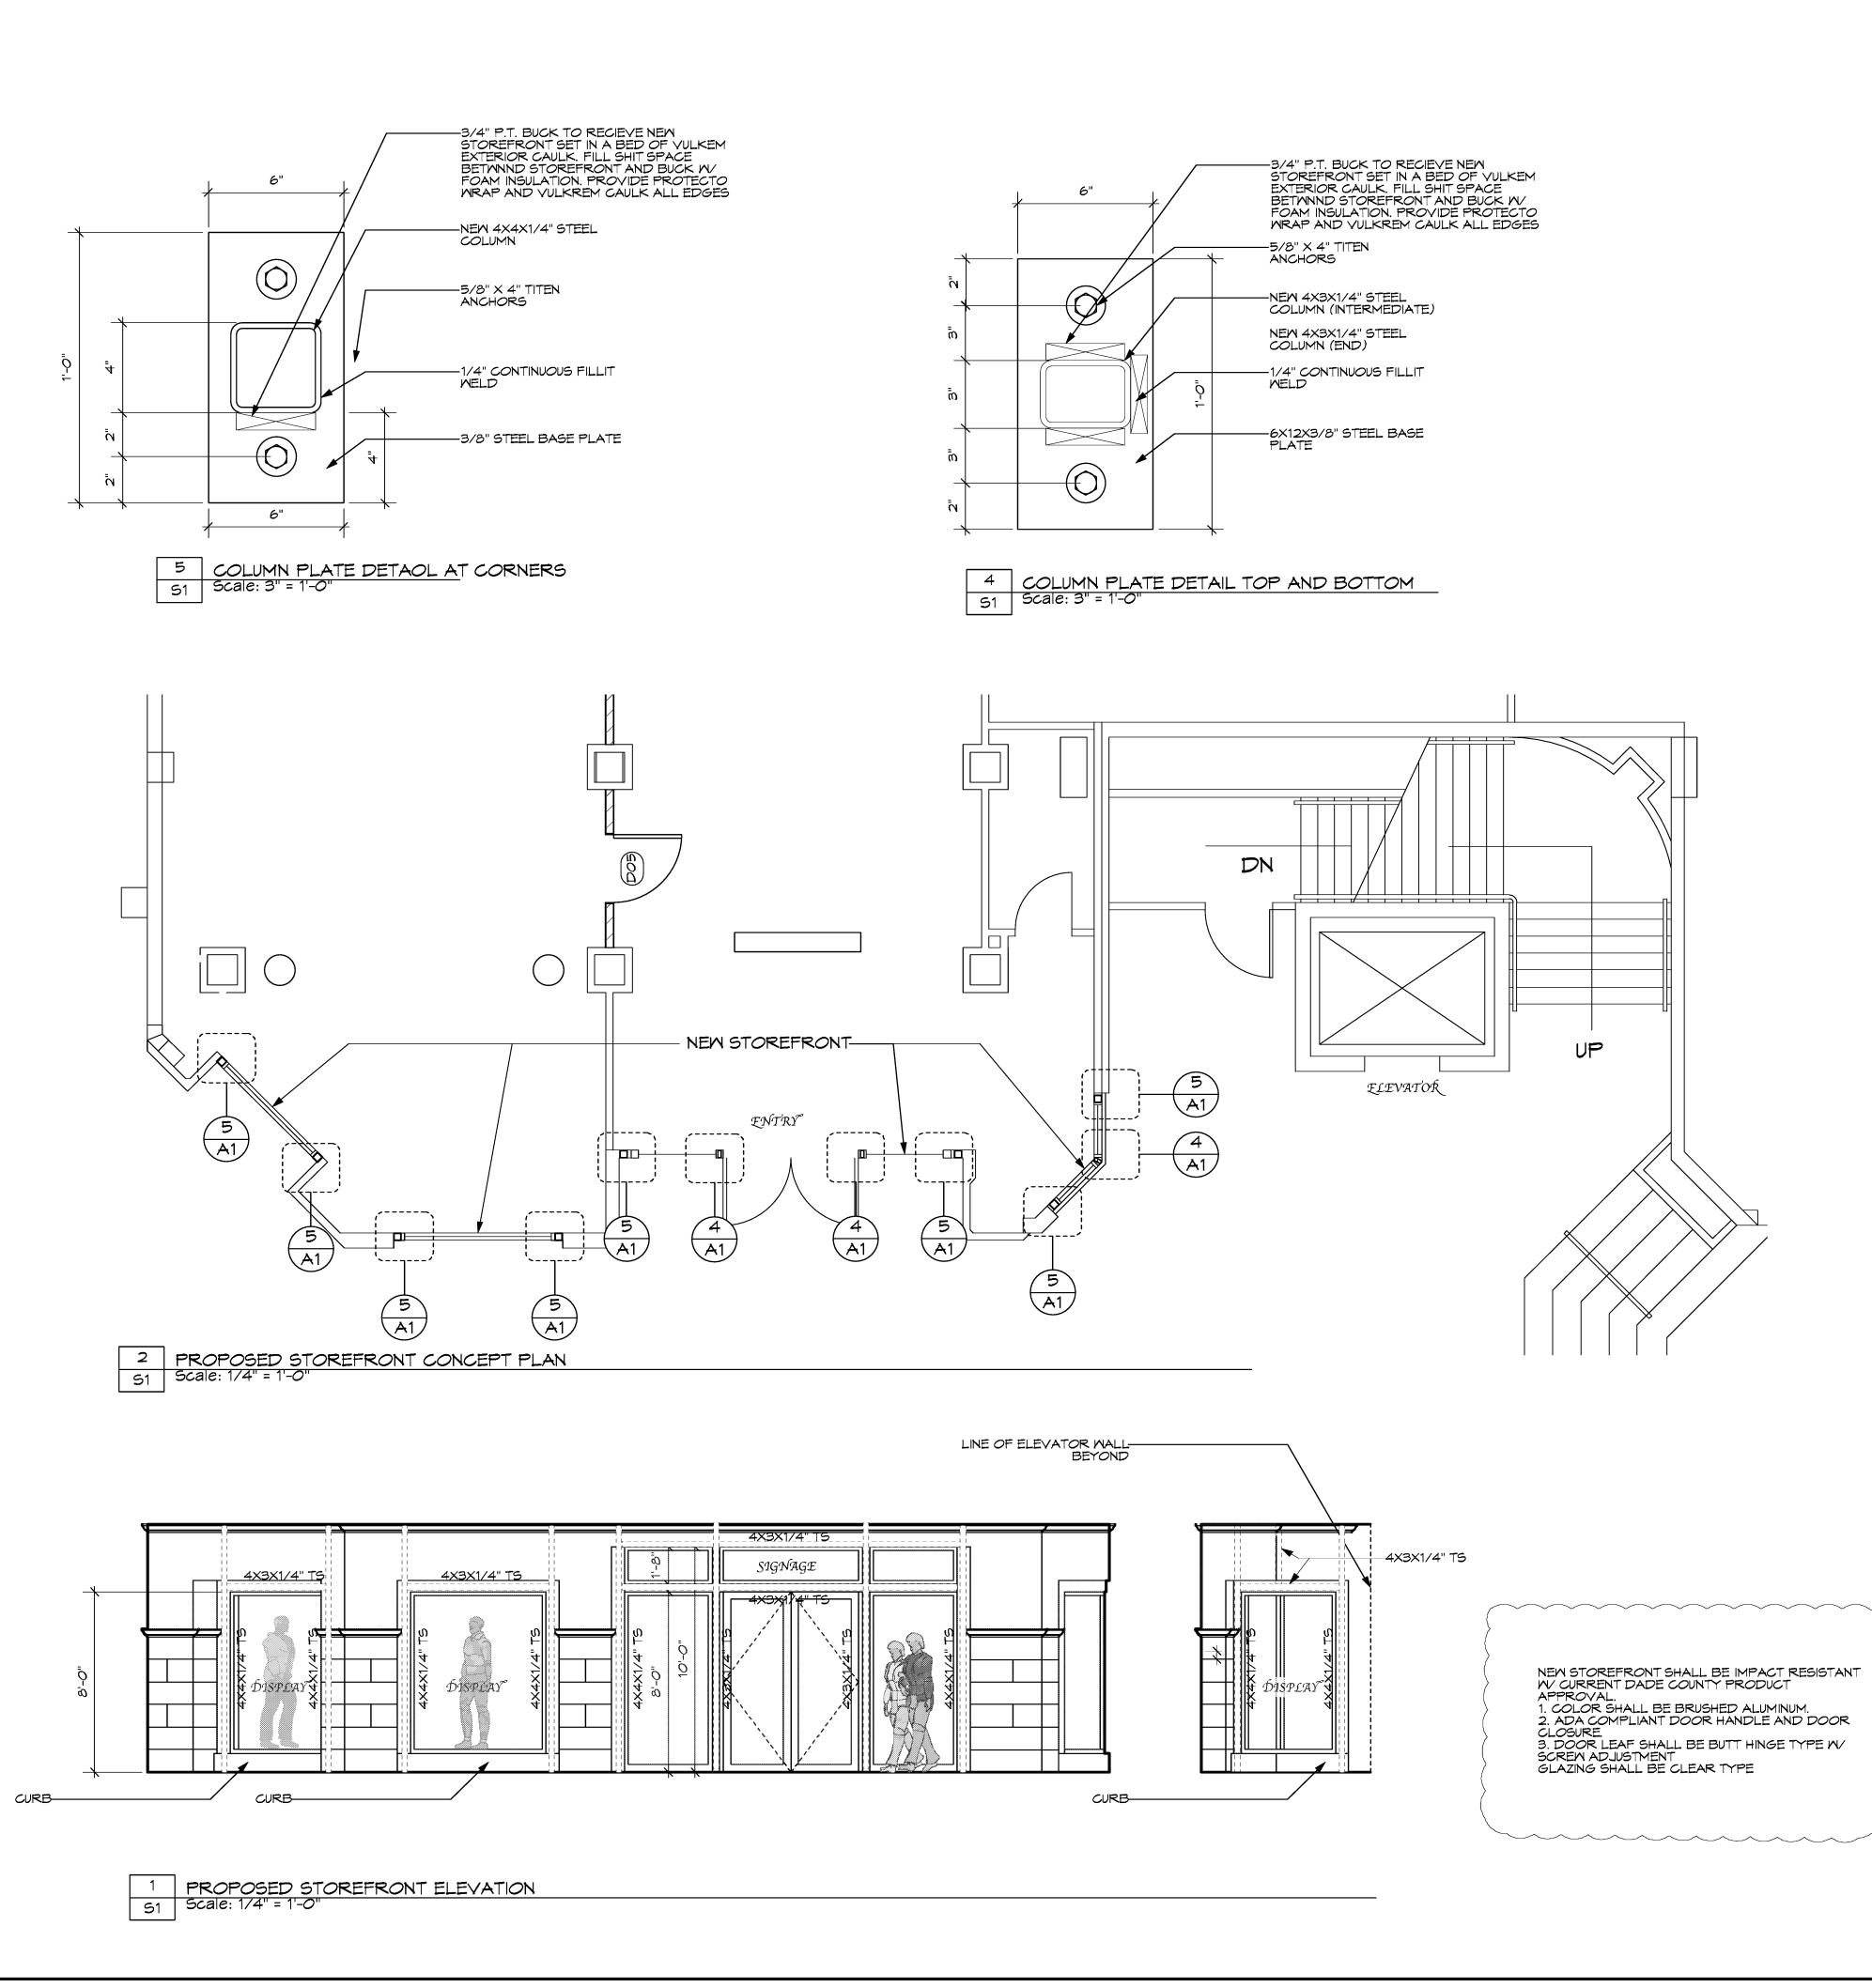

STRUCTURAL DESIGN CRITERIA & CODES:

THIS STRUCTURE HAS BEEN DESIGNED IN ACCORDANCE WITH THE FLORIDA BUILDING 743 BISCAYNE DRIVE CODE (FBC) 2007 WEST PALM BEACH, FLORIDA 33401 WIND LOADS ARE BASED UPON ANSI/ASCE 7-05 MINIMUM DESIGN LOADS FOR BUILDINGS 561.659.5683 AND OTHER STRUCTURERS, PART 6. ALL PRIMARY FRAMING AND EXTERIOR ENVELOPE COMPONENTS AND CLADDING SHALL BE DESIGNED AND CONSTRUCTED TO RESIST THE STEPHEN MICHAEL ROY AIA, NCARB LOADS AND FORCES DERIVED FROM THIS STANDARD. FLORIDA REGISTERED ARCHITECT AR91404 WIND DESIGN CRITERIA: 140 MPH (3 SECOND GUST) BASE WIND SPEED: EXPOSURE: **PROJECT: IMPORTANCE FACTOR:** I = 1.0EAVE HEIGHT ABOVE GRADE: 40'-0" RIDGE HEIGHT ABOVE GRADE: 40'-0" SELECTIVE BASIC VELOCITY PRESSURE (Q): 37 PSF MODIFICATIONS ACTUAL PRESSURERS FOR SPECIFIC COMPONENTS AND CLADDING MATERIALS SHALL BE CALCULATED BASED UPON THE SPECIFIC TRIBUTARY AREA (IN SQ. FT.) CONSIDERED. TO NOTE: IT IS THE RESPONISBILITY OF THE PRODUCE MANUFACTURER / SUPLIER / INSTALLER TO PROVIDE EVIDANCE OF WIND PRESSURE (OR IMPACT) RESISTANCE COMPLIANCE (PRODUCT 150 WORTH AVE APPROVAL) TO THE BUILDING CODE AUTHORITY HAVING JURISTICATION. THE SUBMITTAL SHALL COMPLY WITH THE SPECIFIC DESIGN REQUIREMENTS OF THIS PROJECT. REFER TO PALM BEACH UNIT 136 CRITERIA THIS SHEET. FLORIDA 33480 TWO STORY TITLE MEAN ROOF HEIGHT: 40'-0" **STOREFRONT** COMPONECTS AND CLADDING DESIGN PRESSURER: 70.33 P.S.F. (WORST CASE) PLAN GLAZING PROTECTION THE INSTALLATION OF THE GLAZING PROTECTION HAVE BEED CONSIDERED IN THE DESIGN SUPPORT STRUCTURE AS DESCRIBED AS FOLLOWS: DRAWING INFO DATE 6-1-11 FBC, ASCE 7-05 SCALE VARIES MPH (3 SECOND GUST) BUILDING WIDTH - 6'-0" MINIMUM DESIGNED BY MESA EDGE ZONE SUCTION INTERIOR ZONE SUCTION ELEVATION DRAWN BY MESA PRESSURE PRESSURE +52.6 PSF -61.86 PSF +52.6PSF -70.33PSF TWO STORY PROJECT # 111608 **REVISIONS AND ISSUE** -EXISTING CONCRETE BEAM TO REMAIN PERMIT 6/1/11 Α NO. DATE **ISSUE NOTE** NOTE: ATTACHE COLUMN AND BEAM TO EXISTING CONCRETE STRUCTURE WITH 3/8"X6" X 12" STEEL PLATE WITH (2) 1/2" WEDGE ANCHORS TYP - NEW 3/4" STUCCO VENEER (SAND FINISH) OVER PAPER BACKED WIRE LATH OVER 3/4" DENS GLASS GOLD PANELING OVER NEW METAL FRAMING —NEW 4X4X1/4" STEEL COLUMN SECURE TO EXISTING CONSTERE STRUCTURE TOP AND BOTTOM. VERIFY DIMENSION IN FIELD --6" 22 GAUGE METAL FRAMING @ 16" O.C. PROVIDE #10 TEK SCREWS —NEW STOREFRONT BREAKMETAL OVER 4X3X1/4" HORIZ. BEAM • • • ••***•**•• NO. DATE **REVISION NOTE** —NEW STOREFRONT BREAKMETAL OVER 4X3X1/4" HORIZ. BEAM **OWNERSHIP AND USE OF THESE DOCUMENTS & SPECIFICATIONS** AS INSTRUMENTS OF SERVICE -REMOVE EXISTING CAST STONE RETURNS. PROVIDE NEW CAST STONE PERPENDICULAR RETURNS(OMIT EXISTING ANGLE). NEW CAST STONE SHALL MATCH EXISTING ARE AND SHALL REMAIN THE PROPERITY OF THE ARCHITECT WHETHER THE PROJECT THEY ARE MADE FOR IS EXECUTED OR NOT. THEY SHALL NOT BE USED -NEW CAST STONE TO MATCH EXISTING BY THE OWNER OR OTHERS ON OTHER PROJECTS OR FOR ADDITIONS ON OTHER PROJECTS BY OTHERS, EXCEPT BY --NEW ALUMINUM STOREFRONT AGGREEMENT IN WRITING WITH ARCHITECT -NEW STOREFRONT BREAKMETAL OVER SEAL: 4X4X1/4" COLUMN NOTE FINISH INTERIOR CURB TO MATCH EXISTING INSIDE FOR FION OF RERS -FINISH EXISTING TERROCOTTA TILE TO -REMAIN SHEET з

DESIGN SUPPOR	T STRUCTURE AS DE	SCRIBED A
WIND PRESSURE	RS:	
REFERANCED D	АТА:	2007 F
WIND LOAD:		140 M
EDGE STRIP:		10% B
ELEVATION	EDCE ZONE	SUCT

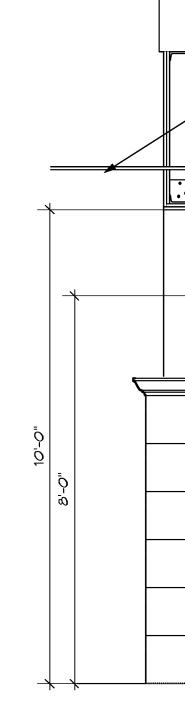


ONTRACTOR SHALL PROVIDE
RCHITECT W/ SHOP DRAWINGS F
PPROVAL PRIOR TO FABRICATIO
TOREFRONT & STEEL STRUCTURE
COLUMN & BEAM)

SECTION THRU STOREFRONT Scale: 1/2" = 1'-0" 51

OF:

ARCHITECTURE INCORPORATED

AA0003396

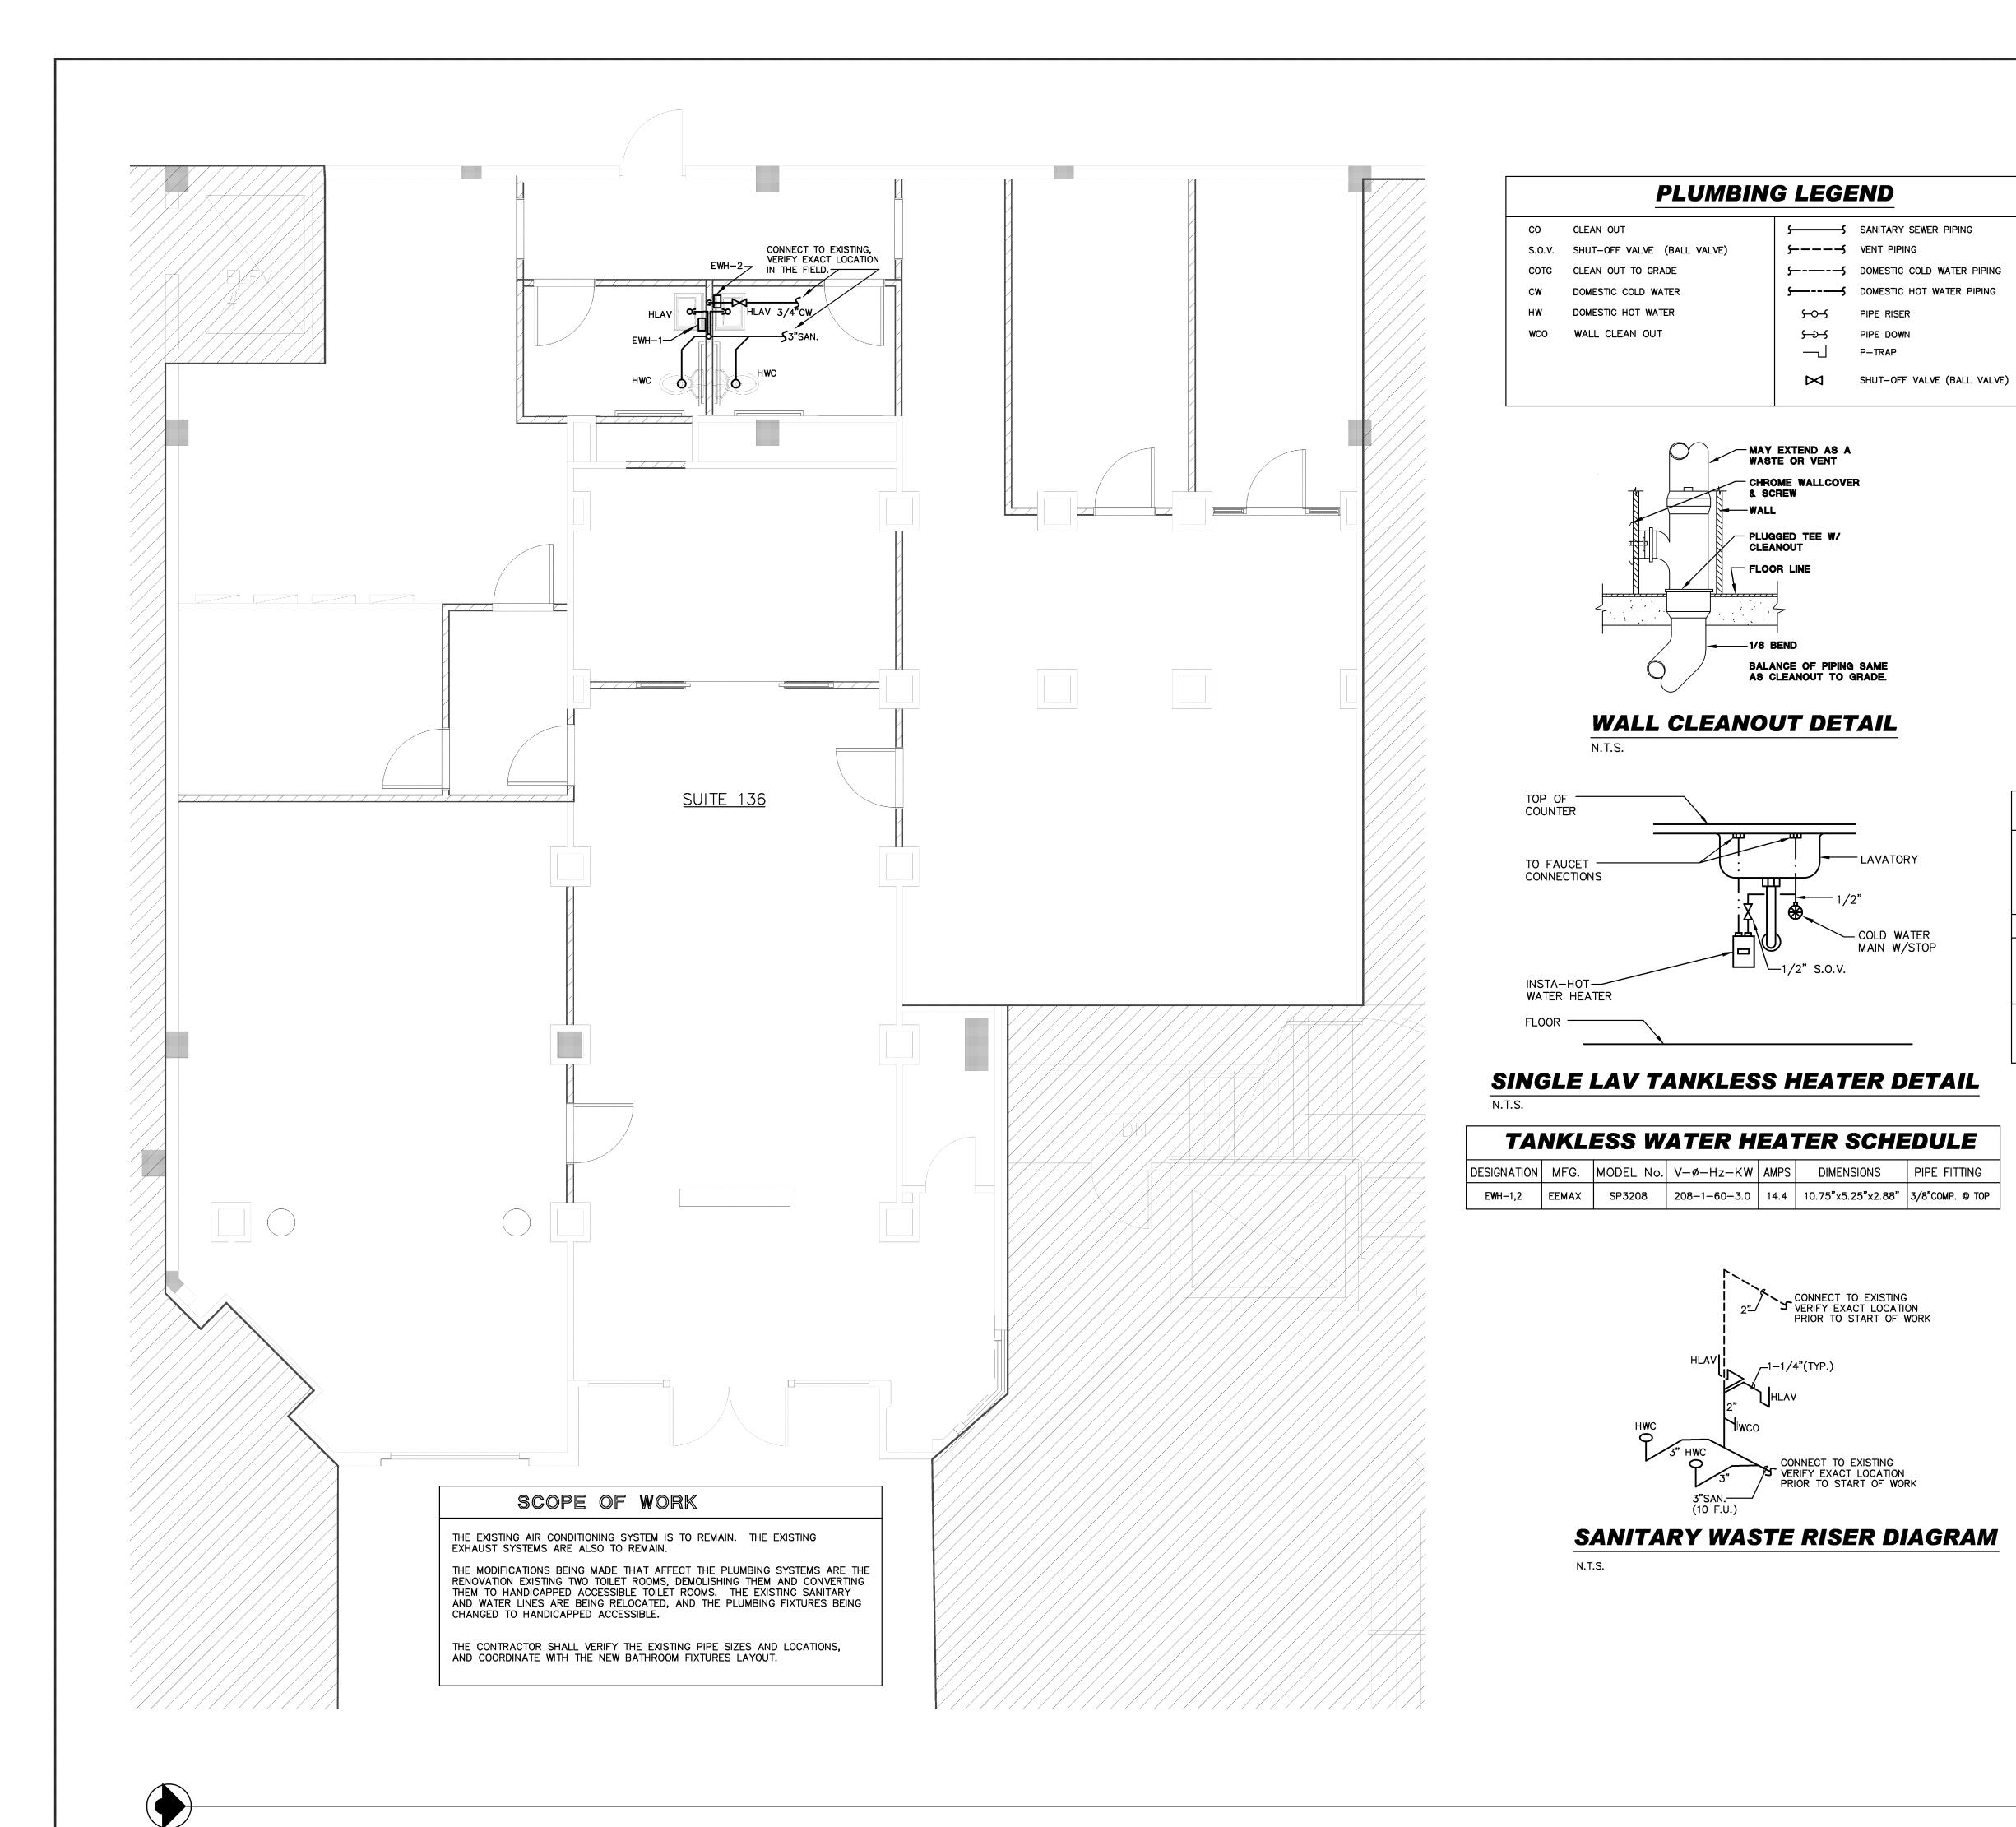

ARCHITECTURE INCORPORATED AA0003396 **PLUMBING NOTES** 743 BISCAYNE DRIVE WEST PALM BEACH, FLORIDA 33401 DO NOT SCALE THE DRAWINGS. CONSULT THE ARCHITECT'S AND STRUC-561.659.5683 TURAL DRAWINGS FOR DIMENSIONS. REFER TO ARCHITECTURAL PLANS FOR EXACT LOCATIONS AND MOUNTING HEIGHTS OF ALL PLUMBING STEPHEN MICHAEL ROY AIA, NCARB FIXTURES AND DRAINS. COORDINATE WITH ALL TRADES PRIOR OF ANY FABRICATION AND EQUIPMENT INSTALLATION. FLORIDA REGISTERED ARCHITECT CONSULT THE ARCHITECT'S DRAWINGS FOR ALL GRADE AND FINISH AR91404 FLOOR ELEVATIONS. . ALL GRAVITY LINES SIZED TO SLOPE 1/8" PER FOOT FOR PIPES 3" AND LARGER. 1/4" PER FOOT SLOPE FOR PIPES 2-1/2 4. ALL PLUMBING WORK SHALL COMPLY WITH THE 2007 F AS LOCALLY AMENDED. CLEANOUTS SHALL BE INSTALLED AS INDICATED ON THE REQUIRED BY THE PLUMBING CODE. POTABLE HOT AND COLD WATER PIPING SHALL BE TYPI WITH FORGED OR WROUGHT SOLDER FITTINGS. WHERE OR UNDER SLAB, ENCLOSE IN POLYETHELYNE PIPE SLE IN THE COPPER PIPE. UNDERGROUND PIPING SHALL B SANITARY WASTE, STORM DRAIN & VENT PIPING SHALL BE SCHEDU SCHEDULE 40 PVC SHALL BE USED ABOVE GRADE AS LONG AS IT IS USE HUBLESS CAST-IRON IN PLENUM SPACE. . THE CONTRACTOR SHALL ARRANGE AND PAY FOR ALL INSPECTIONS AND REINSPECTIONS REQUIRED. CONTRACTOR SHALL VISIT THE EXISTING SITE PRIOR TO SHALL INVESTIGATE ALL CONDITIONS THAT AFFECT HIS VERIFY LOCATIONS, SIZES, DIMENSIONS, AND INVERT EL ON-SITE SANITARY SEWERS, WATER MAINS AND MAKE CONNECTIONS CAN BE MADE. THE CONTRACTOR SHALL ARCHITECT/ENGINEER AWARE OF ANY CONFLICTS.


PLUMBING FIXTURE PIPE SIZES							
FIXTURE	ITEM	WASTE	TRAP	cw	нw	FBC-P TABLE 604.4 MAX. WATER FLOW RATE	
н₩С	WATER CLOSET (HANDICAPPED)	3"	INT.	1/2"	_	1.6 GPF	
HLAV	LAVATORY (HANDICAPPED)	2"	1-1/4"	1/2"	1/2"	0.5 GPM	

PLUMBING	EIYTIIDE	TOI
PLUMBING	FIXIURE	LIJI

AMERICAN STANDARD, ELKAY & ZURN PRODUCTS ARE LISTED. SUBMIT A FIXTURES FOR APPROVAL. COLOR IS WHITE UNLESS OTHERWISE NOT ALL FIXTURES SHALL COMPLY WITH TABLE 604.4 OF F.B.C.-PLUMBIN PROVIDE FIXTURES WITH REQUIRED STOP VALVES, FITTINGS, ACCESSO SUPPORTS, ETC, AS REQUIRED FOR A COMPLETE FUNCTIONAL PLUM SYSTEM.

(HANDICAPPED)

TAG	MFG.	MODEL	REMARKS
HLAV AMERICAN 0355.012 STANDARD		0355.012	WALL HUNG HANDICAPPED LAVATORY
	0174107410	2385.403	FAUCET, 0.5 GPM, GRID DRAIN, LESS POP-UP HOLE, VANDAL RESISTANT, INDEXED METAL LEVER HANDLE, PROVIDE TRUEBRO DRAIN/PIPE INSULATION.
HWC	AMERICAN STANDARD	2386.012 4021.800	HANDICAPPED TANK TYPE WATER CLOSET (1.6 GPF) CADET ADA ELONGATED, 16–1/2"H PROVIDE ALTERNATE TANK CONFIGURATION WITH TRIP LEVER ON RIGHT SIDE WHERE REQUIRED. OLSONITE #95 SEAT.

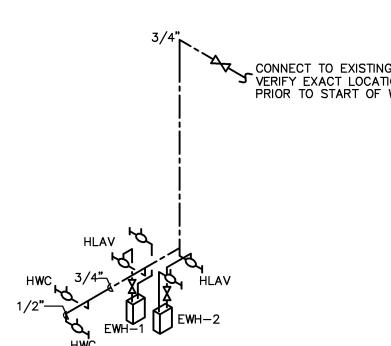


DOMESTIC WATER RISER D

N.T.S.

ZED TO SLOPE 1/8" PER FOOT FOR PIPES 3" R FOOT SLOPE FOR PIPES 2-1/2" AND SMALLER. SHALL COMPLY WITH THE 2007 PLUMBING CODE,					PROJECT:			
NOT:::		0 A TTT	×		STO	REFRO	NT	
INSTALLED AS INDICATED ON THE DRAWINGS AND AS MBING CODE.					MODIFICATIONS			
JGHT SOL JOSE IN P	DER FITTIN OLYETHEL	NGS. W YNE PIP	HERE PIF E SLEEVE	'L" COPPER PING RUNS E WITH NO JOINTS COPPER TYPE "K".	ТО			
RAIN & VENT PIPING SHALL BE SCHEDULE 40 PVC BELOW GRADE. E USED ABOVE GRADE AS LONG AS IT IS NOT IN PLENUM SPACE. RON IN PLENUM SPACE.					150 WORTH AVENUE UNIT 136 PALM BEACH			
LL ARRAN			ALL PE	RMITS,	FLORI	DA 33480		
L CONDIT ZES, DIMEI	IONS THA NSIONS, A TER MAIN HE CONTR	T AFFEC ND INVE S AND ACTOR S	T HIS WO RT ELEV MAKE CI SHALL M/	ATIONS OF ALL ERTAIN THAT ALL	title PI	LUMBI PLAN		
					DRAW	ING INFO		
G FI)	XTU	RE I	PIPE	SIZES	DATE		05-29-11	
					SCALE	ļ	VARIES	
WASTE	TRAP	cw	нw	FBC-P TABLE 604.4 MAX. WATER FLOW RATE		NED BY	MESA	
3"	INT.	1/2"	-	1.6 GPF			MESA	
2"	1-1/4"	1/2"	1/2"	0.5 GPM	PROJE	СТ #	111608	
					REVIS	IONS AND	ISSUE	
ING	FIX	TUF	REL	IST				
	S ARE LIS JNLESS O							
	04.4 OF F _VES, FITT			IES,				
	LETE FUN				NO.	DATE		
REMARKS					NO.	DATE	ISSUE NOTE	
WALL HUN	NG HANDIO	CAPPED	LAVATOR	Υ Υ				
VANDAL F	RESISTANT	, INDEXE	ED METAL	S POP-UP HOLE, LEVER HANDLE,				
		· ·		JLATION. LOSET (1.6 GPF)				
CADET AD PROVIDE	A ELONG	ATED, 16 E TANK	6–1/2"H CONFIGU	RATION WITH TRIP				
LEVER ON OLSONITE	RIGHT SI	DE WHEI	RE REQU	IRED.				
3/4"	``.×\ ∀	VERIF	ECT TO E Y EXACT TO STA	EXISTING LOCATION RT OF WORK	NO.	OWNERSHI DOCUMENT AS INSTRU ARE AND S PROPERITY WHETHER ARE MADE F NOT. THEY	REVISION NOTE P AND USE OF THESE S & SPECIFICATIONS MENTS OF SERVICE SHALL REMAIN THE OF THE ARCHITECT THE PROJECT THEY FOR IS EXECUTED OR SHALL NOT BE USED ONER OR OTHERS ON	
-1 ↓	R HLAV WH-2 R RIS	SER	DIA	GRAM		ADDITIONS BY OTH AGGREEMEI A	PROJECTS OR FOR ON OTHER PROJECTS IERS, EXCEPT BY NT IN WRITING WITH RCHITECT	
1402 N.E. Oakland Michael	AEL A 34TH COUR PARK, FL A. BASSFORI LICENSE #57	2T 33334 D) PHONE: (954) 298–0700 EMAIL: mbassford@aol.com	SHEET	P	.1	

PLUMBING PLAN

SCALE: 1/4"=1'-0" OF:

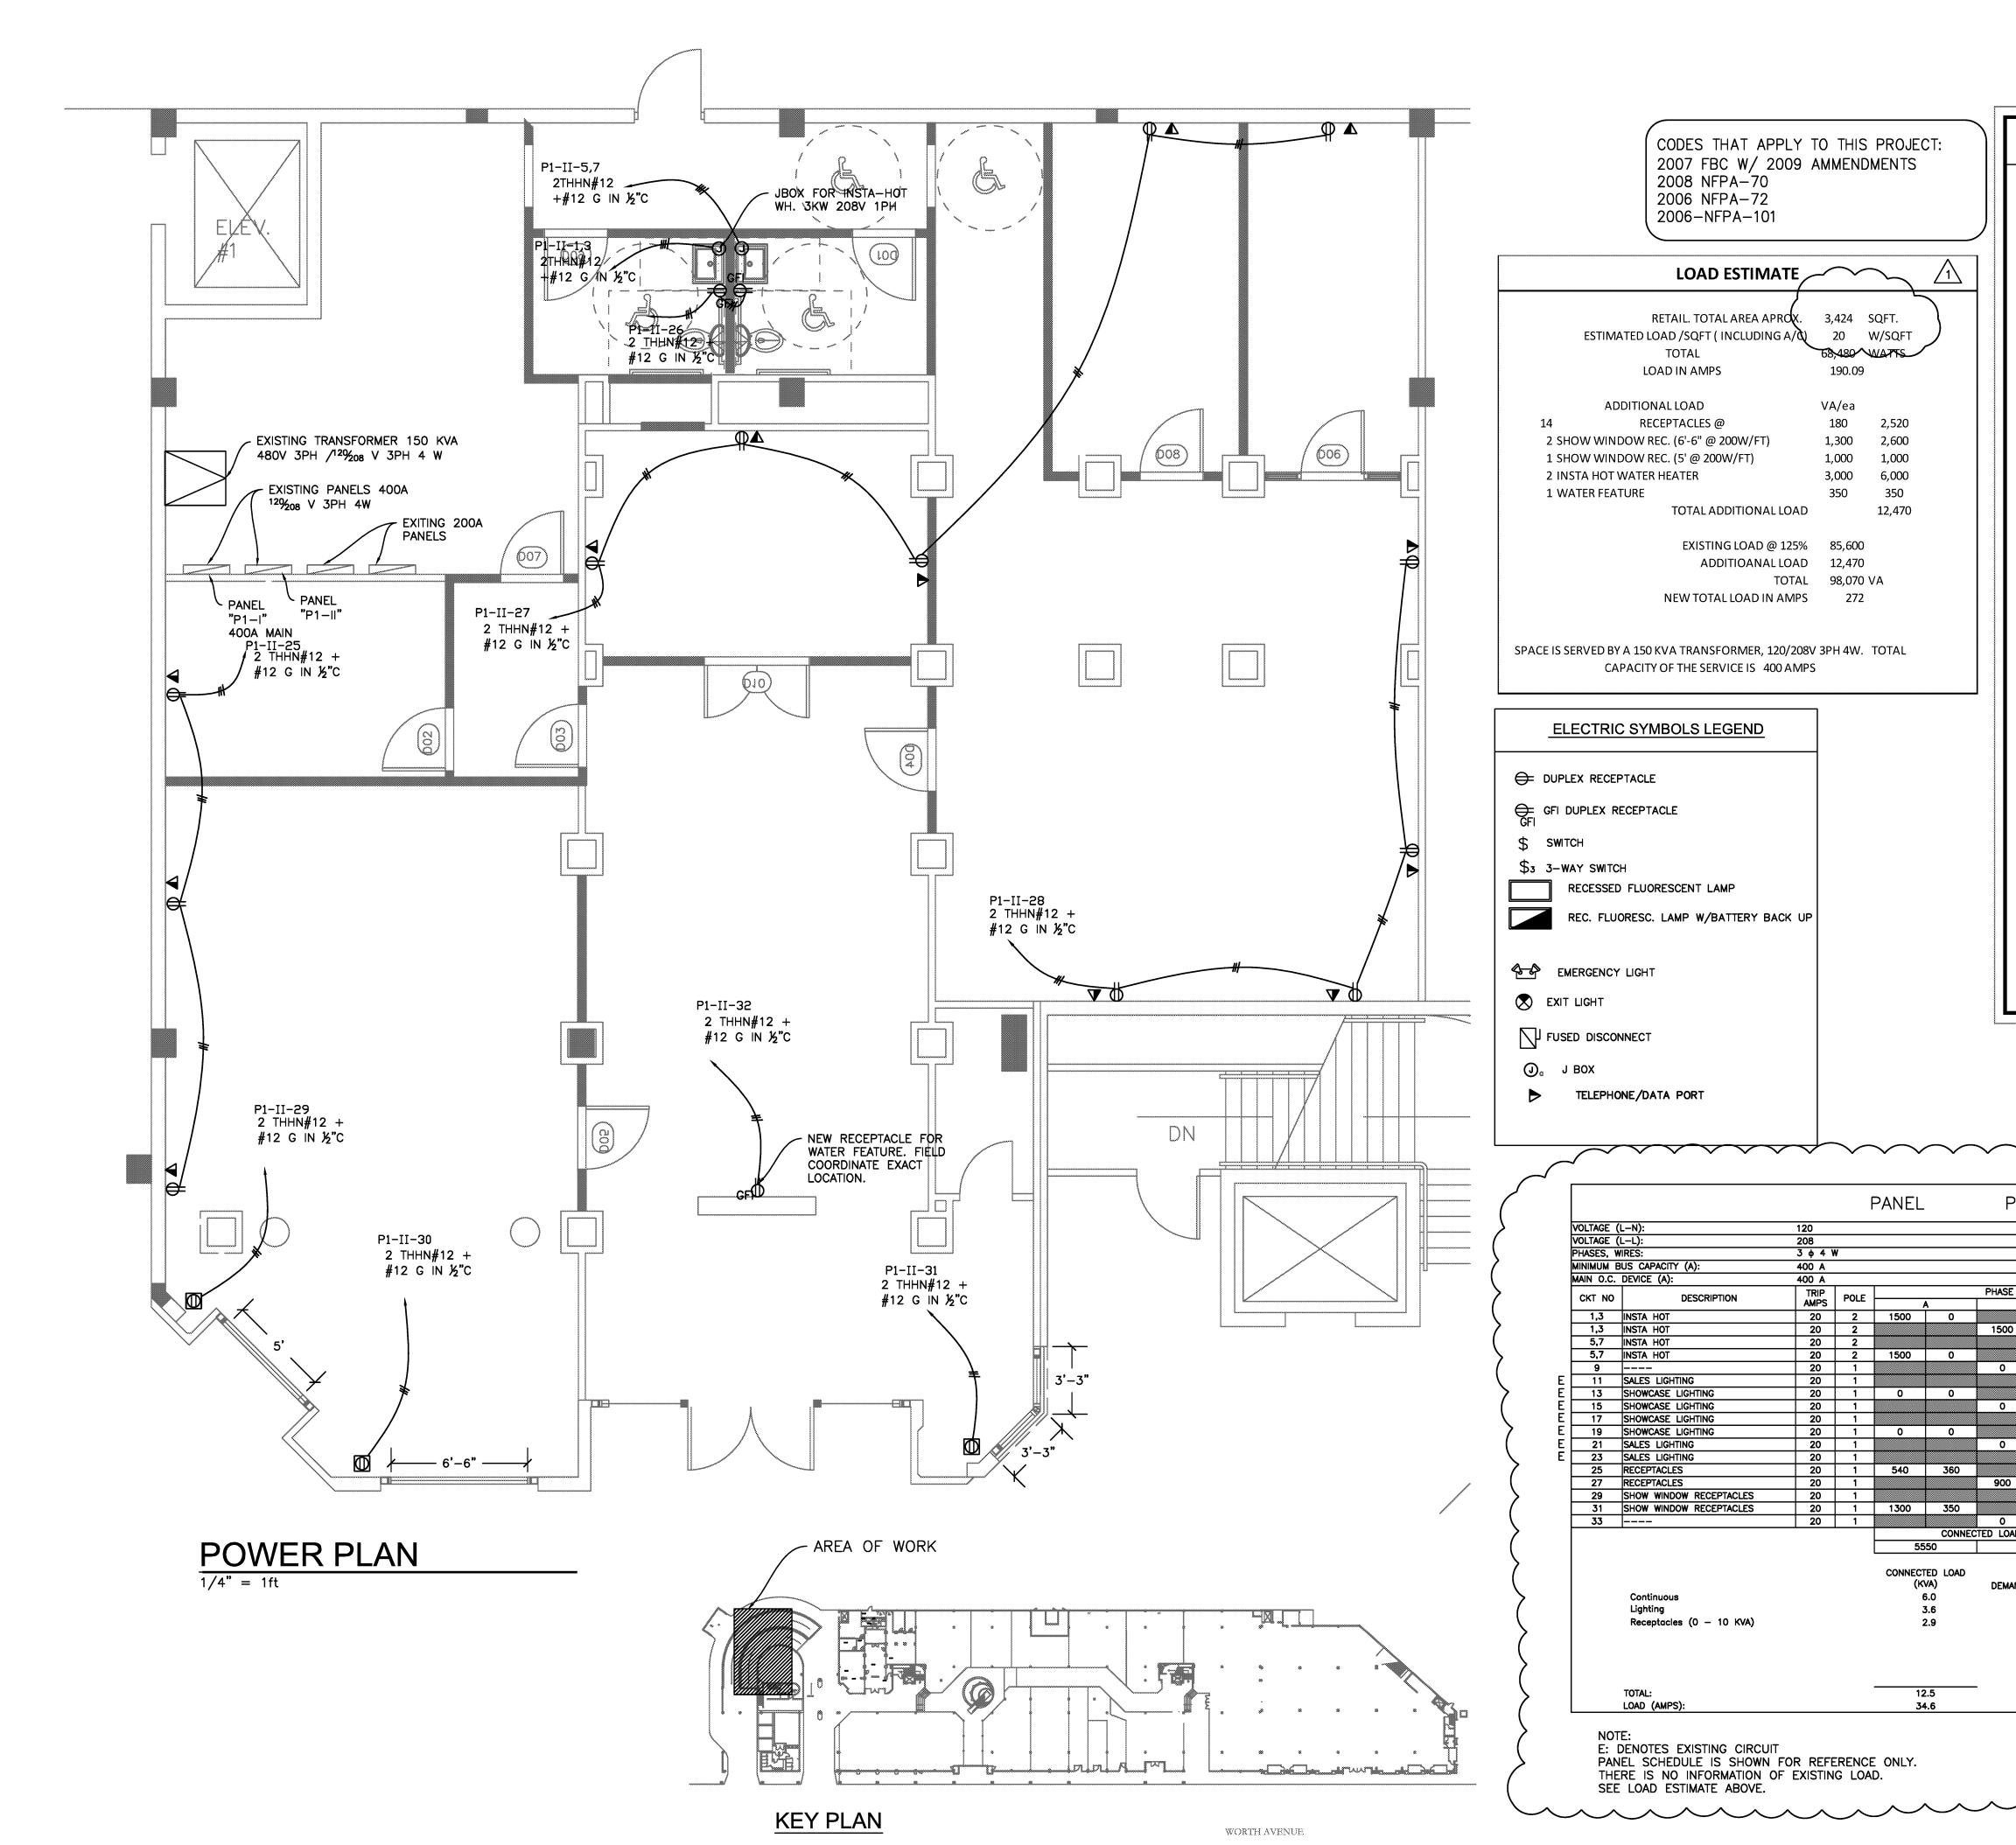



ELECTRICAL NOTES

- SCOPE OF WORK INCLUDES FURNISHING AND INSTALLING FIRST-CLASS WORKING SYSTEMS, TESTED READY FOR OPERATION. COMPLETE WITH LABOR, MATERIALS, APPARATUS, TRANSPORTATION AND TOOLS REQUIRED FOR THE INSTALLATION IN CONFORMANCE WITH DRAWINGS AND SPECIFICATIONS.
- ALL WORK SHALL BE PERFORMED BY A LICENSED ELECTRICAL CONTRACTOR IN A FIRST CLASS WORKMANLIKE MANNER. THE COMPLETED SYSTEM SHALL BE FULLY OPERATIVE AND ACCPETED BY ENGINEER / ARCHITECT.
- COMPLY WITH ALL APPLICABLE CODES AND ORDINANCES. ALL ELECTRICAL WORK SHALL BE IN ACCORDANCE WITH THE NATIONAL ELECTRICAL CODE (NEC), UL AND ALL LOCAL CODES HAVING JURISDICTIONAL AUTHORITY.
- ELECTRICAL CONTRACTOR SHALL VISIT JOB SITE AND FAMILARIZE HIMSELF WITH ALL CONDITIONS AFFECTING ELECTRICAL AND COMMUNICATIONS INSTALLATION AND MAKE PROVISIONS AS TO THE COST THEREOF. EXISTING CONDITIONS OF ELECTRICAL EQUIPMENT, LIGHT FIXTURES, ETC ... THAT ARE PART OF THE FINAL SYSTEM SHALL BE VERIFIED BY THE CONTRACTOR PRIOR TO SUBMITTING HIS BID.
- DO NOT SCALE THE ELECTRICAL DRAWINGS. REFER TO ARCHITECTURAL PLANS AND ELEVATIONS FOR EXACT LOCATION OF ALL EQUIPMENT. CONFIRM WITH OWNER'S REPRESENTATIVE. IT IS NOT THE INTENT OF THESE PLANS TO SHOW EVERY MINOR DETAIL OF CONSTRUCTION. THE CONTRACTOR IS EXPECTED TO FURNISH AND INSTALL ALL ITEMS FOR A COMPLETE ELECTRICAL SYSTEM AND PROVIDE ALL REQUIREMENTS FOR EQUIPMENT TO BE PLACED IN PROPER WORKING ORDER.
- COORDINATE WORK CLOSELY WITH ALL TRADES. CONSULT PLANS OF ALL OTHER TRADES FOR COORDINATION AND FOR RELATED AND ADJOINING WORK. ALL ELECTRICAL POWER WIRING FOR THE HVAC SYSTEM INCLUDING WIRING THRU LINE VOLTAGE CONTROL DEVICES SHALL BE THE RESPONSIBILITY OF THE ELECTRICAL CONTRACTOR. REFER TO MECHANICAL DRAWINGS FOR EXACT LOCATION OF ALL MECHANICAL EQUIPMENT.
- REFER TO PLUMBING DRAWINGS FOR EXACT LOCATION OF ALL PLUMBING EQUIPMENT. ALL MATERIALS SHALL BE NEW AND BEAR UNDERWRITERS' LABELS WHERE APPLICABLE. a. CURRENT CARRYING BUSES SHALL BE COPPER. GROUND BUS BARS SHALL BE COPPER. b. PLUG-IN BREAKERS ARE ACCEPTABLE. c. CIRCUIT BREAKERS USED AS SWITCHES IN FLOURESCENT OR HID LIGHTING CIRCUITS SHALL BE LISTED
- AND MARKED "SWD" d. ALL CIRCUIT BREAKERS FEEDING MECHANICAL EQUIPMENT SHALL BE HACR TYPE.
- e. A.I.C. RATINGS SHALL BE AS INDICATED ON PANELBOARD SCHEDULES f. ALL PANELBOARDS SHALL BE FURNISHED WITH PLASTIC LAMINATE NAMEPLATES WITH 1/4" ENGRAVED
- LETTERING FOR PANEL IDENTIFICATION. g. ALL PANELBOARDS SHALL BE PROVIDED WITH TYPE-WRITTEN DIRECTORY OF BRANCH CIRCUIT DESIGNATIONS.
- D. CONTRACTOR SHALL BE RESPONSIBLE FOR ALL CUTTING AND PATCHING REQUIRED OF HIS WORK. 10.ALL ELECTRICAL AND COMMUNICATIONS OUTLETS TO BE AT 16" A.F.F. TO TOP OF BOX, AND UNLESS NOTED OTHERWISE, VERTICALLY MOUNTED. 11. ALL LIGHT SWITCHES TO BE AT 48" A.F.F. TO TOP OF BOX.
- 12.OUTLET BOXES SHALL BE PRESSED STEEL IN DRY LOCATIONS, CAST ALLOY WITH THREADED HUBS IN WET OR DAMP LOCATIONS. 13.ALL WIRING SHALL BE IN EMT CONDUIT, MINIMUM SIZE 1/2 INCH WITH LARGER SIZES AS INDICATED OR
- REQUIRED BY NEC. ALL CONDUITS IN WET OR DAMP LOCATIONS SHALL BE RIGID GALVANIZED STEEL. ALL OTHERS MAY BE EMT UNLESS OTHERWISE INDICATED. a. AT THE OPTION OF THE CONTRACTOR, AND IF LOCAL AUTHORITY HAVING JURISDICTION ALLOWS THE USE OF FLEXIBLE METAL CONDUIT, ARMORED CABLE, OR METAL-CLAD CABLE, THEN THE
- CONTRACTOR MAY USE THIS WIRING METHOD IN COMPLIANCE WITH APPLICABLE CODES. FOR CIRCUITS 20 AMPERES OR LESS AND CONCEALED IN WALLS OR ABOVE SUSPENDED CEILING. b. USE MAXIMUM 6 FOOT LENGTHS OF FLEXIBLE CONDUIT FOR FINAL CONNECTIONS TO LUMINAIRES, FOR EQUIPMENT SUBJECT TO VIBRATION, NOISE TRANSMISSION, OR MOVEMENT, AND FOR ALL MOTORS. USE LIQUIDTIGHT TYPE IN WET OR DAMP LOCATIONS. INSTALL SEPERATE GROUND CONDUCTOR ACROSS FLEXIBLE CONNECTIONS.
- 14.WIRE SHALL BE COPPER, 600 VOLT INSULATION, MINIMUM AWG. #12, TYPE THW, THWN, THHN, OR XHHW, AS APPLICABLE. SIZES SHALL NOT BE LESS THAN INDICATED. BRANCH CIRCUIT CONDUCTORS SHALL NOT BE SMALLER THAN #12 AWG.. CONDUCTOR FOR BRANCH CIRCUITS OF 120 VOLTS MORE THAN 100 FEET LONG AND OF 277 VOLTS MORE THAN 230 FEET LONG, FROM PANEL TO LOAD, SHALL NOT BE SMALLER THAN #10 AWG. THE CONTRACTOR SHALL CONFIRM WITH THE ELECETRICAL UTILITY COMPANY ANY AND ALL REQUIREMENTS
- SUCH AS: METERING EQUIPMENT REQUIREMENTS AND METERING EQUIPMENT LOCATION, TRANSFORMER SIZE AND LOCATION OR SERVICE POINT. CONDUIT ENTRY AND LUG SIZE RESTRICTIONS. THE CONTRACTOR SHALL SCHEDULE ALL REQUIRED DOWN TIME FOR THE OWNERS CONFIRMATION.
- 16.ANY CONFLICTS AND DESCREPANCIES SHALL BE BROUGHT TO THE ATTENTION OF THE ENGINEER BEFORE PROCEEDING WITH ANY WORK.

ENCLOSUF			NEMA 1			
MOUNTING			SURFACE	.		
AIC RATIN			10000	•		
IOTES:						
ADS (VA)				TRIIP		
		С	POLE	AMPS	DESCRIPTION	CKT NO
			2	20	A/C (EXISTING)	2,4
0			2	20	A/C (EXISTING)	2,4
	1500	0	1	20		6
			1	20		8
0			1	20		10
	0	0	1	20	EXISTING FANS	12
			1	20	SHOWCASE LIGHTING	14
0			1	20	SHOWCASE LIGHTING	16
	0	0	1	20	SPACE	18
			1	20	STOCK ROOM LTS.	20
0		•	1	20		22
	0	0	1	20		24
700			1	20	GFI RECEPTACLES	26
720	1000	1300	1	20 20	RECEPTACLES SHOW WINDOW RECEPTACLES	28
	1000	1300	1	20	WATER FEATURE	30
				20		52
SE TO	TALS (VA)					
		300	1			
CTOR	•	.0AD (KVA) 7.5 4.5 2.9			DEMAND LOAD14.9 KVASPARE CAPACITY129.2 KVASPARE CAPACITY358.7 AMPSSPARE CAPACITY90 %PHASE BALANCE4 TO BA TO B56 %B TO C82 %C TO A68 %	
		4.9 1.3	-			

743 BISCAYNE DRIVE WEST PALM BEACH, FLORIDA 33401 561.659.5683

STEPHEN MICHAEL ROY AIA, NCARB FLORIDA REGISTERED ARCHITECT AR91404

PROJECT:

SELECTIVE MODIFICATIONS TO

150 WORTH AVE PALM BEACH UNIT 136 FLORIDA 33480

TITLE

FLOOR PLAN


DRAWING INFO		
DATE	11-10-11	
SCALE	VARIES	
DESIGNED BY	MESA	
DRAWN BY	MESA	
PROJECT #	111608	

REVISIONS AND ISSUE

NO.	DATE	ISSUE NOTE		
	6/7/11	GENERAL REVISION		
NO.	DATE	REVISION NOTE		
OWNERSHIP AND USE OF THESE DOCUMENTS & SPECIFICATIONS AS INSTRUMENTS OF SERVICE ARE AND SHALL REMAIN THE PROPERITY OF THE ARCHITECT WHETHER THE PROJECT THEY ARE MADE FOR IS EXECUTED OR NOT. THEY SHALL NOT BE USED BY THE OWNER OR OTHERS ON OTHER PROJECTS OR FOR ADDITIONS ON OTHER PROJECTS				


BY OTHERS, EXCEPT BY AGGREEMENT IN WRITING WITH ARCHITECT

SEAL:

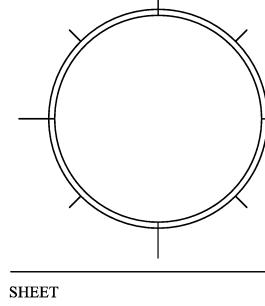

OF: 27

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743 BISCAYNE DRIVE WEST PALM BEACH, FLORIDA 33401 561.659.5683

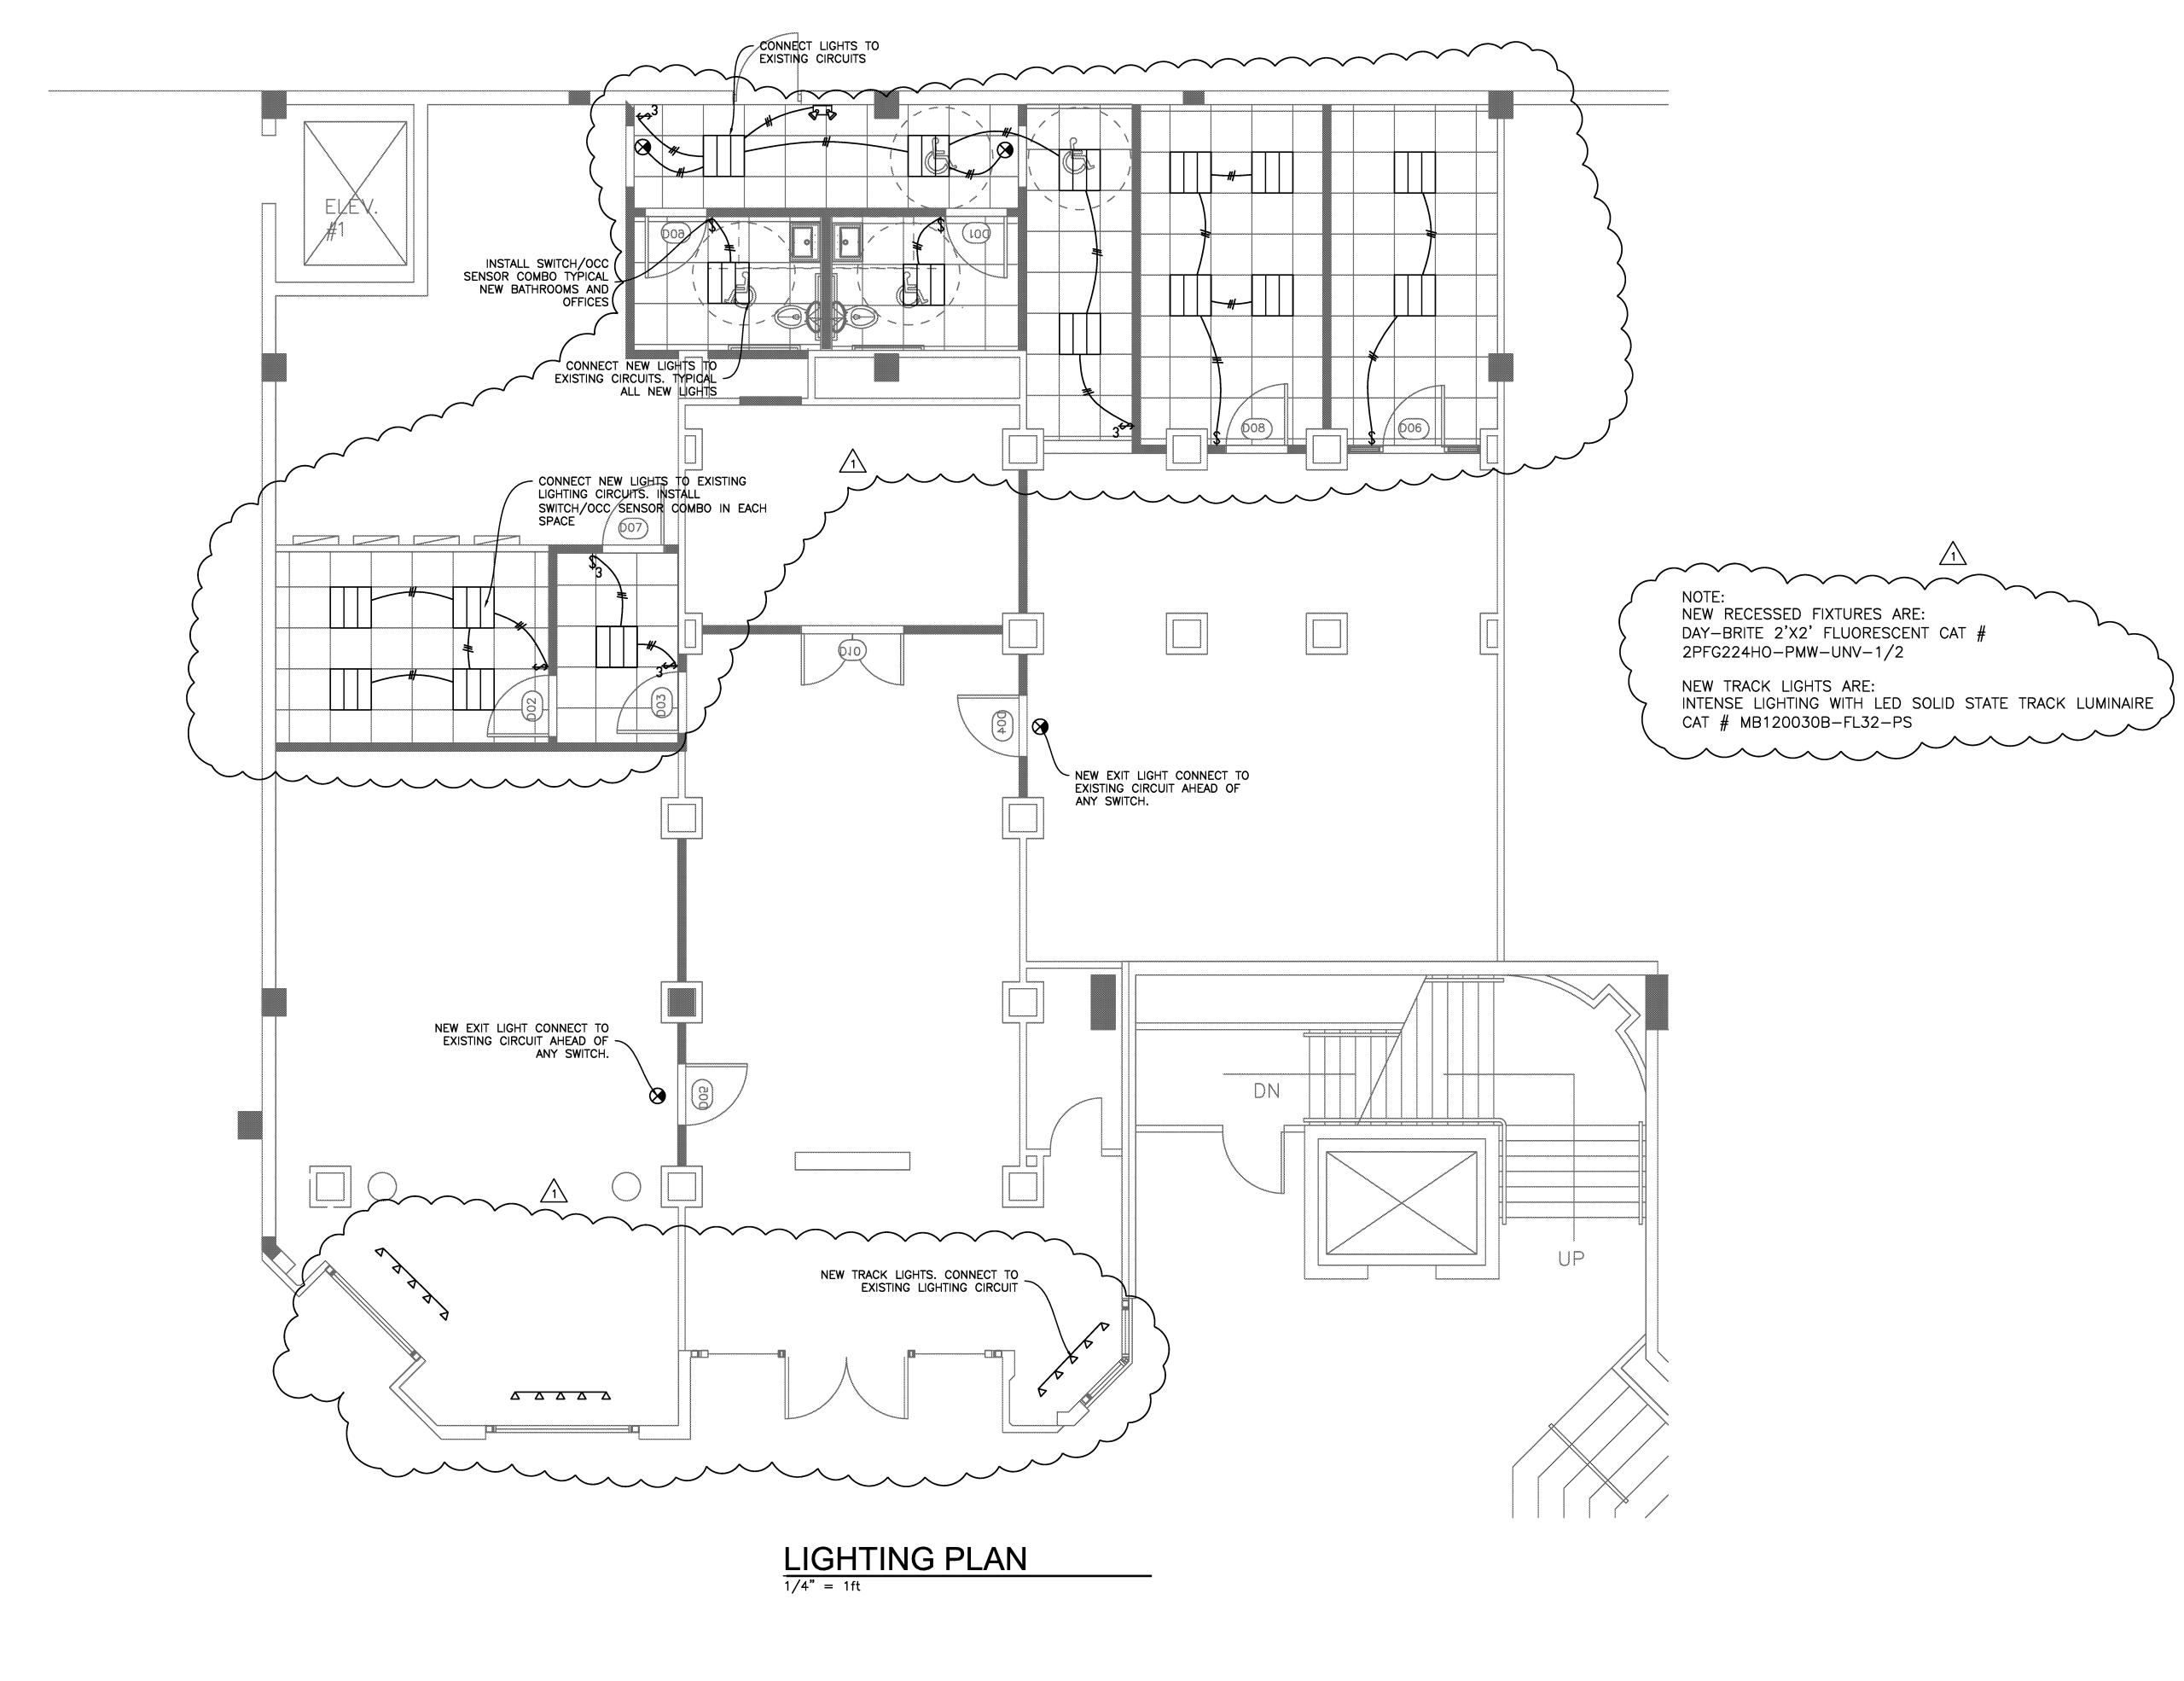STEPHEN MICHAEL ROY AIA, NCARB FLORIDA REGISTERED ARCHITECT AR91404

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TITLE


FLOOR PLAN

DRAWING INFO		
DATE	11-10-11	
SCALE	VARIES	
DESIGNED BY	MESA	
DRAWN BY	MESA	
PROJECT #	111608	

REVISIONS AND ISSUE

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E2

SHEET

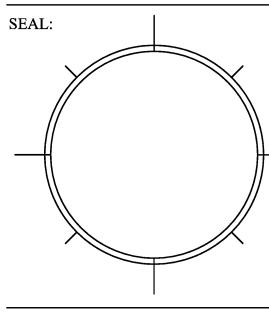

MESA ARCHITECTURE, INCORPORATED

743 BISCAYNE DRIVE WEST PALM BEACH, FLORIDA 33401 561-659-5683

RFI 136

- 1. To what extent is the space getting painted? PAINT ENTIRE SPACE AND CEILING. WALLS ANTIQUE WHITE FLAT, CEILING WHITE FLAT. TRIM AND DOORS SEMIGLOSS BM DOVE WHITE
- 2. Are the walls to be built to the existing ceiling or are they to pass through the existing ceiling and the ceiling patched up to the new wall. WALLS SHALL EXTEND 6" ABOVE CEILING. BRACE TO STRUCTURE @ 48" O.C. SEE SHEET A1
- 3. Is the flooring being removed? Replaced? If it is removed will the wood flooring under the carpet also be removed? WOOD FLOORING SHALL BE PATCHED/ REPAIRED. SAND, STAIN AND PROVIDE FINISH COAT OF POLYURETHANE. HONEY OAK COLOR
- 4. Note 2 on A2 references a reflected ceiling plan on page 2.3. we did not receive a page 2.3. SEE ATTACHED NO 2.3
- 5. There are 2 pages labeled A2 SEE CORRECTED
- 6. Who is providing the "self contained water feature" **BY OTHERS**
- 7. Will an electrical floor box be required at the water feature location? SEE ELECTRICAL
- 8. The gross area is stated as 3424 on the floor plan on A2 but only 3253 on the load calculations, which of these numbers is accurate. SEE CORRECTED ELECTRICAL PLAN
- 9. Sheet e-1 Shows work area in the parking garage area. SEE CORRECTED PLAN
- 10. The Pocket doors indicated on sheet a-2 are not shown on the door schedule. What is required for these doors? SEE REVISED DRAWING.
- 11. The walls shown with the pocket doors are shown as new but are not shown as being demo'ed. Are these new walls? SEE REVISED PLAN
- 12. The note 4-S1 should be corrected before permitting. NOTED
- 13. Note 3-S1 indicates an additional 4x4x1/2 steel column not shown elsewhere on the plan. Please clarify this detail. PLEASE CLARIFY QUESTION
- 14. There are no light fixture models/catalog numbers listed. SEE ELECTRICAL PLAN
- 15. There is no electrical panel schedule on the plan. CONTRACTOR SHALL PROVIDE
- Will a temporary wall be required to run from floor to ceiling along the front of the store? YES PB GREEN AS APPROVED BY THE TOWN OF PALM BEACH

Please provide specifications for light fixtures Will any shoring be required prior to the removal of the existing storefront assembly? NO. PLEASE V.I.F. PRIOR TO DEMOLITION

UNIT 219 AND 225

- 1. To what extent is the flooring being removed? Replaced?INTERIOR FLOOR SHALL BE PROTECTED AND PATCHED IF REQUIRED. NEW EXTERIOR AREA SHALL RECEIVE WATERPROOFING AND TERRA-COTTA TILE TO MATCH EXISTING 2/A1
- 2. To what extent are the spaces being painted? PAINT ENTIRE SPACE AND CEILING. WALLS ANTIQUE WHITE FLAT, CEILING WHITE FLAT. TRIM AND DOORS SEMIGLOSS BM DOVE WHITE
- 3. Are there any new lights going back in the new exterior stucco soffit? **PROVIDE J BOX**
- 4. What finish and hardware is to be used for the new storefront windows/doors? **SEE ADDED INFORMATION ON DRAWING**
- 5. Will space 219 be occupied when this work is going on? YES
- 6. Page A-1 states that entry doors are new and also states that "entry doors are to remain undisturbed". Are the entry doors being replaced? REMOVE AND REPLACE
- 7. Note 1 S1 shows "Option 2" what is "Option 1"? SEE CORRECTED PLAN

A detail note on s1 states we are to Fill the space between the window and buck with foam and provide "Protecto Wrap" Are we to wrap all columns with "Protecto Wrap" from floor to ceiling? STUCCO VENEER OVER PAPERBACKED WIRE LATH OVER 30 LB FELT OVER 5/8" DENSGLASS GOLD OVER METAL FRAMING. PROTECTO WRAP OR EQUAL SALL EXTEND UP COLUMN 12" What product are we to use? "Protecto Wrap" is a name brand.

Will a pedestrian barrier be required? YES PB GREEN AS APPROVED BY THE TOWN OF PALM BEACH

Provide specifications on the terra-cotta allowance. MATCH EXISTING

- Sheet m1, key plan notes #5 & #6 refer to demoed ceiling, however no demoed plans are included. SEE ARCHITECTURAL
- Sheet A0 indicates to remove and replace the existing storefront system, however, no information is provided for the new system with the exception of the wind design criteria. Please provide specifications. SEE REVISED DRAWINGS
- Their is no demolition plan associated with the removal of the storefront system and associates components. Will any shoring be required prior to the removal of the existing storefront assembly? SEE DEMO PLAN SHEET A1

22 GAUGE IS ACCEPTABLE FOR EXTERIOR METAL FRAMINGH