

ALAN STRASS
ARCHITECTS, INC.
8895 NORTH MILITARY TRAIL, SUITE 20'
PALM BEACH GARDENS, FLORIDA
(561) 627–0336 FAX (561) 624–

5

LOT #7 FLORIDA

AL TECHNOLOGY PRODUCTS Park RIVIERA BEACH , F


MEDICAL T HAVERHILL BUSINESS PARK HAVERHILL ROAD ME SITE PLAN

DAGE10 DRAWN BY: AIC PROJ. NO. 10025 REVISED:

]

SHEET:

SEAL

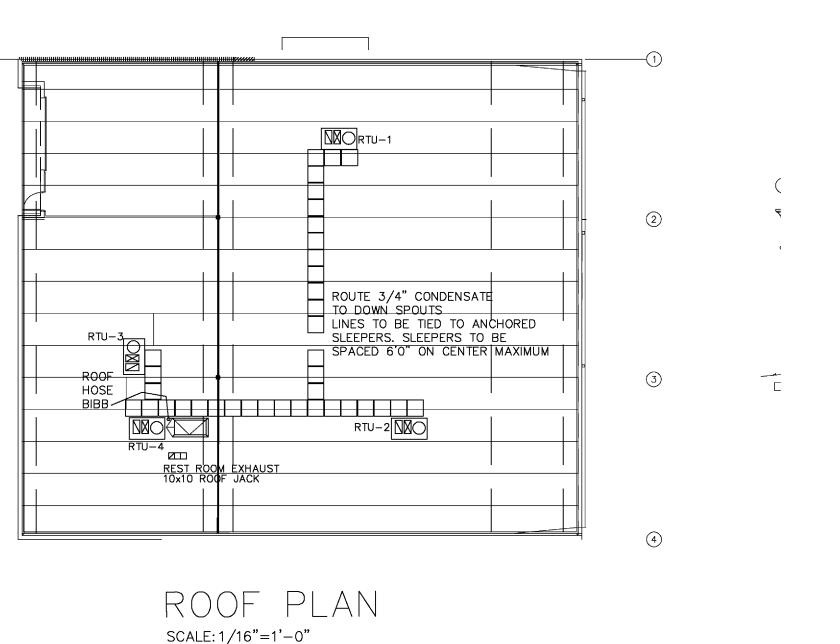

24X24 CD 6"0 NK 75 CFM

OFFICE DUCTWORK
OFFSET ABOVE FUTURE
CEILING LINE FROM RTU
#3 — CENTERED ON
FLOOR JOISTS W/ FIRE
DAMPERS AT FLOOR
PENETRATIONS

-- 6"ø EACH EF TO 10X10 TO ROOF JACK

24X24 CD 6"ø 6"ø NK 100 CFM

OFFICE HVAC PLAN

8"ø NK 210 CFM

10"ø 20X14 24X24 CD 20x16 9"ø NK JOIST 245 CFM OPENING


18X18 NK

SCALE: 1/8"=1'-0"

24X24 CD TRANS.GRILLE 8"ø DUCT

> 24X24 CD 7"ø NK

140 CFM 🔽

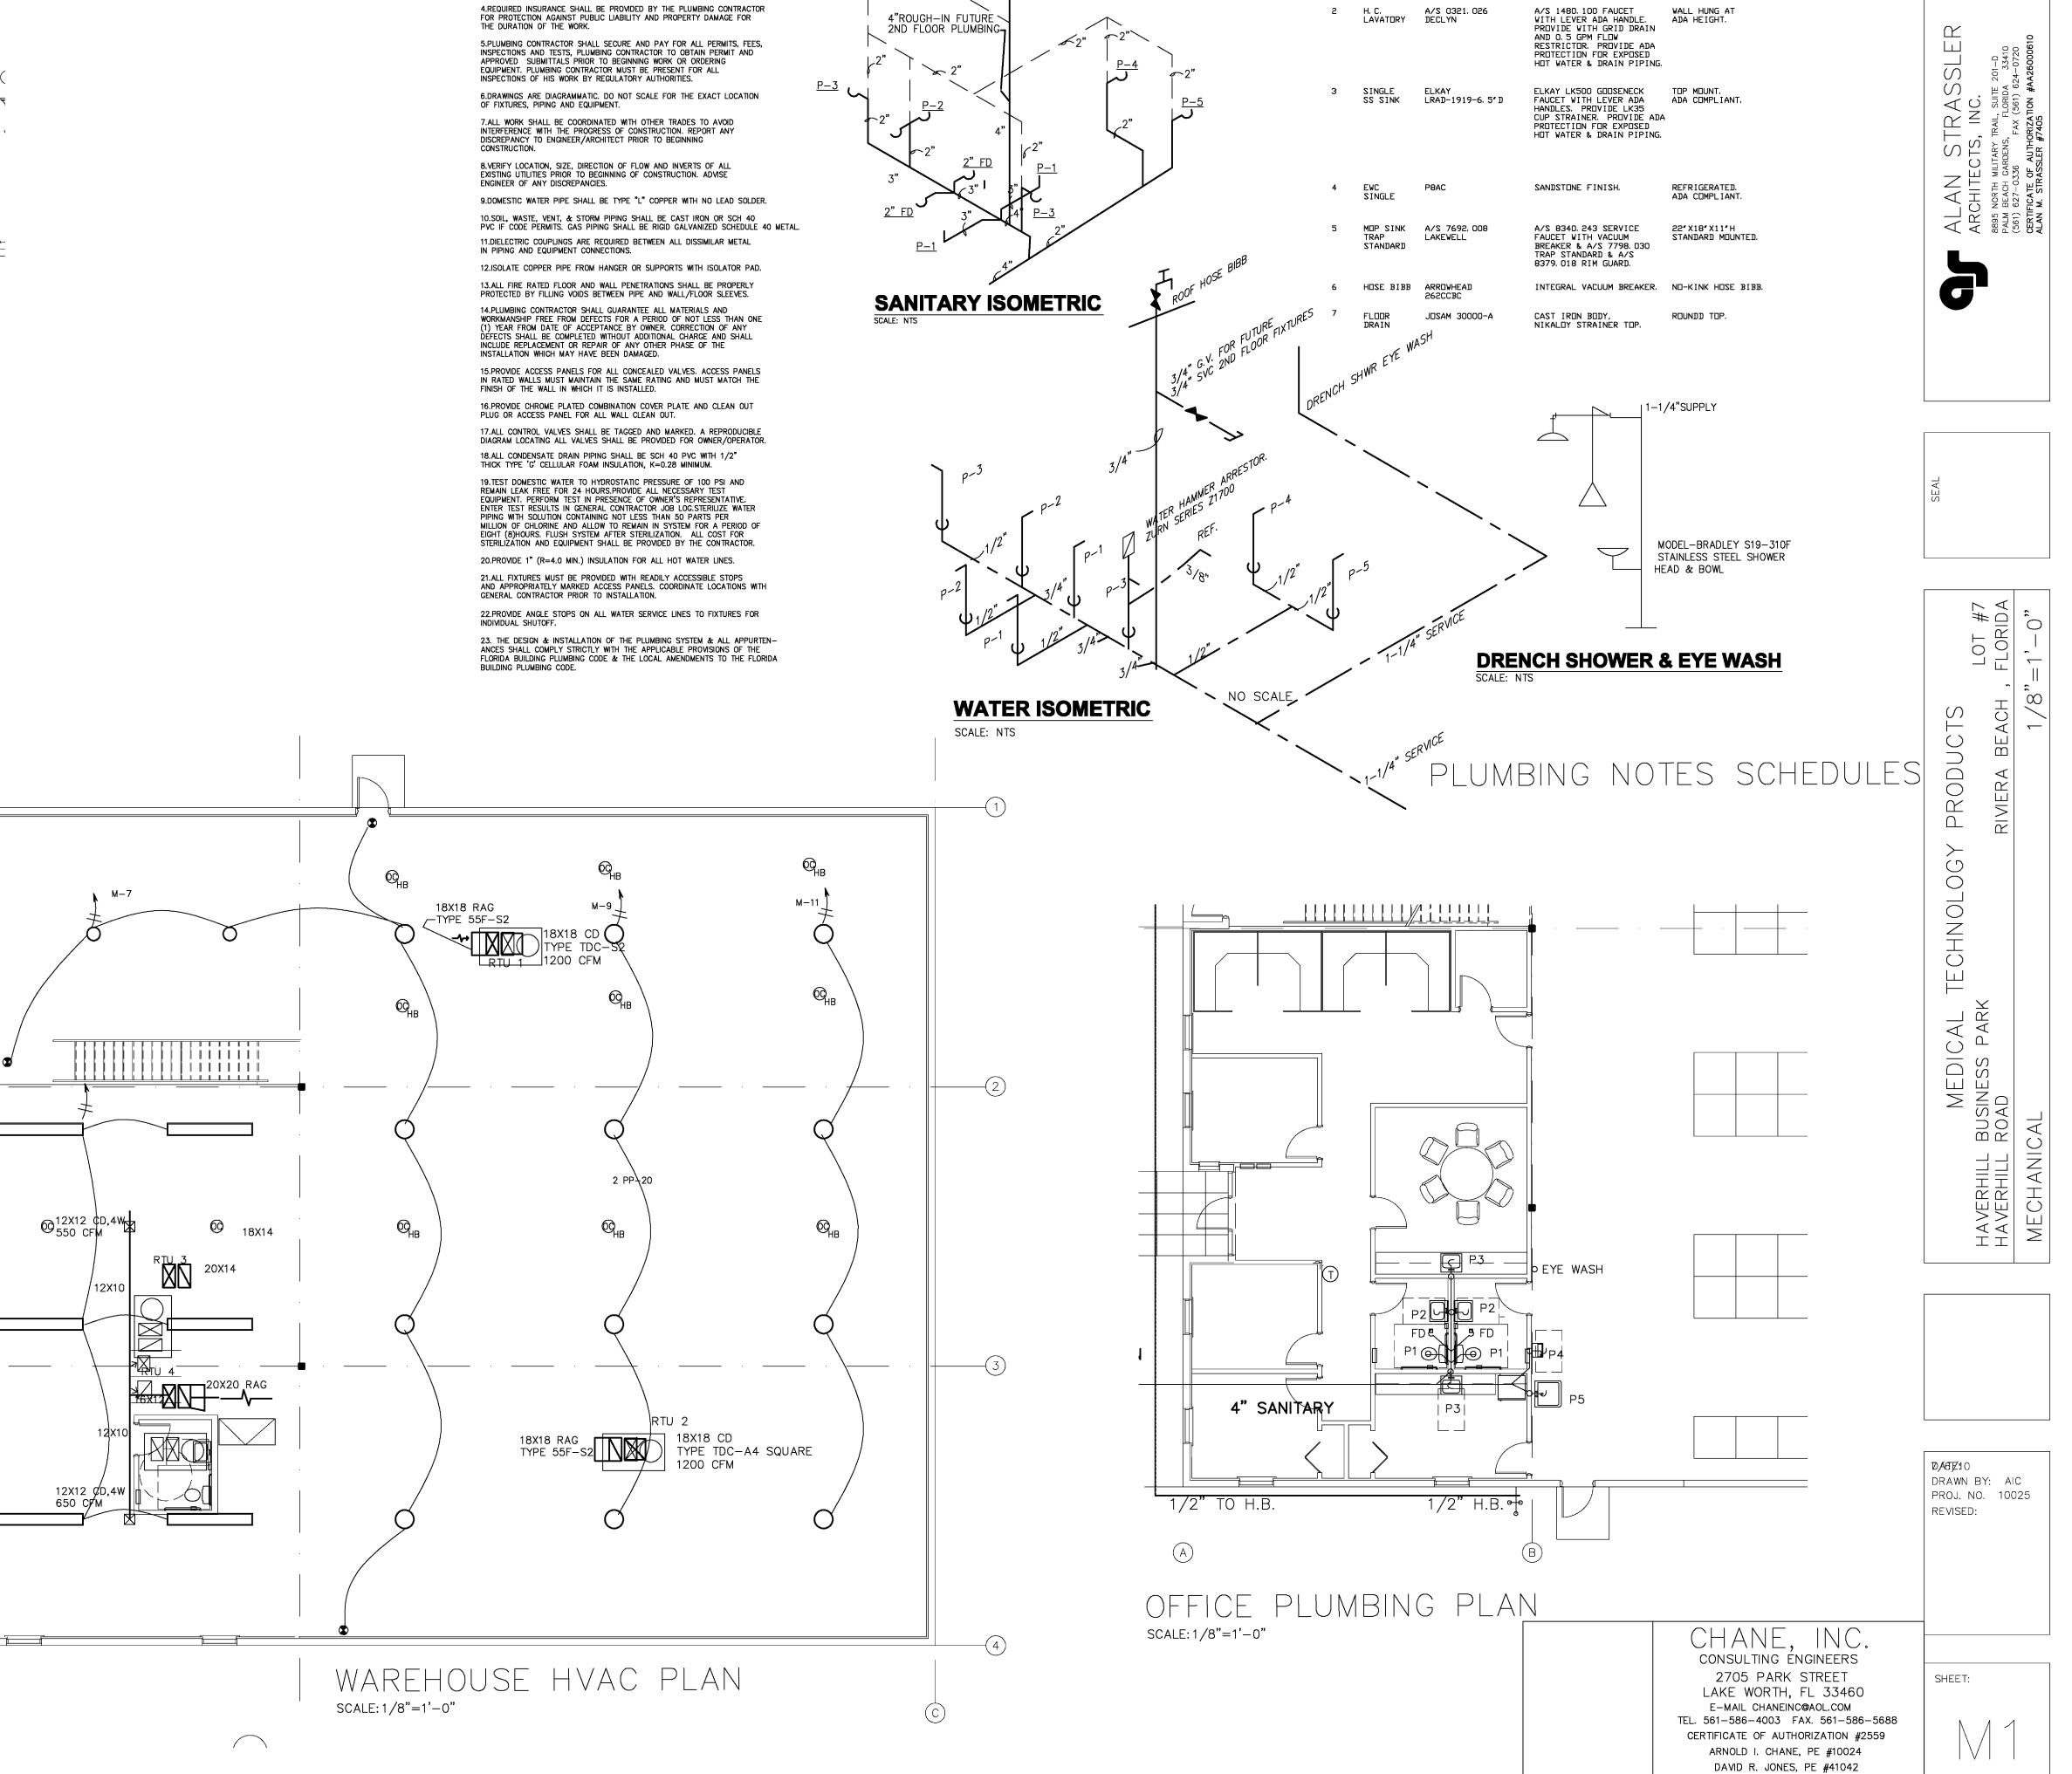

PLUMBING FIXTURE SCHEDULE

REMARKS

HANDICAP 16.5″ HIGH.

HOWARD L. CHANE, PE #22467

SEAL

OPEN FRONT SEAT, ELONGATED BOWL,

MARK FIXTURE DESCRIPTION

1 H. C. W. C. A/S 2386, 010 CADET-3 1, 6 GPF

PLUMBING NOTES

3.ALL MATERIALS SHALL BE NEW.

1.ALL WORKMANSHIP AND MATERIALS SHALL BE IN STRICT ACCORDANCE

2.PLUMBING CONTRACTOR SHALL VISIT THE JOB SITE AND THOROUGHLY FAMILIARIZE HIMSELF WITH ALL EXISTING CONDITIONS.

WITH APPLICABLE LOCAL CODES, RULES AND ORDINANCES.

GENERAL MECHANICAL NOTE

1.VISIT THE SITE BEFORE SUBMITTING A BID. DETERMINE THE CHARACTERISTICS OF EXISTING FACILITIES WHICH WILL AFFECT PERFORMANCE OF THE WORK, BUT WHICH ARE NOT SHOWN ON THE DRAWINGS OR THE SPECIFICATIONS.

2.SHOP DRAWINGS OR FULLY DESCRIPTIVE CATALOG DATA SHALL BE SUBMITTED BY THE CONTRACTOR FOR ALL KINDS OF MATERIAL AND EQUIPMENT FURNISHED AND INSTALLED UNDER THIS CONTRACT. THE CONTRACTOR SHALL SUBMIT TO THE ARCHITECT A SUFFICIENT NUMBER OF COPIES OF ALL SUCH SHOP DRAWINGS OR CATALOG DATA TO PROVIDE HIM WITH AS MANY REVIEWED COPIES AS HE MAY NEED, PLUS TWO (2) COPIES FOR RETENTION BY THE ARCHITECTS AND ENGINEERS.

3.ALL CUTTING, PATCHING, STRUCTURAL STEEL, WEATHER PROOFING, PAINTING, AND WALL OPENINGS SHALL BE BY THE GENERAL CONTRACTOR.

4.ALL OPENINGS IN BUILDING STRUCTURE, FOR DUCTWORK, PIPING, ETC. TO BE 1/2" LARGER (ON ALL SIDES) THAN THE OUTSIDE DIMENSIONS. FILL VOIDS WITH FIRE RETARDANT SILICONE FOAM (I.E. CHASE—FOAM CTC PR—855 BY CHASE TECHNOLOGY CORP.).

5.CONTRACTOR SHALL GUARANTEE ALL MATERIALS AND WORKMANSHIP FREE FROM DEFECTS FOR A PERIOD OF NOT LESS THAN ONE (1) YEAR FROM DATE OF ACCEPTANCE. CORRECTION OF ANY DEFECTS SHALL BE COMPLETED WITHOUT ADDITIONAL CHARGE AND SHALL INCLUDE REPLACEMENT OR REPAIR OF ANY OTHER PHASE OF THE INSTALLATION WHICH MAY HAVE BEEN DAMAGED.

GENERAL HVAC NOTES

1.VISIT THE SITE PRIOR TO SUBMITTING A BID. DETERMINE THE CHARACTERISTICS OF EXISTING FACILITIES WHICH WILL AFFECT PERFORMANCE OF THE WORK, BUT WHICH ARE NOT SHOWN ON THE DRAWINGS.

2.PROVIDE ALL LABOR PERMITS, MATERIAL, TOOLS, SUPPLIES, EQUIPMENT TO INSTALL A COMPLETE AND OPERATING AIR CONDITIONING SYSTEM. INSTALLATION SHALL BE IN ACCORDANCE WITH LOCAL CODES.

3.PAY ALL COSTS OF PERMIT INSPECTIONS AND ALL OTHER COSTS INCIDENTAL TO THE COMPLETION AND TESTING OF THIS WORK.

4.CONTRACTOR SHALL SUBMIT, FOR APPROVAL FIVE [5] COPIES OF MANUFACTURERS DRAWINGS FOR EACH PIECE OF EQUIPMENT AND CONTROLS INCLUDED IN CONTRACT.

5.ALL CONDITIONED AIR DUCTWORK SHALL BE FIBERGLASS, R=6.0 MIN. ALL EXHAUST & OUTSIDE AIR DUCTWORK SHALL BE GALVANIZED STEEL. ALL BENDS SHALL HAVE TURNING VANES. CONTRACTOR SHALL VERIFY ALL CLEARANCES AND ADJUST FOR FIELD CONDITIONS PRIOR TO CONSTRUCTING ANY DUCTWORK. ALL DUCT SIZES ARE CLEAR INSIDE DIMENSIONS. INSTALL ALL DUCTWORK PER APPROPRIATE SMACNA STANDARD.

6.THE CONTRACTOR SHALL FURNISH A WRITTEN WARRANTY THAT SHALL GUARANTEE ALL WORKMANSHIP AND MATERIALS FOR ONE (1) YEAR FROM THE DATE OF FINAL ACCEPTANCE BY THE ARCHITECT. ANY BREAK—DOWN OCCURRING IN THE FIRST YEAR SHALL BE REPAIRED AT NO COST TO THE OWNER. A/C COMPRESSORS SHALL HAVE A 5 YEAR GUARANTEE.

7.PROVIDE & INSTALL ALL CONTACTORS, RELAYS, AND CONTROLS.

8.HVAC CONTRACTOR SHALL PROVIDE A TEST AND BALANCE REPORT FOR ALL MECHANICAL SYSTEMS AND SHALL INCLUDE AIR QUANTITIES FOR ALL SUPPLY GRILLS, RETURN GRILLS, AND EXHAUST GRILLS AND THE LEAVING AND ENTERING AIR TEMPERATURE (F) FROM AT EACH EVAPORATOR COIL. INCLUDE ALL VOLTAGE AND AMPERAGE FOR EACH MOTOR THE REPORT SHALL BE DONE BY AN INDEPENDANT T&B CONTRACTOR LICENSED BY THE STATE OF FLORIDA AND SUBMITTED TO THE ARCHITECT.

9.ALL AIR DEVICES (DIFFUSERS, REGISTERS AND GRILLES) SHALL BE ALL ALUMINUM CONSTRUCTION WITH EXPOSED SURFACE OFF WHITE BAKED ENAMEL FINISH OR AS SPECIFIED BY ARCHITECT. DEVICES SHALL BE TITUS OR METALAIRE.

10.ALL BRANCH TAKE OFFS TO BE PROVIDED W/ MANUAL VOLUME DAMPERS. ALL ELBOWS AND TEES MUST BE FURNISHED W/TURNING VANES. PROVIDE MANUAL VOLUME DAMPERS WITH EXTRACTOR AT ALL FLEX TAKE OFFS.

11.PROVIDE NEW FILTERS FOR ALL AIR HANDLERS BEFORE STARTING THEM. REPLACE FILTERS PRIOR TO FINAL ACCEPTANCE BY OWNER.

12. FIRE DAMPERS SHALL BE STYLE B WITH THE BLADES OUT OF THE AIRSTREAM. DAMPERS FOR RECTANGULAR DUCTS SHALL BE EQUAL TO RUSKIN #D—IBD2 WITH 1 1/2 HOUR RATING & DAMPERS FOR ROUND DUCT SHALL BE EQUAL TO RUSKIN #D—IBD2—CR WITH 1 1/2 HOUR RATING.

13. ALL PENETRATIONS OF FIRE RESISTIVE ASSEMBLIES INCLUDING FLOOR ASSEMBLIES SHALL BE PROTECTED BY AN APPROVED THROUGH STOP ASSEMBLY AND INSPECTED FOR COMPLIANCE PRIOR TO CLOSE IN. THE CONTRACTOR MUST VISIT THE SITE & REVIEW THE ARCHITECTURAL PLANS PRIOR TO BID TO LOCATE ALL NEW FIRE WALLS & ANY EXISTING MECHANICAL DUCTWORK, PIPING, ETC. THAT WILL REQUIRE NEW FIRE DAMPERS OR THROUGH STOPS. ALL COSTS SHALL BE INCLUDED IN THE BID.

14. THE DESIGN & INSTALLATION OF THE MECHANICAL SYSTEMS & ALL APPURTEN—ANCES SHALL COMPLY STRICTLY WITH THE APPLICABLE PROVISIONS OF THE FLORIDA BUILDING MECHANICAL CODE & THE LOCAL AMENDMENTS TO THE FLORIDA BUILDING MECHANICAL CODE.

15.PROVIDE A 10 FOOT MINIMUM CLEARANCE FROM ALL VENTS THROUGH ROOF (VTR) AND EXHAUST FANS TO OUTSIDE AIR INTAKES.

16.ALL STORAGE ROOMS, TOILETS, ETC, WILL HAVE UNDERCUT DOORS TO PROVIDE VENTILATION REQUIRED WHEN DOOR OR TRANSFER GRILLES ARE NOT SHOWN.

17.A/C CONTRACTOR SHALL BE RESPONSIBLE TO COORDINATE HIS WORK FOR SIZE, LOCATION, CLEARANCE, ACCESS AND ELECTRICAL CHARACTERISTICS WITH ALL OTHER TRADES AND TO PROVIDE SHOP DRAWINGS TO THE ENGINEER FOR REVIEW BEFORE INSTALLATION OF DUCTWORK OR EQUIPMENT. SHOP DRAWINGS WILL INCLUDE BEAM OR STRUCTURE ELEVATION & REQUIRED EQUIPMENT ACCESS AREAS.

18.COORDINATE LOCATION OF CEILING DIFFUSERS, GRILLES AND REGISTERS IN THE FIELD WITH LIGHTS AND ARCHITECTURAL ELEMENTS.

19.COORDINATE LOCATION OF AHU'S, THERMOSTATS, FANS AND DUCTWORK WITH BUILDING STRUCTURE AND OTHER TRADES SO THAT NO INTERFERENCES OCCUR.

20.MECHANICAL PLANS IN GENERAL, ARE DIAGRAMMATIC IN NATURE, AND ARE

TO BE READ IN CONJUNCTION WITH ARCHITECTURAL, PLUMBING, ELECTRICAL AND STRUCTURAL PLANS. DUCT BENDS AND TRANSITIONS WILL BE REQUIRED TO PROVIDE AND INSTALL A COMPLETE FUNCTIONAL SYSTEM AND SHALL BE PROVIDED BY THE CONTRACTOR AT NO ADDITIONAL COST TO THE OWNER.

21.FAN DRIVES SHALL BE ADJUSTED TO DELIVER THE SPECIFIED CFM


AGAINST THE ACTUAL STATIC PRESSURE OF THE INSTALLATION.

22.ALL OUTSIDE EQUIPMENT SHALL BE SECURED TO WITHSTAND 140 M.P.H.


23.ALL REFRIGERANT LINES SHALL BE INSTALLED PER MANUFACTURERS RECOMMENDATIONS. MATERIAL SHALL BE TYPE "L" COPPER INSULATED WITH 3/4" ARMAFLEX. EXTERIOR ARMAFLEX SHALL BE COATED PER MANUFACTURERS RECOMMENDATIONS.

24.ALL UNITS SHALL BE PROVIDED W/ HONEYWELL ELECTRONIC PROGRAMMABLE THERMOSTATS.


25.ALL CONDENSATE DRAIN PIPING SHALL BE SCH 40 PVC WITH 1/2"
THICK TYPE 'G' CELLULAR FOAM INSULATION, K=0.28 MINIMUM.

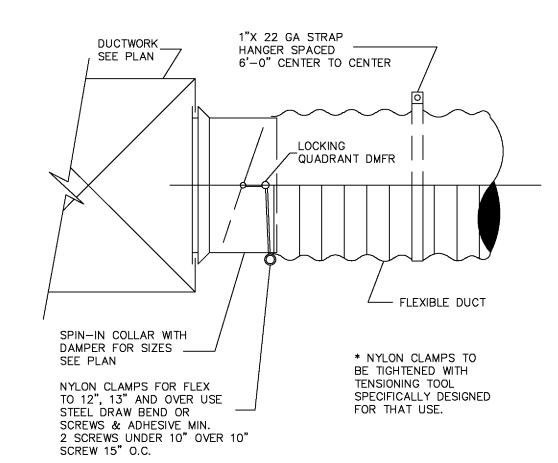


DUCT TAKE-OFF DETAIL - NTS

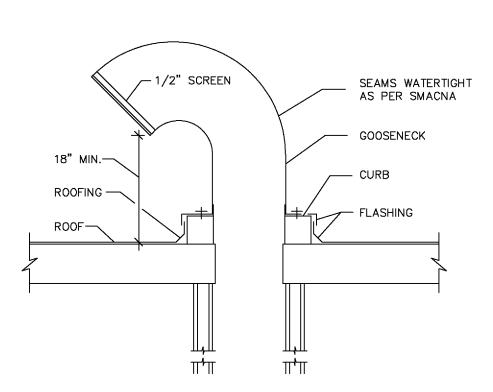

GOOSENECK DETAIL - NTS

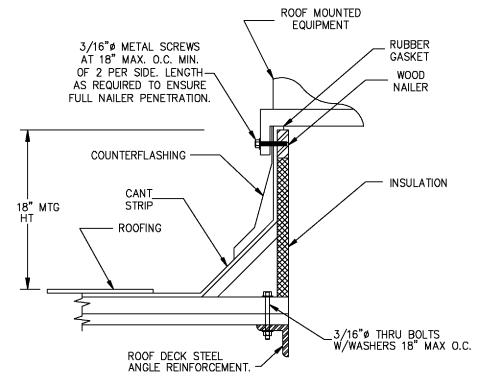

SUPPORT CURB DETAIL- AC ROOF TOPS - NTS

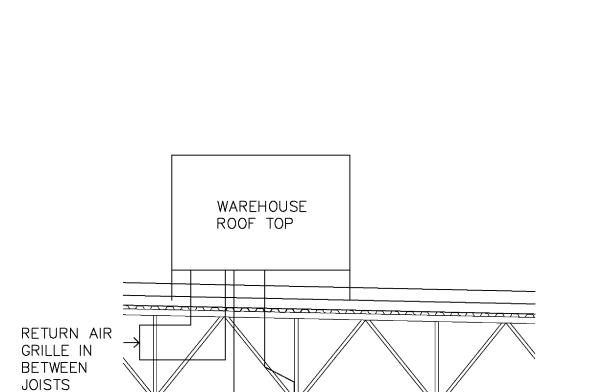

WH RTU SECTION SCALE: 1/4"=1'-0"

DIFFUSER MIN.HEIGHT

MECHANICAL NOTES SCHEDULES DETAILS NO SCALE:

12" ABOVE TOP

PAN TERMINATE

VENT WITH PERFORATED

HANG DUCTS ACCORDING

TYPICAL HANGING

HANGING DETAIL

STRAP AND SADDLE

RTU 1 WAREHOUSE

CFM REQUIRED: 141

CFM SUPPLIED: 150

RTU 2 WAREHOUSE

CFM REQUIRED: 189

CFM SUPPLIED: 200

CFM REQUIRED: 140

CFM SUPPLIED: 140

CFM REQUIRED: 198

CFM SUPPLIED: 200

MEZZANINE-1650 SFx .12 CFM/SF

<u>RTU 3</u>

C.O. PLUG

- RETURN BEND W/C.O.

CONDENSATE PIPING DETAIL NTS

METHODS OF HANGING DUCTS - NTS

OUTDOOR AIR CALCULATION

CALCULATION BASED ON ASHRAE 62.1-2004.

RECEIVING WAREHOUSE -. 06 CFM/SF x 2350 SF)

RECEIVING WAREHOUSE -. 06 CFM/SF x 3150 SF)

OFFICES: (1650 SF x X 5 PPL/1000 SFx17 CFM/PERSON

CONN. ——7

1" DEEPER THAN

FAN STATIC

PRESSURE

TYPICAL Z BAR

HANGING DETAIL

AND STRAP DUCT

= 141 CFM

= 189 CFM

= 140 CFM

= 198 CFM

HANGING DETAIL

AND WIRE DUCT

MOST DRAIN

CAP (LOOSE)

MECHANICAL LEGEND

FIXED BLADE CEILING DIFFUSER (CD)

FIXED BLADE RETURN/TRANSFER/EXHAUST GRILLE (RAG/TG/EF)

24X24 PERFORATED CEILING DIFFUSER.

24X24 PERFORATED RETURN/TRANSFER GRILLE.

→ IVD MANUAL VOLUME CONTROL DAMPER.

T WALL MOUNTED THERMOSTAT.

→ DSD DUCT MOUNTED SMOKE DETECTOR.

RIGID DUCTWORK.

FLEXIBLE DUCTWORK.

AHU AIR HANDLING UNIT.

CU CONDENSING UNIT.

AIR DEVICE SCHEDULE MANUFACTURED BY TITUS.

CONDENSATE LINE.

MODEL CONSTRUCTION MODULE MOUNT DESCRIPTION

TDC-AA ALUMINUM SURFACE FIXED BLADE CEILING DIFFUSER W/OBD.

TDC-AA-3 ALUMINUM 24X24 LAY-IN FIXED BLADE CEILING DIFFUSER W/OBD.

4FL-AA ALUMINUM SURFACE FIXED BLADE CEILING/SIDEWALL RETURN GRILLE W/OBD.

4FL-AA-3 ALUMINUM 24X24 LAY-IN FIXED BLADE CEILING RETURN GRILLE W/OBD.

NOTES:

1. ACCEPTABLE ALTERNATE MANUFACTURER SHALL BE METALAIRE.

2. COLOR SHALL BE WHITE.

FAN SCHEDULE

REST ROOM EXH. FAN/LIGHT FIXTURE GREENHECK
SP-B110
CEILING
TOILET
100/0.25
FRACTIONAL
950
120/1
W/LIGHTED
DECORATIVE GRILLE
PRISMATIC LENS &
TWO 13W CFL BULBS

ROOF TOP AIR CONDITIONING SCHEDULE

MODEL NUMBERS BASED ON TRANE. 1,2 WAREHOUSE 3 OFFICES 4 MEZZANINE SYSTEM MODEL TSC048E1 ARI RATED CFN HEAT KW @208 7, 5 DIMENSIONS (LXWXH) 65" X37" X46" 65" X37" X46" WEIGHT (LBS) REFRIGERANT R-410 R-410 TOTAL BTUH (NET) 52300 TOT, SENS, (NET) 28000 4. 0

NOTES:
1. TEMPERATURE CONTROL SYSTEM SHALL INCLUDE OFFSITE COMMPUTER & TELEPHONE MANAGEMENT. PROVIDE TELEPHONE ACCESS MODULE& TCONT900AC43UA.

ALTERNATE ROOF TOP BID-LENNOX 17.0 SEER SERIES

DATE: 7/6/10 DRAWN BY: AIC PROJ. NO. 10025 REVISED:

SHEET:

CONSULTING ENGINEERS

2705 PARK STREET

LAKE WORTH, FL 33460

E-MAIL CHANEINC@AOL.COM

TEL. 561-586-4003 FAX. 561-586-5688

CERTIFICATE OF AUTHORIZATION #2559

ARNOLD I. CHANE, PE #10024

DAVID R. JONES, PE #41042

SEAL

CHANE, INC.

HOWARD L. CHANE, PE #22467



LAN STRASSLER
RCHITECTS, INC.
M BEACH GARDENS, FLORIDA 33410
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THICATE OF AUTHORIZATION #AA26000610






CHNOLOGY PRODUCTS


LOT #7

RIVIERA BEACH ELORIDA

MEDICAL 1
HAVERHILL BUSINESS PARK
HAVERHILL ROAD

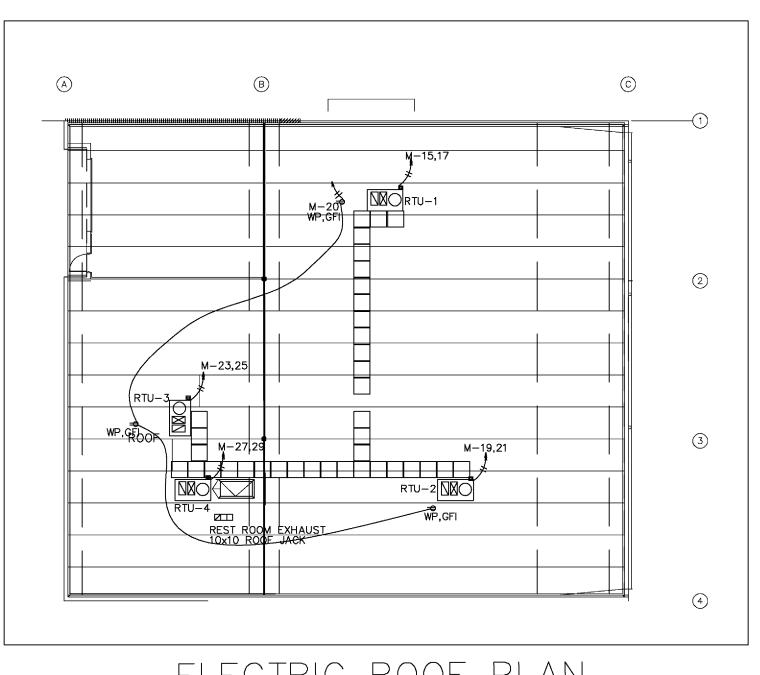


ELECTRIC ROOF PLAN
scale: 1/16"=1'-0"

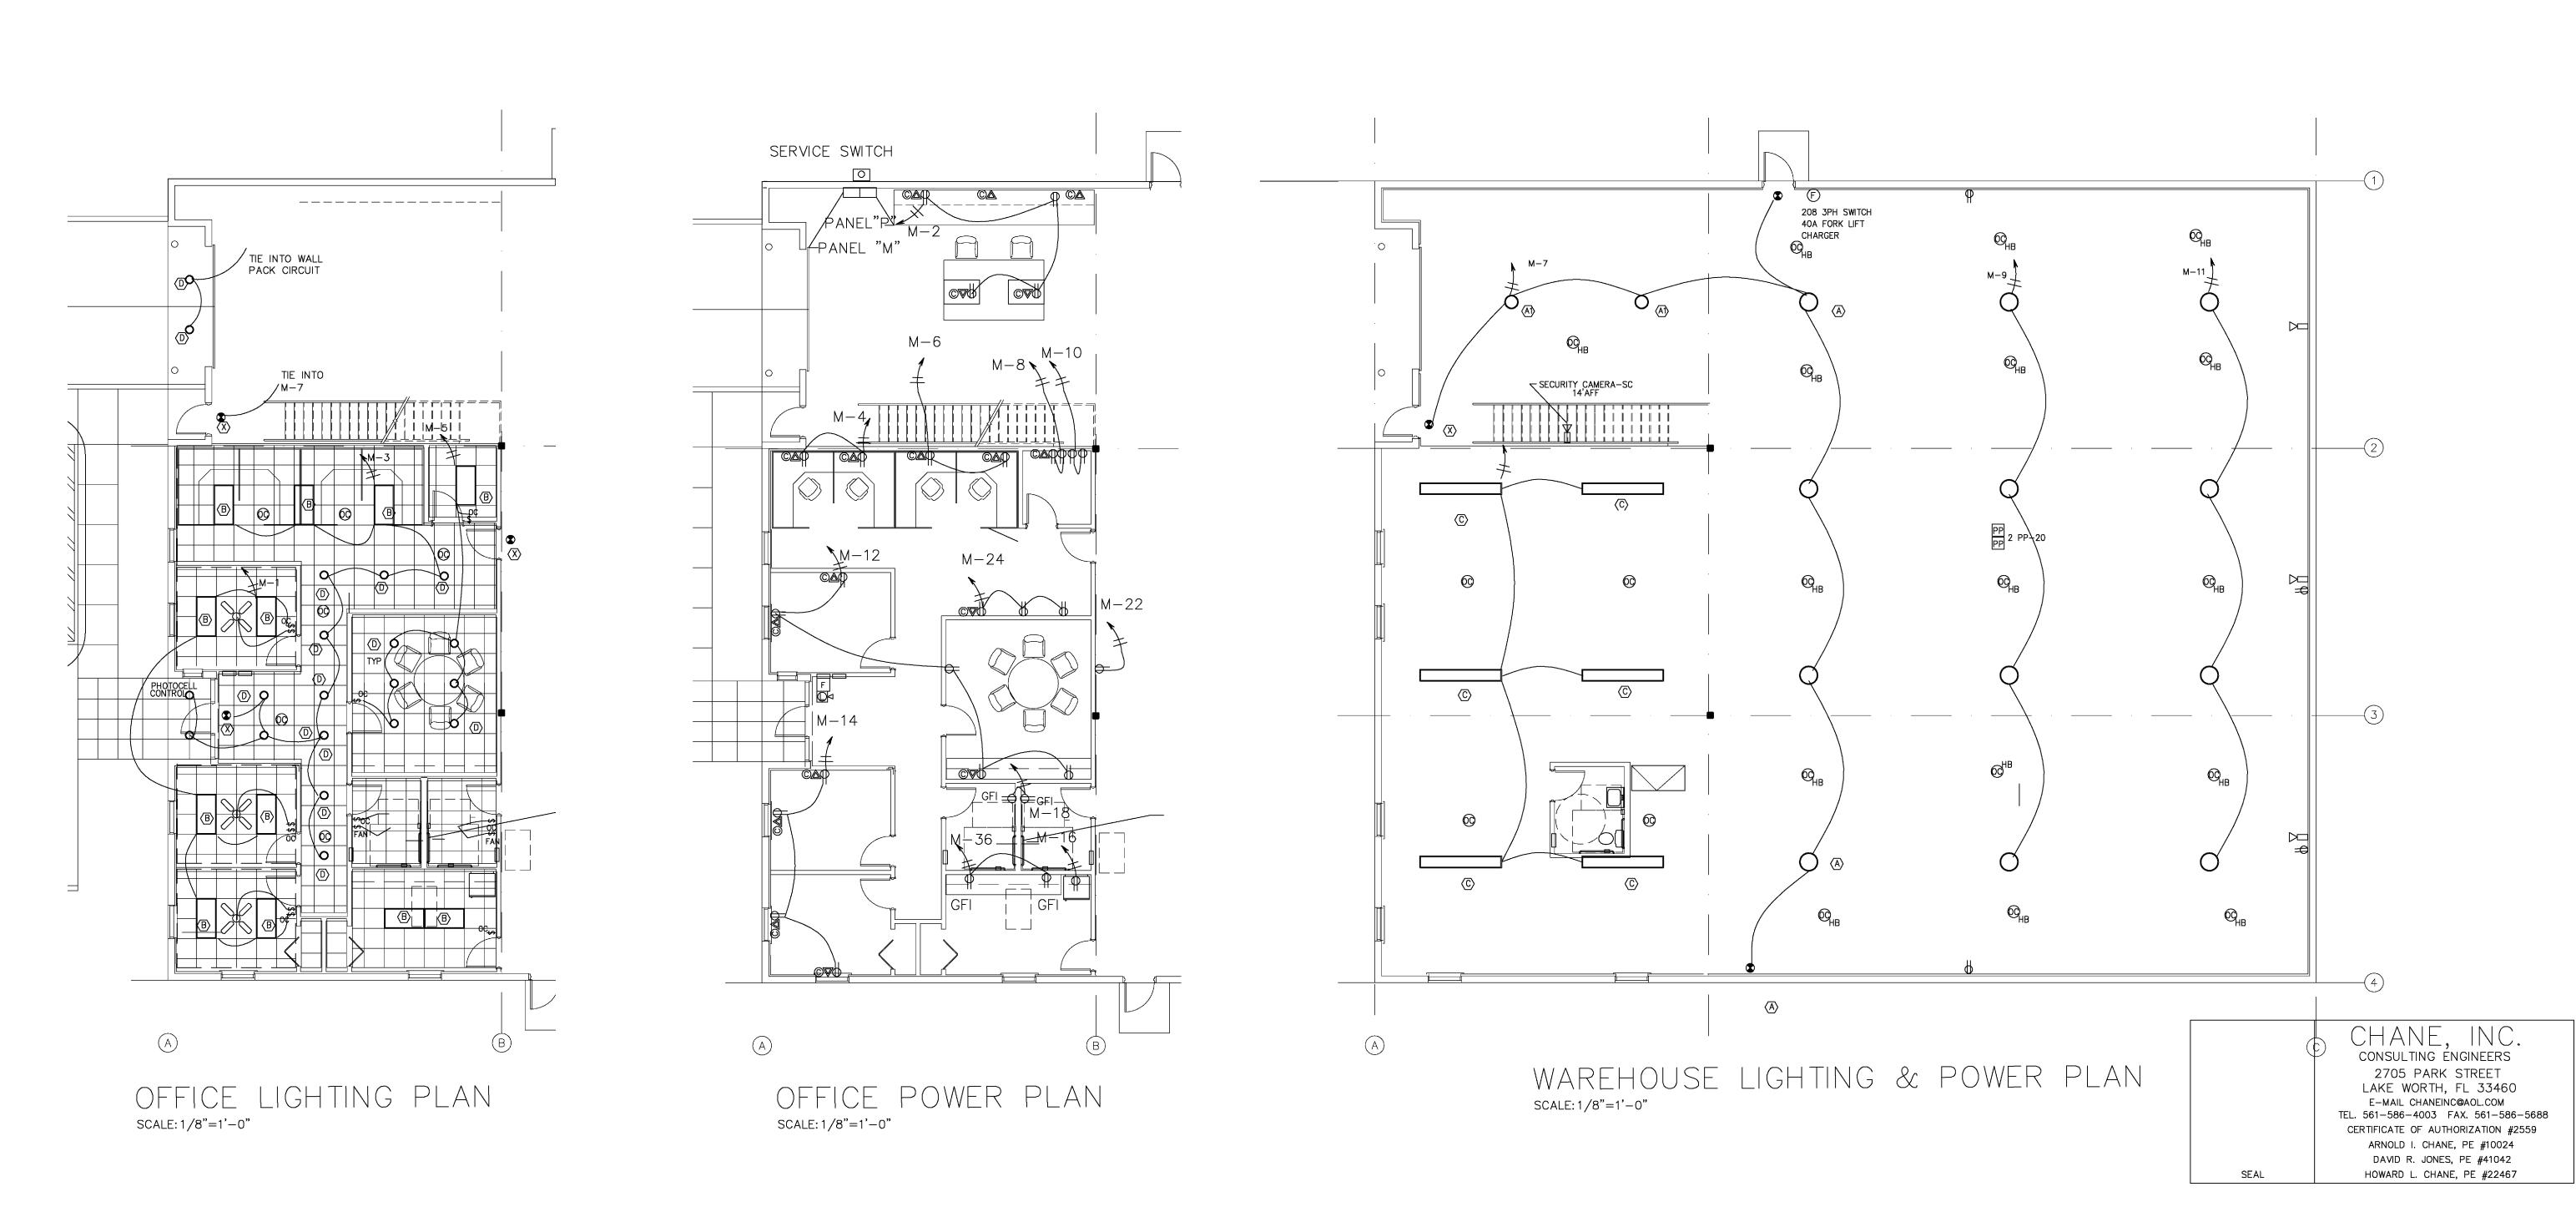


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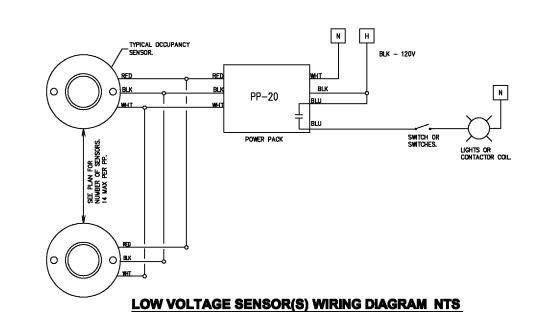
120/208	VO	LTS		3	PLIASE	4	WI			60	٨	MP BL	8		42 BR	ANCH POLES		Х	PU	LL NI	LARITE
FLUSH MOL	NTIN	3			60	AMP MAIN	LUG	s		S	HOR	T CIR	CUIT	=	22,000		AMP-SYM	-RMS	;		
COND. &	& AMPS				BKR		ç	C B C L		В	KR	R LOAD			AMPS			COND.			
WIRE	Α	В	С					Р	Α	}	š	Ť	Р	Α	1	LOAD		Α	В	С	WIRE
				SPAF	RE			1	20	1	Ιī	2			SPACE						
								П	П	3	П	4									
								Т	П	5	П	6									
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MULTIPLE POWER PACKS WITH MULTIPLE OCCUPANCY SENSORS



LOW VOLTAGE SENSOR(S) WIRING DIAGRAM NTS SINGLE POWER PACK WITH OCCUPANCY SENSORS (CONFERENCE ROOM & LOBBY)

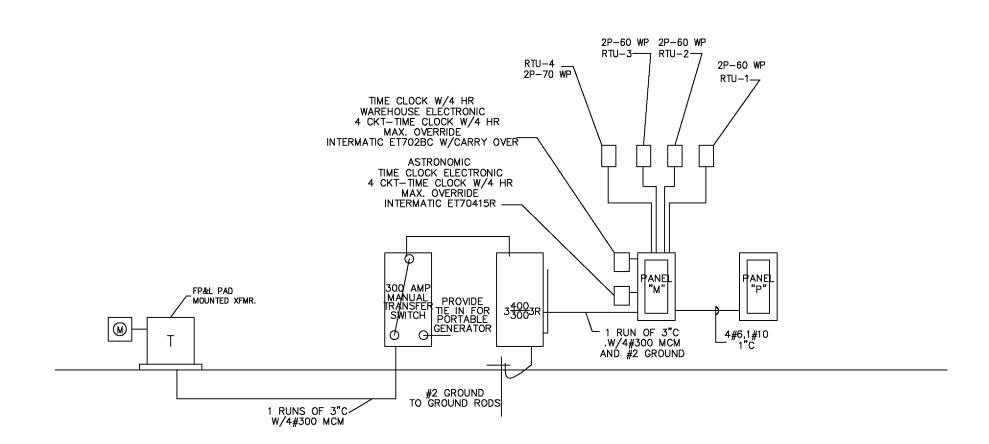


TO THE BALLAST FROM THE UNSWITCHED PORTION OF THE CIRCUIT.

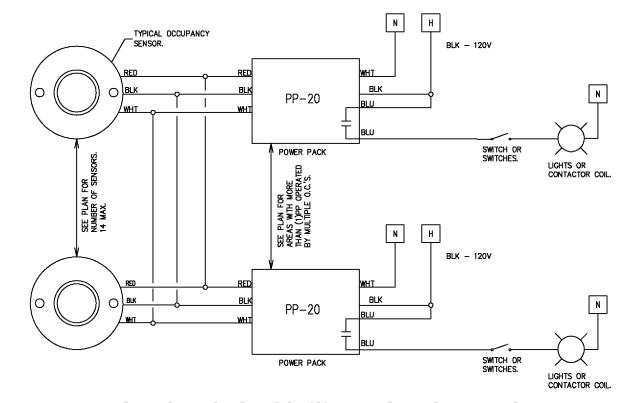TYPE	MANUFACTURER	CATALOG NO.	LAMPS	REMARKS
A	EVERLAST	EHB-AC-200W	(1)200W 5000K	WAREHOUSE LIGHT FIXTURE
A 1	EVERLAST	EHB-AC-150W	(1)150W 5000K	SHIPPING LIGHT FIXTURE
В	ULTRALUX	2X4 DIRECT INDIRECT OFFICE FIXTURE	(4)32W T5	2X4 DIRECT/INDIRECT LAYIN GRID CEILING MOUNT.
С	DAY-BRITE	TAWN-2-32-120	(6)32W T8	1X8 STEM MOUNT
D	CAPRI	CM6-F126/32/42U-H65WB	(1)32W CFQ	6" CFL DOWNLIGHT, CLEAR REFLECTOR, WHITE BAFFLE.
F	GARDCO	101-WT-175MH-120-BRP	(1)175W MH	WALL-MOUNTED EXTERIOR LIGHT, WIDE THROW, BRONZE FINIS
G	EVERLAST	ESB-EC-250W-INDUCTION	(1)250W /FIXTURE	THREE FIXTURES ON CONCRETE POLE
X	BEGHELLI	VA4-R-SA	INCLUDED	UNIVERSAL THERMOPLASTIC EXIT W/BATTERY, RED L.E.D.
Y	BEGHELLI	EST-6-36-2SR-18W-NC	INCLUDED	EMERGENCY LUMINAIRE W/BATTERY, UNIVERSAL MOUNT.

ELECTRICAL RISER DIAGRAM - NTS

	MANUFACTURED BY SENSOR SWITCH.	SPACE	AREA (SQFT)	LPD (W/SQFT)	ALLOWABLE (W)	DESIGN (W
C	WALL SWITCH W/OCCUPANCY SENSOR & BUILT IN POWER PACK SENSOR SWITCH #WSD-PDT-WHITE	WAREHOUSE	4740	1.4	1292.2	1056
)	LOW CEILING MOUNTED OCCUPANCY SENSOR TO CONTROL THE POWER PACK. SENSOR SWITCH #CM-9-PDT(WHITE).	RECEIVING	332	1.4	3379.2	2942
3	20 AMP POWER PACK THAT IS CONTROLLED BY	TRANSITION	37	0.5	18.5	64
1	THE OCCUPANCY SENSOR(S). LOCATE ABOVE ACCESSIBLE CEILING. WIRE AHEAD OF ANY LOCAL SWITCHING. 14 SENSORS MAX. PER PP.	RESTROOMS	200	0.9	180	256
	SENSOR SWITCH #PP-20.	OFFICES	83	1.1	91.3	96
LV	LINE VOLTAGE CEILING MOUNTED OCCUPANCY SENSOR SENSOR SWITCH #CMR-PDT (WHITE).	PRODUCTION OFFICE	143	1.1	157.3	192
		BREAK ROOM	483	0.9	434.7	576
LV,HB	HIGH CEILING MOUNTED, LINE VOLTAGE OCCUPANCY SENSOR MOUNT 6" BELOW JOIST.	RECEIVING AREA	332	1.4	464.8	256
SE	SENSOR SWITCH #CMR-6 (WHITE).	STAIRWELL 137	100	0.6	60	128
НВ	HIGH CEILING MOUNTED, POWER PACK CONTROL MOUNT 6" BELOW JOIST. SENSOR SWITCH #CMR-6 (WHITE).	TOTAL	5117		6078	5559

THE DESIGN WATTAGE OF 5559 W IS LESS THAN THE ALLOWABLE WATTAGE OF 6078 W. LIGHTING POWER CALCULATON AS PER FBC 13-415.B.1 (SPACE BY SPACE METHOD)

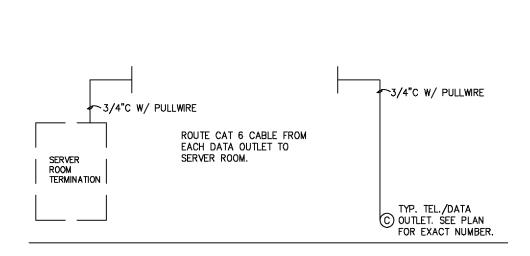

DATA TELEPHONE RISER DIAGRAM - NTS

ELECTRICAL NOTES:

1.ELECTRICAL CONTRACTOR SHALL SUPPLY AND INSTALL ALL NEW ELECTRICAL WORK INDICATED.CONSTRUCTION SHALL BE IN ACCORDANCE WITH DRAWINGS AND APPLICABLE SPECIFICATIONS.IF A PROBLEM IS ENCOUNTERED IN COMPLYING WITH THIS REQUIREMENT, CONTRACTOR SHALL NOTIFY THE OWNER OR HIS REPRESENTATIVE AS SOON AS POSSIBLE AFTER DISCOVERY OF THE PROBLEM AND SHALL NOT PROCEED WITH THAT PORTION OF THE WORK UNTIL OWNER HAS DIRECTED CORRECTIVE ACTION.

2.ELECTRICAL CONTRACTOR SHALL VISIT JOB SITE AND FAMILIARIZE HIMSELF WITH ALL CONDITIONS AFFECTING ELECTRICAL AND TELEPHONE INSTALLATION AND MAKE PROVISIONS AS TO THE COST THEREOF. 3.ALL WORK SHALL BE PERFORMED IN ACCORDANCE WITH THE NATIONAL ELECTRIC CODE AND THE FLORIDA BUILDING CODE. 4.DO NOT SCALE THE ELECTRICAL DRAWINGS.REFER TO ARCHITECTURAL PLANS AND ELEVATIONS FOR EXACT LOCATION OF ALL EQUIPMENT. CONFIRM WITH OWNERS REPRESENTATIVE. 5.MINIMUM WIRE SIZE SHALL BE #12 A.W.G. EXCLUDING CONTROL WIRING. UNLESS OTHERWISE NOTED, ALL CONDUCTORS SHALL BE COPPER WITH THHN INSULATION. 6.OUTLET BOXES SHALL BE PRESSED STEEL IN DRY LOCATIONS, CAST ALLOY WITH THREADED HUBS IN WET OR DAMP LOCATIONS AND SPECIAL ENCLOSURES FOR OTHER CLASSIFIED AREAS. 7.CONTRACTOR SHALL GUARANTEE ALL MATERIALS AND WORKMANSHIP FREE FROM DEFECTS FROM A PERIOD OF NOT LESS THAN ONE YEAR FROM DATE OF 8.CORRECTION OF ANY DEFECTS SHALL BE COMPLETED WITHOUT ADDITIONAL CHARGE AND SHALL INCLUDE REPLACEMENT OR REPAIR OF ANY OTHER PHASE OF THE INSTALLATION WHICH MAY HAVE BEEN DAMAGED THERE BY. 9.ALL REQUIRED INSURANCE SHALL BE PROVIDED FOR PROTECTION AGAINST PUBLIC LIABILITY AND PROPERTY DAMAGE FOR THE DURATION OF THE

10.CONTRACTOR SHALL PAY FOR ALL PERMITS. FEES, INSPECTIONS AND TESTING. CONTRACTOR TO OBTAIN PERMIT AND APPROVED SUBMITTALS PRIOR TO BEGINNING WORK OR ORDERING EQUIPMENT. 11.THE ELECTRICAL INSTALLATION SHALL MEET ALL REQUIREMENTS OF 12.CONTRACTOR SHALL COORDINATE WITH MECHANICAL DRAWINGS AND PROVIDE ALL NECESSARY CONTROL WIRING. 13.ALL CIRCUIT BREAKERS FEEDING MECHANICAL EQUIPMENT SHALL BE HACR TYPE CIRCUIT BREAKERS OR FUSED SWITCHES AS INDICATED. 14.PROVIDE AND INSTALL CONDUIT, CONDUCTORS, PULL WIRES, BOXES, COVER PLATES, DEVICES FOR ALL OUTLETS AS INDICATED. 15.CONTRACTOR SHALL BE RESPONSIBLE FOR ALL CUTTING AND PATCHING REQUIRED OF HIS WORK. 16.ELECTRICAL CONTRACTOR SHALL LABEL EXTERIOR OF ALL PANELS AND PROVIDE COMPLETE TYPEWRITTEN DIRECTORIES. 17.ALL ELECTRICAL AND TELEPHONE/DATA OUTLETS TO BE AT 16" AFF UNLESS NOTED OTHERWISE, VERTICALLY MOUNTED. 18.ALL LIGHT SWITCHES TO BE AT 42" AFF. 19.LAY IN LIGHT FIXTURES TO BE SUPPORTED AT ALL FOUR CORNERS AND SECURED TO STRUCTURE ABOVE. 20.ALL ELECTRICAL WIRING SHALL BE THE RESPONSIBILITY OF THE ELECTRICAL CONTRACTOR. ALL ELECTRICAL WIRING FOR HVAC SYSTEM INCLUDING CONTROLS, THERMOSTATS, POWER, ETC. SHALL BE THE RESPONSIBILITY OF THE ELECTRICAL CONTRACTOR. 21.PANELBOARDS: ALL CURRENT CARRYING BUSES SHALL BE COPPER. ALL GROUND BUS BARS SHALL BE COPPER. PANELBOARD ENCLOSURES SHALL BE FURNISHED WITHOUT PRE-PUNCHED CONCENTRIC HOLES.AIC RATINGS SHALL BE AS INDICATED ON PANELBOARD SCHEDULES 22.DISCONNECT SWITCHES SHALL BE H.P. RATED, HEAVY DUTY, ENCLOSURES 23.CONTRACTOR SHALL CONFIRM WITH FPL ANY AND ALL REQUIREMENTS SUCH AS: LUG SIZE RESTRICTIONS, CONDUIT ENTRY, TRANSFORMER SIZE, SCHEDULED DOWN TIME FOR OWNERS CONFIRMATION, ETC. ANY CONFLICTS SHALL BE BROUGHT TO ATTENTION OF THE ENGINEER BEFORE PROCEEDING WITH ANY WORK. 24.ALL SERVICE CONDUIT AND ALL EXPOSED EXTERIOR CONDUITS SHALL BE RIGID METAL. INTERIOR LIGHTING AND RECEPTACLE CONDUIT SHALL BE EMT.

I. WITHIN 30 DAYS AFTER THE DATE OF SYSTEM ACCEPTANCE, RECORD DRAWINGS OF THE ACTUAL INSTALLATION SHALL BE PROVIDED TO THE BUILDING OWNER, INCLUDING THE FOLLOWING. A. A SINGLE LINE DIAGRAM OF THE BUILDING ELECTRICAL SYSTEM.

B. FLOOR PLANS INDICATING THE LOCATION & THE AREA SERVED FOR ALL DISTRIBUTION. 2. THE CONTRACTOR SHALL PROVIDE THE BUILDING OWNER W/AN OPERATING MANUAL & A MAINTENANCE MANUAL. THE MANUALS SHALL INCLUDE THE FOLLOWING. A. SUBMITTAL DATA STATING EQUIPMENT RATINGS & SELECTED OPTIONS FOR EACH PIECE OF EQUIPMENT REQUIRING MAINTENANCE. B. OPERATION MANUALS & MAINTENANCE MANUALS FOR EACH PIECE OF EQUIPMENT REQUIRING MAINTENANCE. REQUIRED ROUTINE
MAINTENANCE ACTIONS SHALL BE CLEARLY IDENTIFIED.
C. NAMES & ADDRESSES OF AT LEAST ONE QUALIFIED SERVICE

25.ELECTRICAL OUTLETS SERVING EWC'S SHALL BE MOUNTED OUTSIDE OF THE CABINET.

SPECIFIC ELECTRICAL NOTES:

26.ANY EXPOSED LOW VOLTAGE WIRING IN WAREHOUSE AREAS SHALL BE IN CONDUIT IF LOCATED BELOW THE JOISTS.

ELECTRICAL LEGEND:

RECESSED FLUORESCENT. RECESSED DOWNLIGHT. SURFACE LIGHT

EXIT/EMERGENCY COMBINATION LIGHT. EMERGENCY LIGHT. LIGHT FIXTURE TYPE DESIGNATION. DUPLEX RECEPTACLE. QUAD-PLEX RECEPTACLE.

TELEPHONE OUTLET.

FIRE ALARM DUCT SMOKE DETECTOR. FIRE ALARM TEST/RESET STATION. FIRE ALARM MANUAL PULL STATION. FIRE ALARM AUDIO/VISUAL DEVICE. FIRE ALARM VISUAL DEVICE.

POWER PACK (SEE DEVICE SCHEDULE).

DISCONNECT

STRIP FLUORESCENT LIGHT.

JUNCTION BOX. 4" SQUARE UNLESS NOTED.

GROUND FAULT INTERRUPTER. TOGGLE TYPE WALL SWITCH (3 = 3 WAY)TWO POLE RECEPTACLE

OCCUPANCY SENSOR (SEE DEVICE SCHEDULE).

CONTRACTOR SHALL PROVIDE PULL STATIONS & HORNS. COORDINATE FLOW & TAMPER SWITCHES W/ FIRE PROTECTION CONTRACTOR.

SEAL

DISTERACT DRAWN BY: AIC PROJ. NO. 10025 REVISED:

VIERA

CONSULTING ENGINEERS 2705 PARK STREET LAKE WORTH, FL 33460 E-MAIL CHANEINC@AOL.COM TEL. 561-586-4003 FAX. 561-586-5688 CERTIFICATE OF AUTHORIZATION #2559

> ARNOLD I. CHANE, PE #10024 DAVID R. JONES, PE #41042

HOWARD L. CHANE, PE #22467

SHEET:

ELECTRICAL RISER-NOTES-SCHEDULES PLAN NO SCALE