birse design inc + architecture + interior design + planning


5300 woodland lakes drive palm beach gardens, fl 33418

phone 561-249-4001 fax 772-409-8684 AA26001615

MECHANICAL ENGINEER / ELECTRICAL / PLUMBING



129 N. FEDERAL HWY. SUITE 211 LAKE WORTH, FL 33460 (561) 582-0210 P.E. 37933

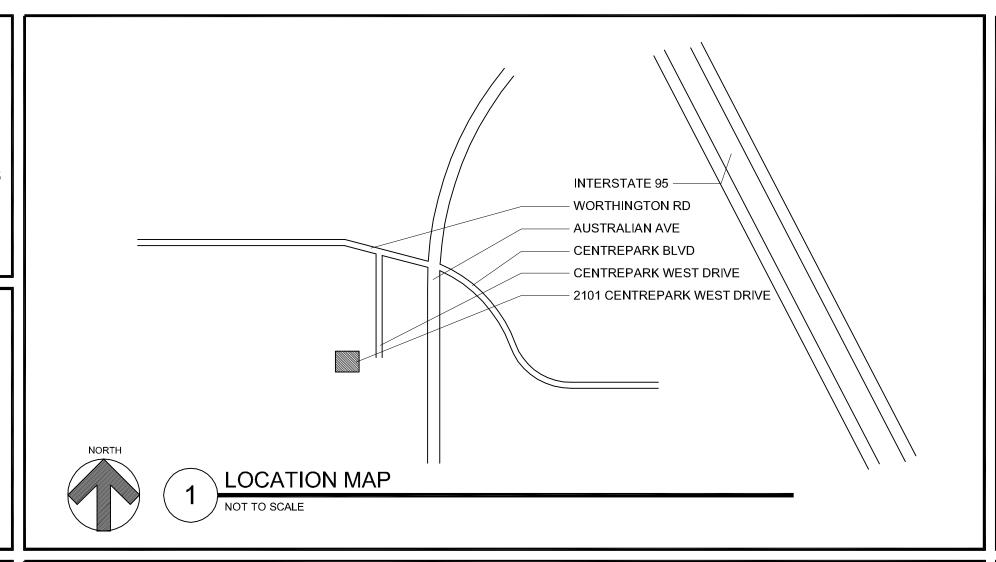

INDEX OF SHEETS:

TITLE SHEET

ARCHITECTURAL SHEETS

EXISTING FLOOR PLAN

DEMDO FLOOR PLAN

PROPOSED FLOOR PLAN

PROPOSED CEILING PLAN

DETAILS / ELEVATIONS


FIRE PROTECTION PLAN

MECHANICAL/ELECTRICAL/PLUMBING SHEETS

MECHANICAL PLANS ELECTRICAL PLANS

LIGHTING PLANS

PANEL SCHEDULES

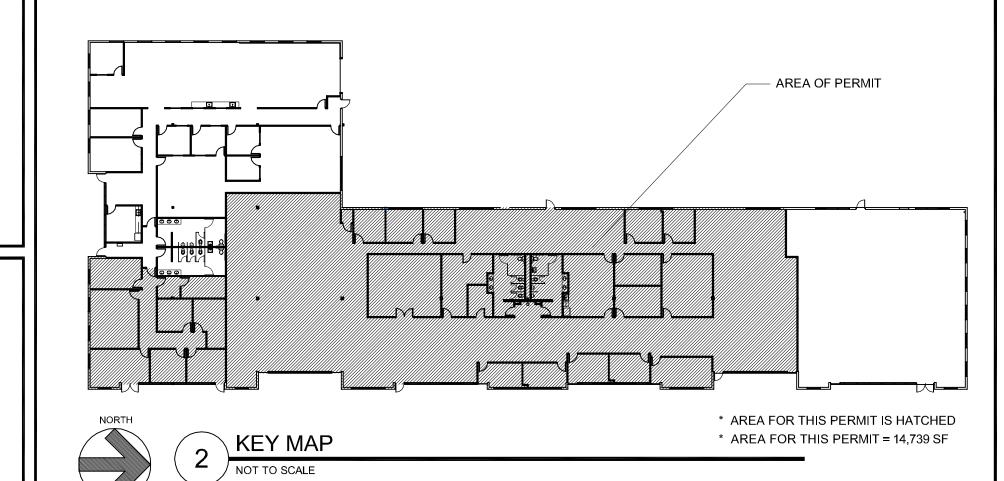

SYMBOL INDEX:

- ROOM NAME - ROOM NUMBER

- DOOR MARK/NUMBER

WINDOW MARK/NUMBER

- WALL SECTION/SHEET NUMBER

- BUILDING SECTION/SHEET NUMBER

- ELEVATION TARGET/SHEET NUMBER

DETAIL NUMBER/SHEET NUMBER

CEILING HEIGHT

- 2'x4' FLUORESCENT LIGHT FIXTURE

- FIRE EXTINGUISHER

RECESSED LIGHT DOWN FIXTURE

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WALL MOUNTED LIGHT FIXTURE

PROJECT DATA:

* PROJECT ADDRESS: 2301 CENTREPARK WEST DRIVE WEST PALM BEACH, FL 33401

* EXISTING BUILDING IS TYPE II "B"

* EXISTING BUILDING IS A 1 STORY BUILDING

* EXISTING BUILDING CLASSIFICATION IS GROUP "B"

* LEVEL 2 ALTERATION PER "EXISTING BUILDING CODE 2007"

* 1ST FLOOR IS A MULTI TENANT FLOOR

* SUITES #125 WILL COMBINE WITH SUITE #150 TO MAKE ONE SUITE

* NEW SUITE TO BE DESIGNATED AS SUITE #150

* EXISTING SUITES #125 = 2,027 SF * EXISTING SUITES #150 = 12,712 SF

* TOTAL NEW SUITE #150 = 14,739 SF

PROJECT NOTES:

* TOTAL NEW SUITE = 14,739 SF/100 = 147 OCCUPANTS

* PROPOSED DESIGN OCCUPANT LOAD = 147 OCCUPANTS

REFERENCE STANDARDS:

- THIS PROJECT IS DESIGNED IN ACCORDANCE WI THE FOLLOWING CODES:
- . THE FLORIDA BUILDING CODE (FBC), 2007 EDITION WITH 2009 SUPPLEMENTS (BUILDING, MECHANICAL, PLUMBING, FUEL GAS,
- NATIONAL ELECTRIC CODE (NEC), 2008 EDITION.
- 3. FLORIDA FIRE PREVENTION CODE, 2007 EDITION.
- 4. NATIONAL FIRE PROTECTION ASSOCIATION (NFPA) 101, LIFE SAFETY CODE, 2006 EDITION.
- 5. NATIONAL FIRE PROTECTION ASSOCIATION (NFPA) 1, UNIFORM FIRE CODE, 2006 EDITION.

GENERAL NOTES:


- THE CONTRACTOR SHALL AS A PART OF THIS CONTRACT FURNISH ALL MATERIALS, LABOR, TOOLS, EQUIPMENT, TRANSPORTATION, AND INSURANCE NECESSARY TO PROPERLY EXECUTE AND COMPLETE THE WORK ACCORDING TO THE PLANS AND SPECIFICATIONS.
- THE CONTRACTOR IN THE WORK OF ALL TRADES SHALL PROTECT ALL EXISTING BUILDING AND PROPERTY FROM DAMAGE CAUSED BY THE ACTIVITIES OF THE CONTRACTOR AND SUBCONTRACTORS. THE CONTRACTOR SHALL REPAIR AND RESTORE THE JOB SITE AND SURROUNDING AREAS TO IT'S ORIGINAL CONDITION. OWNER TO VERIFY SATISFACTION.
- THE CONTRACTOR SHALL VISIT THE JOB SITE TO VERIFY ALL EXISTING CONDITIONS PRIOR TO BID. CONTRACTOR TO NOTIFY ARCHITECT OF ANY DISCREPANCIES, INCONSISTENCIES OR OMISSIONS BEFORE PROCEEDING WITH ANY WORK.
- . THE CONTRACTOR SHALL MAKE NO CHANGES TO THE CONSTRUCTION DRAWINGS WITHOUT WRITTEN APPROVAL FROM THE ARCHITECT.
- 5. ALL CONSTRUCTION SHALL CONFORM WITH THE LATEST CODES AND ORDINANCES.
- THESE CONSTRUCTION DOCUMENTS ARE DIAGRAMATIC AND ARE TO CONVEY DESIGN INTENT. IT IS NOT THE INTENT OF THESE CONSTRUCTION DRAWINGS TO SHOW ALL DETAILS OF THE EXISTING CONDITIONS. THE CONTRACTOR SHALL VISIT THE SITE TI VERIFY DIMENSIONS PRIOR
- 7. EACH CONTRACTOR SHALL ESTABLISH AND VERIFY ALL OPENINGS AND INSERTS FOR MECHANICAL, ELECTRICAL, AND PLUMBING WITH THE APPROPRIATE TRADES
- 8. ALL INDICATED UTILITY AND STUB-IN LOCATIONS ARE FOR REFERENCE ONLY. THE EXACT LOCATIONS SHALL BE VERIFIED ON THE JOB SITE.
- 9. THE CONTRACTOR SHALL BE RESPONSIBLE FOR COORDINATING WITH ENGINEERING AND THE ARCHITECTURAL DRAWINGS FOR THE ACTUAL
- PLACEMENT OF THE WORK RELATIVE TO FIELD CONDITIONS.
- 10. THE CONTRACTOR SHALL BE RESPONSIBLE FOR THE OBTAINING INSTALLATION REQUIREMENTS FOR ALL BUILT-IN APPLIANCES, FIXTURES, AND EQUIPMENT. VERIFY EXACT ROUGH-IN DIMENSIONS AND NOTIFY ARCHITECT OF ANY DISCREPANCIES PRIOR TO ROUGH-IN FRAME.
- 11. THE COST OF ADDITIONAL DESIGN WORK DUE TO ERRORS OR OMMISIONS IN CONSTRUCTION SHALL BE BORNE BY THE RESPECTIVE
- 10. DETAILS ON THE STRUCTURAL DRAWINGS (IF PROVIDED) ARE TYPICAL. VERIFY ALL DIMENSIONS WITH THE STRUCTURAL DRAWINGS.
- 12. CONTRACTOR TO BE RESPONSIBLE FOR CHECKING STRUCTURAL CALCULATIONS FOR SPECIFIC REQUIREMENTS OF STRUCTURAL CONNECTIONS. SUBMIT STEEL TRUSS CALCULATIONS AND SHOP DRAWINGS OF ALL STRUCTURAL STEEL AND MISCELLANEOUS METAL FABRICATION BEFORE COMMENCING FABRICATION.
- 13. BIRSE DESIGN, INC. SHALL IN NO WAY BE RESPONSIBLE FOR THE CONSTRUCTION MEANS, METHODS, TECHNOLOGIGES, SEQUENCES OR PROCEDURES, OR FOR SAFETY PRECAUTIONS AND PROGRAMS IN CONNECTION WITH THE WORK. (THESE ARE SOLELY THE CONTRACTORS RESPONSIBILITY UNDER THE CONTRACT FOR CONSTRUCTION.
- 14. EACH CONTRACTOR SHALL PROVIDE ALL NECESSARY TEMPORARY BRACING, SHORING, GUYING, OR OTHER MEANS TO AVOID EXCESSIVE STRESSES AND TO HOLD STRUCTURAL ELEMENTS ASSOCIATED WITH WORK IN PLACE DURING CONSTRUCTION.
- 15. PROVIDE PORTABLE FIRE EXTINGUISHERS DURING CONSTRUCTION AS REQUIRED BY LOCAL CODES.
- 16. SPRINKLER SYSTEM: INSTALL FULL BUILDING SPRINKLER SYSTEM IN COMPLIANCE WITH THE REQUIREMENTS OF NFPA 13. SHOP DRAWINGS MUST BE APPROVED BEFORE INSTALLATIONS. PROVIDE OWNER WITH 2 COPIES OF PERMIT SETS.
- . ALL CONTRACTORS AND SUBCONTRACTORS SHALL BE RESPONSIBLE FOR MEETING THE REQUIREMENTS OF ALL CURRENT APPLICABLE BUILDING CODES AND ENFORCEMENT AGENCIES, FIRE MARSHALL, OR ANY OTHER BUILDING CODE ENFORCEMENT OFFICER AT NO EXTRA COST TO THE OWNER. NOTIFY THE ARCHITECT IN WRITING OF ANY DISCREPHANCIES PRIOR TO SUBMITTING A BID FOR THE PROJECT.
- 18. BASE BID SHALL INCLUDE BUT NOT BE LIMITED TO THE FOLLOWING:
- A. ALL PERMITS AND FEES FOR ALL

OF PERMIT SET TO OWNER

- 1. BUILDING AND TRADE PERMITS. 2. ALL ACCESSORY AND SITE IMPROIVEMENT PERMITS.
- B. ALL FILL REQUIRED TO MEET MINIMUM FINISHED FLOOR SLAB ELEVATION AND COMPACTION.
- C. WATER METER HOOK-UP AND METER DEPOSITS. OWNER RESPONSIBILITY
- D. HOOK-UP AND FEES FOR UNDERGROUND SERVICE FROM FPL
- LOCAL PHONE & CABLE T.V. OWNER RESPONSIBILITY
- F. ENGINEERING STAKE OUTS AND SURVEYS INCLUDING FINAL TIE IN SURVEY.
- G. CLEARING, GRUB, AND SITE PREPARATION, INCLUDING GRADING. H. ALL BIDDERS AND THEIR SUBCONTRACTORS SHALL BE CURRENTLY LICENSED
- IN THE STATE OF FLORIDA.

E. SOIL, CONCRETE AND ANY OTHER NECESSARY TESTING.

- I. THE OWNER RESERVES THE RIGHT TO REJECT ANY BIDS. J. THE G.C. SHALL PROVIDE AN ESTIMATE OF TIME FOR COMPLETION.
- K. THE GENERAL CONTRACTOR SHALL PROVIDE PROOF OF INSURANCE FOR WORKMANS' COMPENSATION AND ANY OTHER INSURANCES REQUIRED BY THE OWNER FOR ALL EMPLOYEES EITHER DIRECTLY EMPLOYED BY THE
- GENERAL CONTRACTOR OR BY HIS SUBCONTRACTORS. L. THE CONTRACTOR SHALL CLEARLY LIST ANY WORK NOT
- INCLUDED IN HIS BID. M. PROVIDE FIRE DEPARTMENT KNOX BOX ADJACENT TO FRONT DOOR OF BLDG. N. CONTRACTOR TO PROVIDE AS BUILT DRAWINGS. PROVIDE TWO COPIES

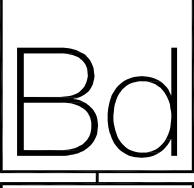


ALLEN S BIRSE


REVISIONS


OM BIRSE DESIGNING.


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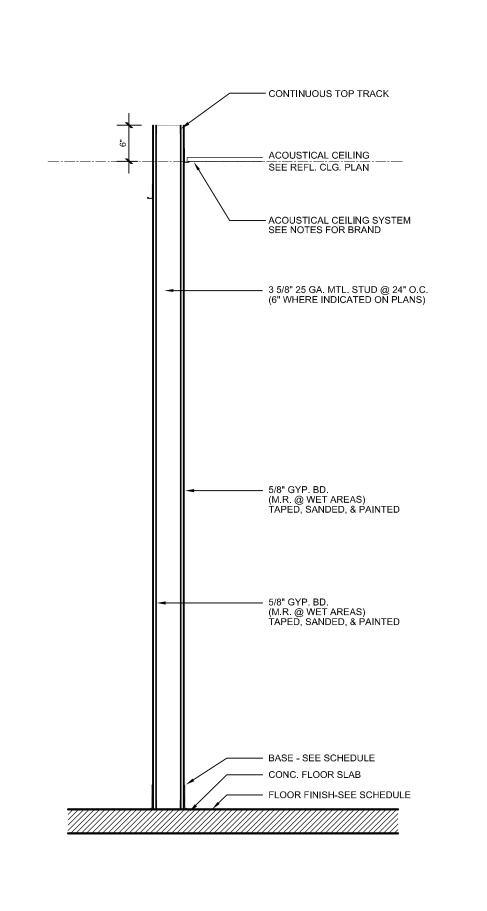
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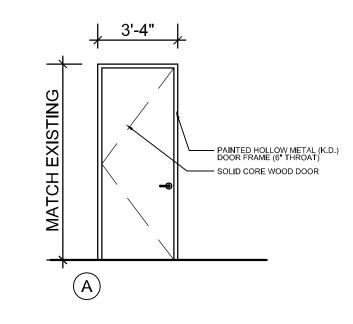




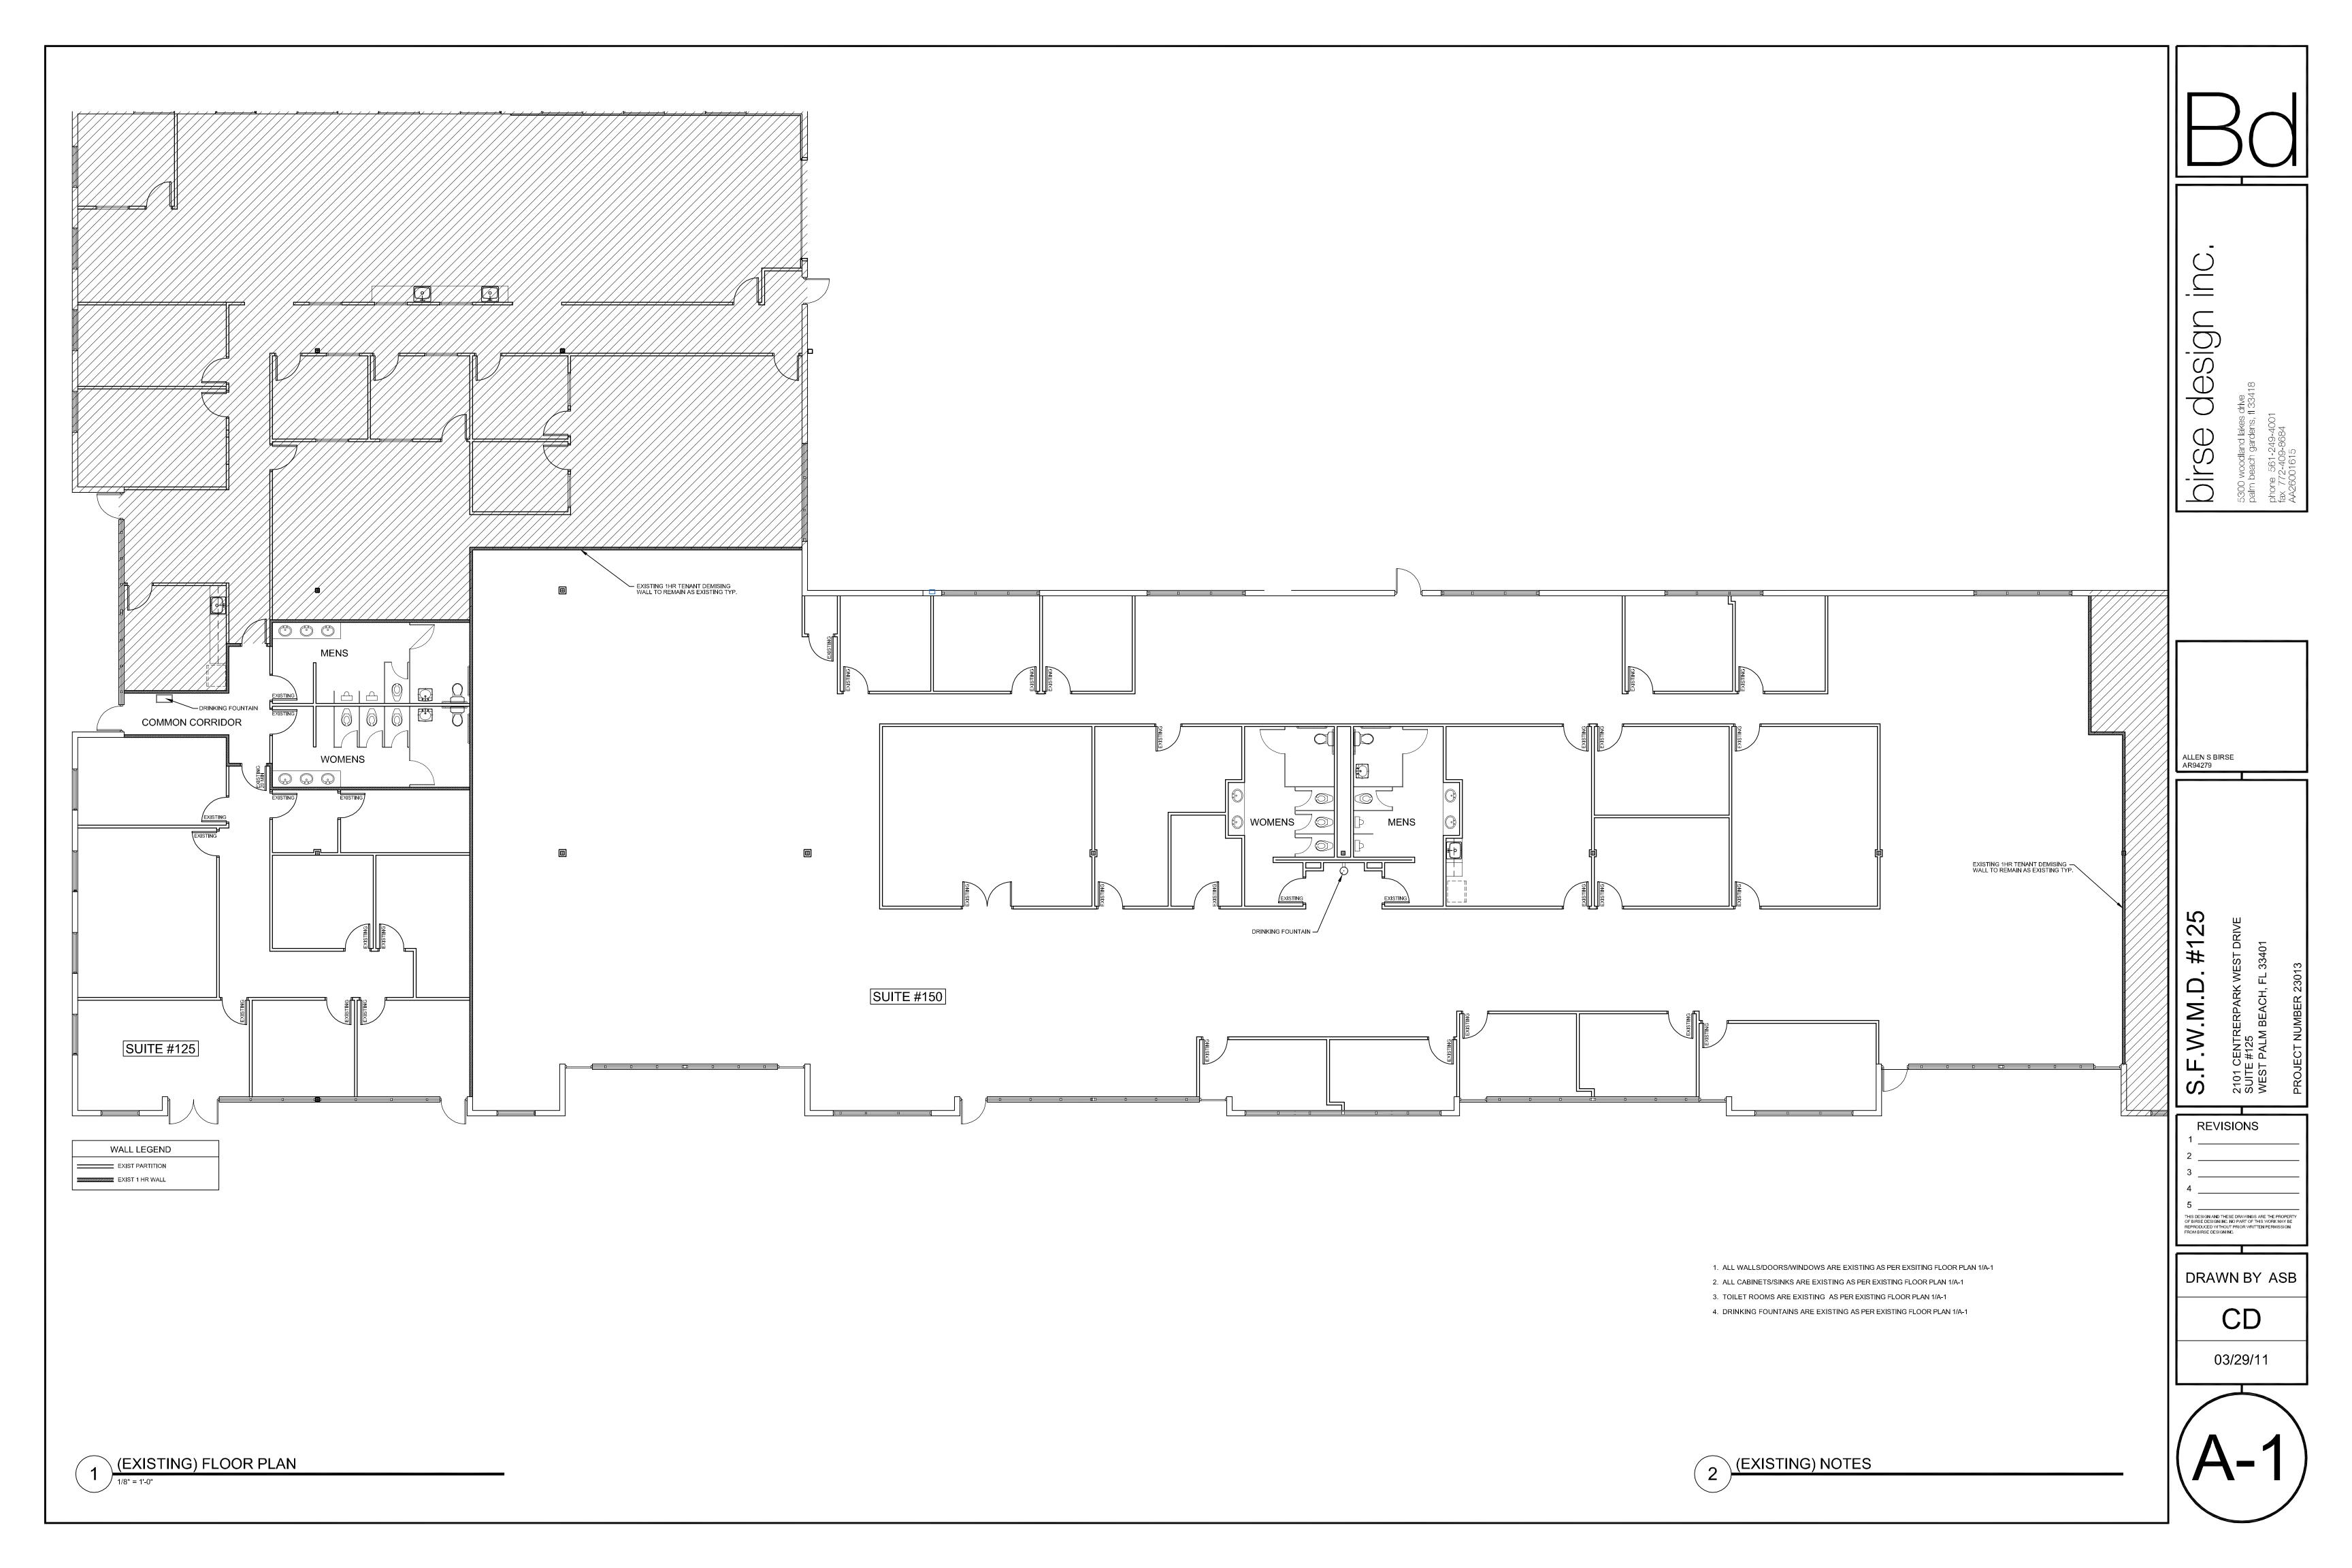

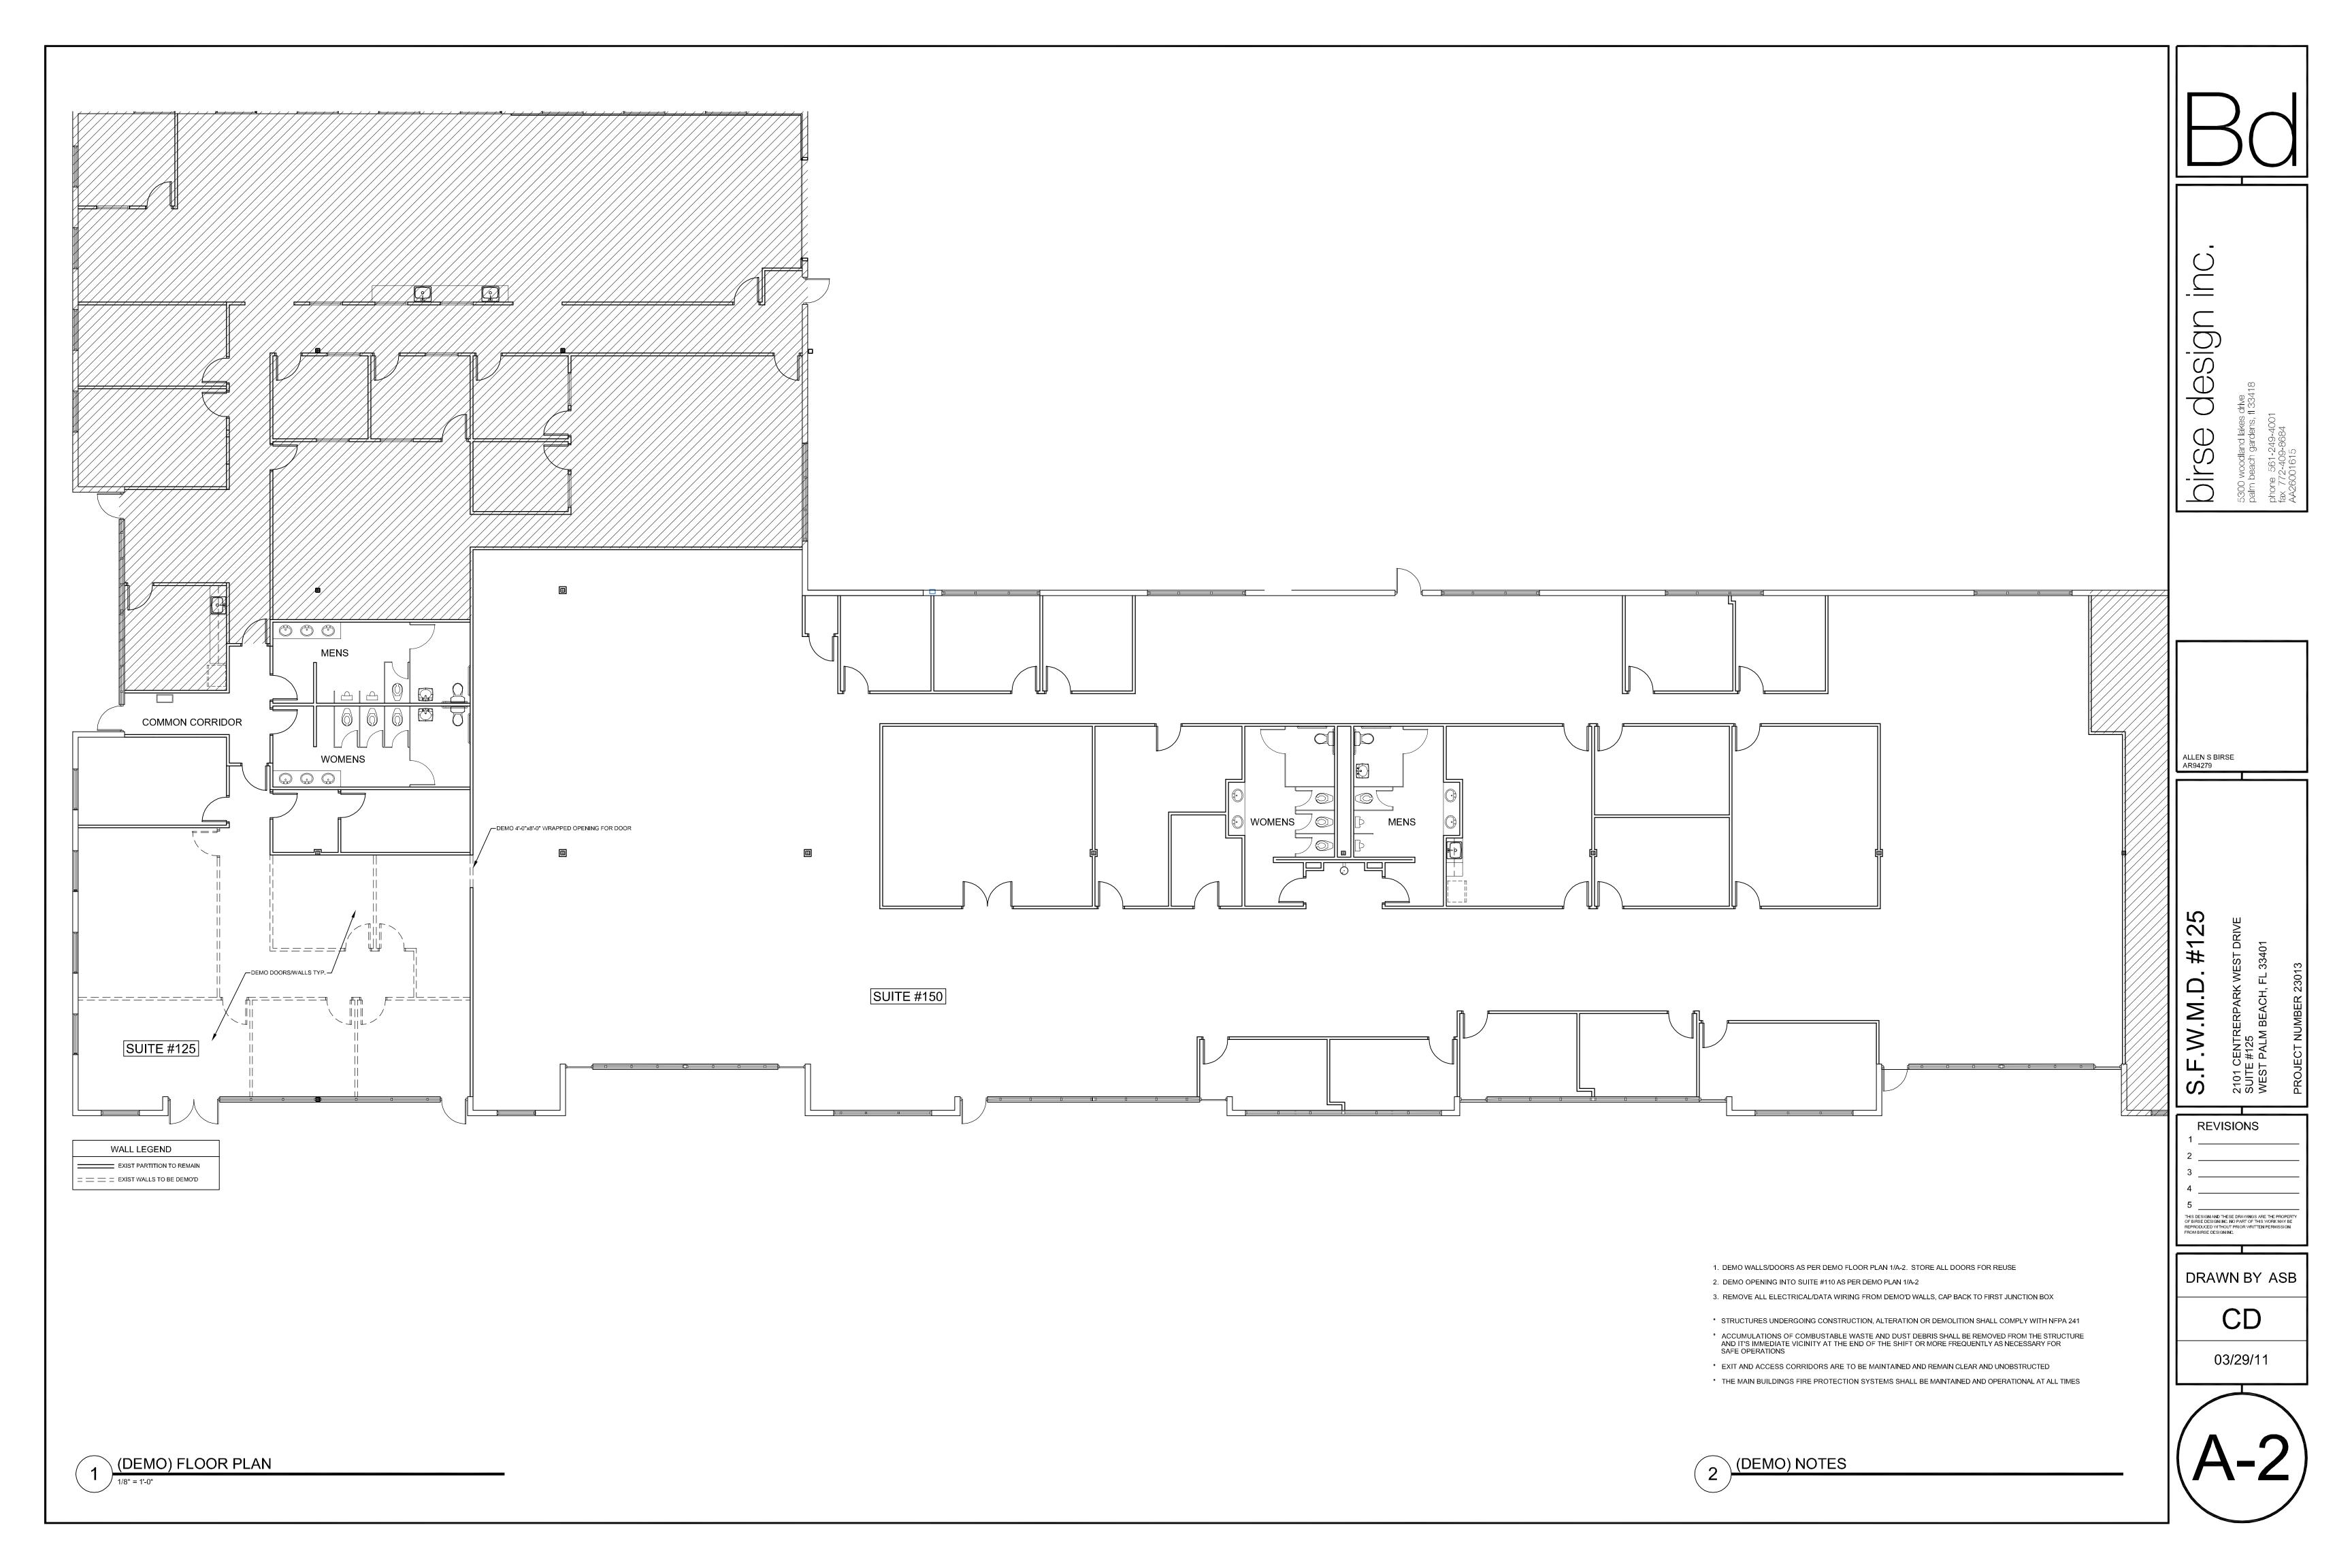

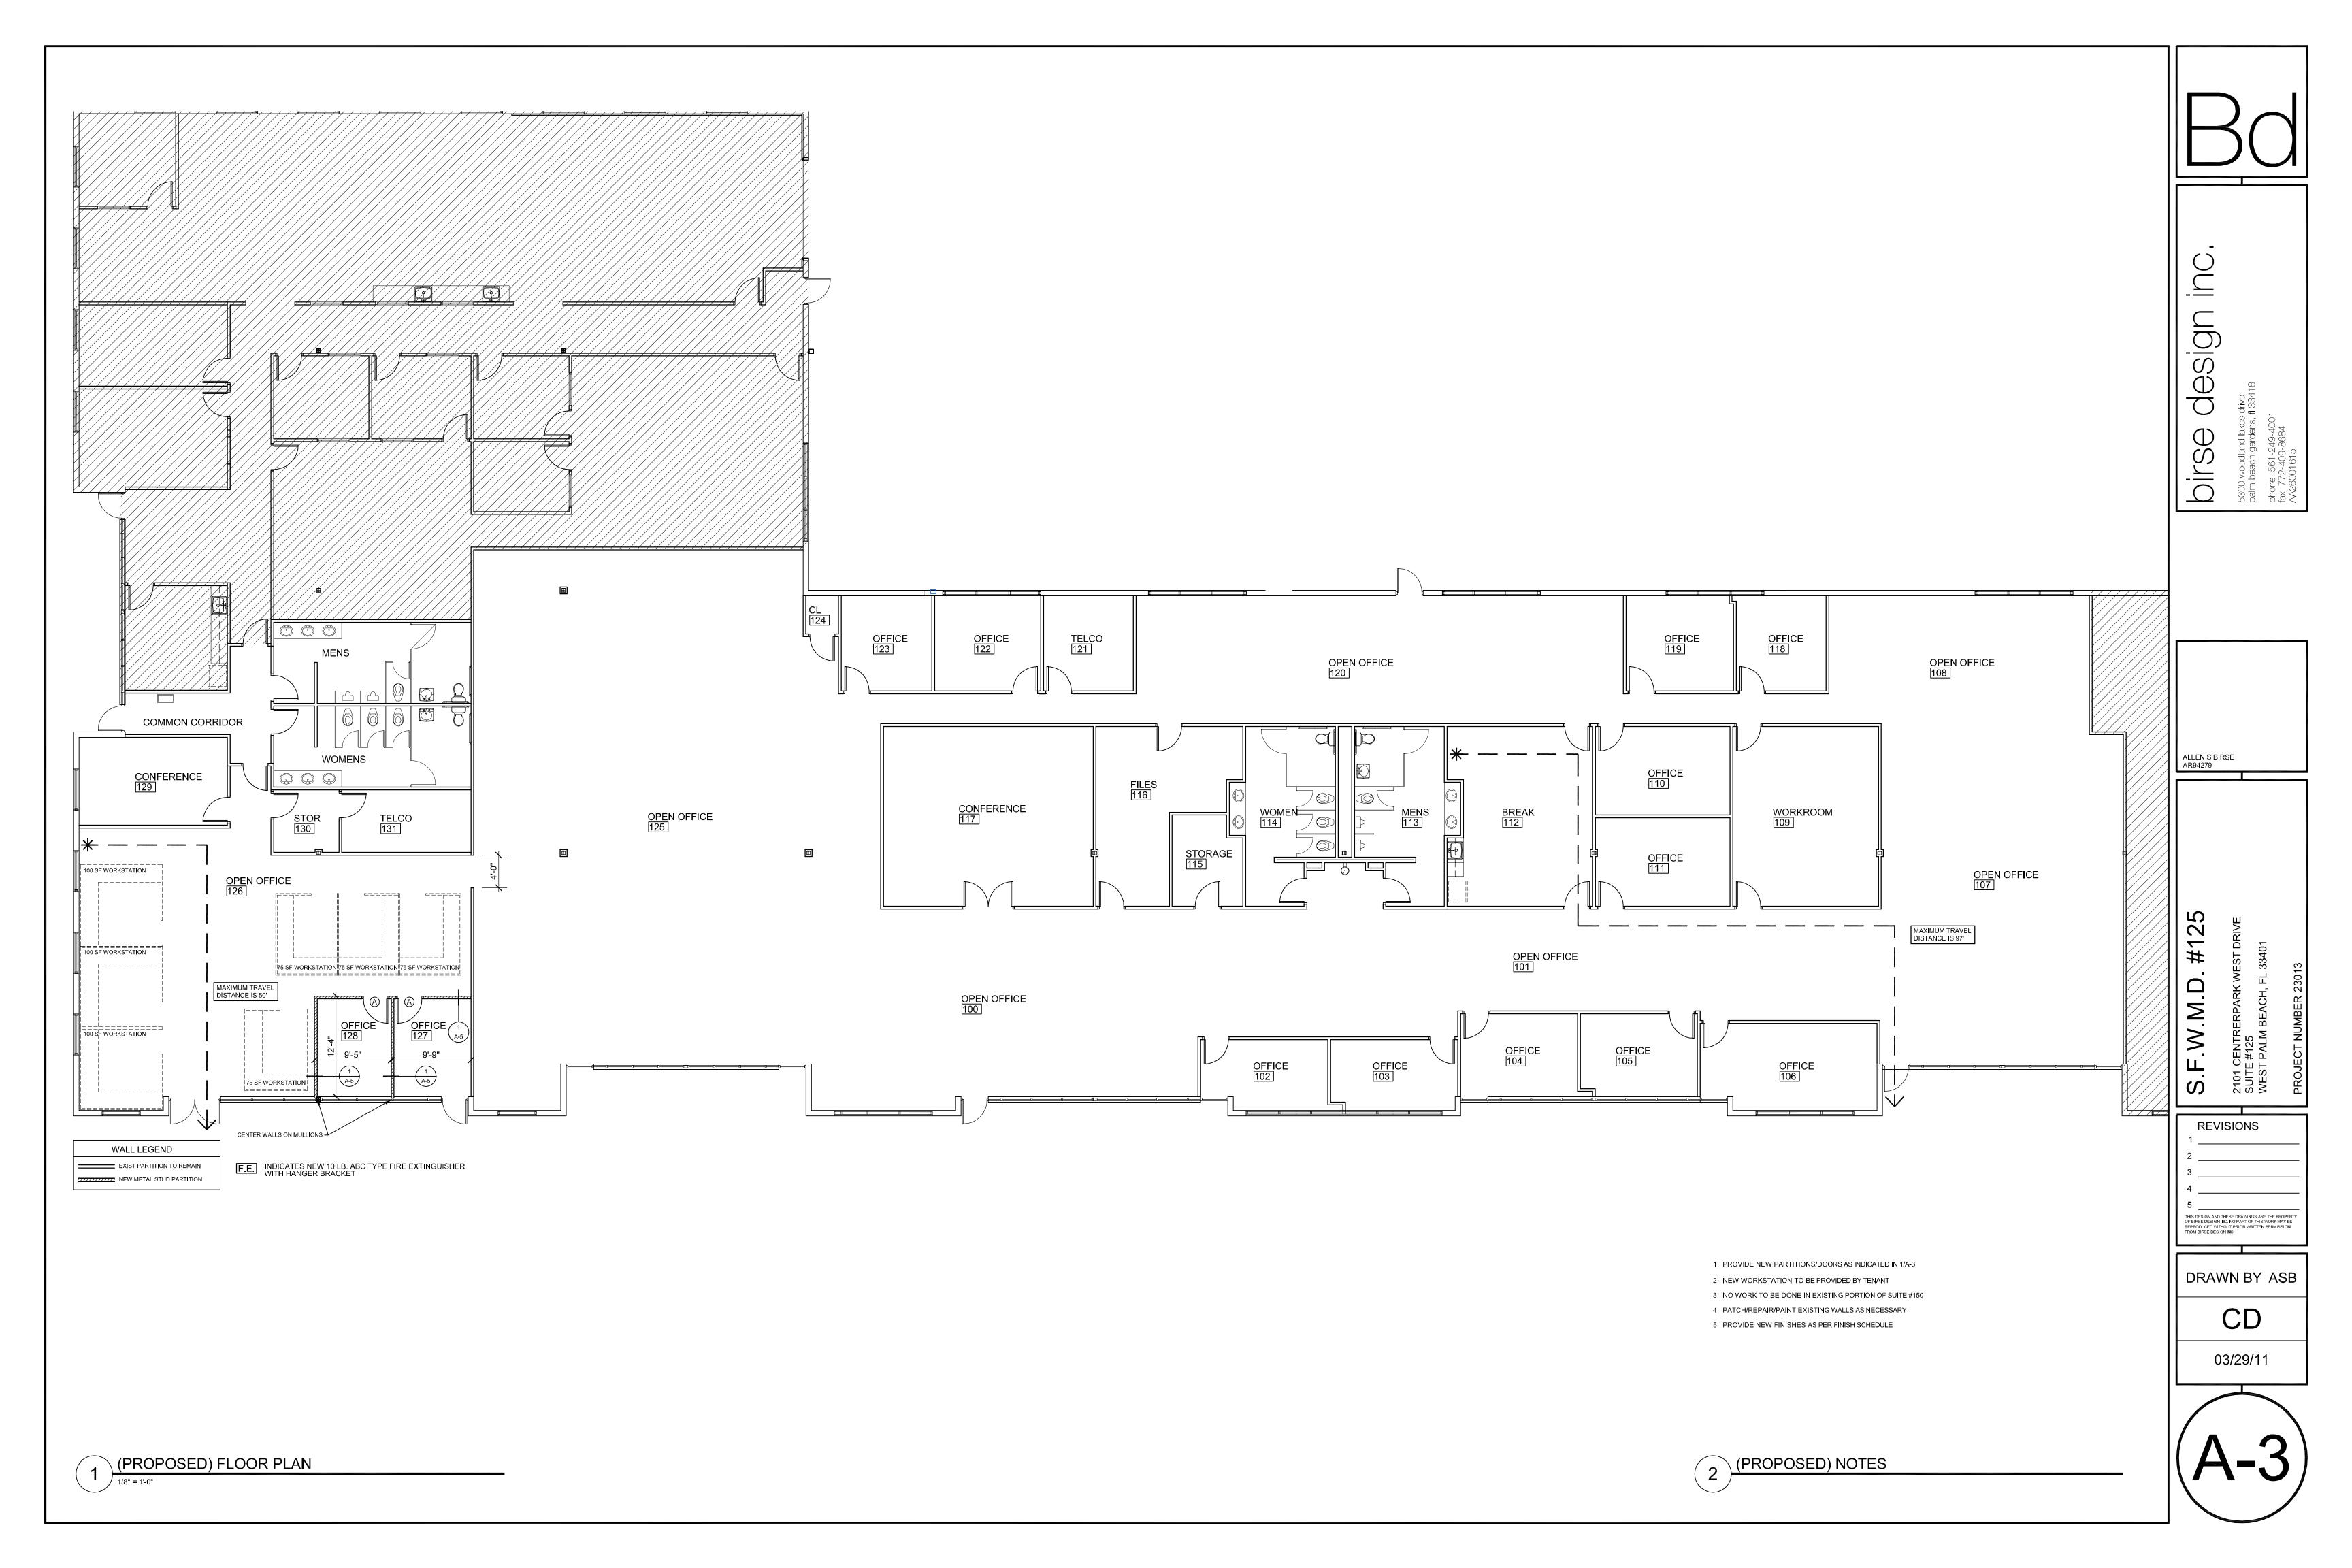

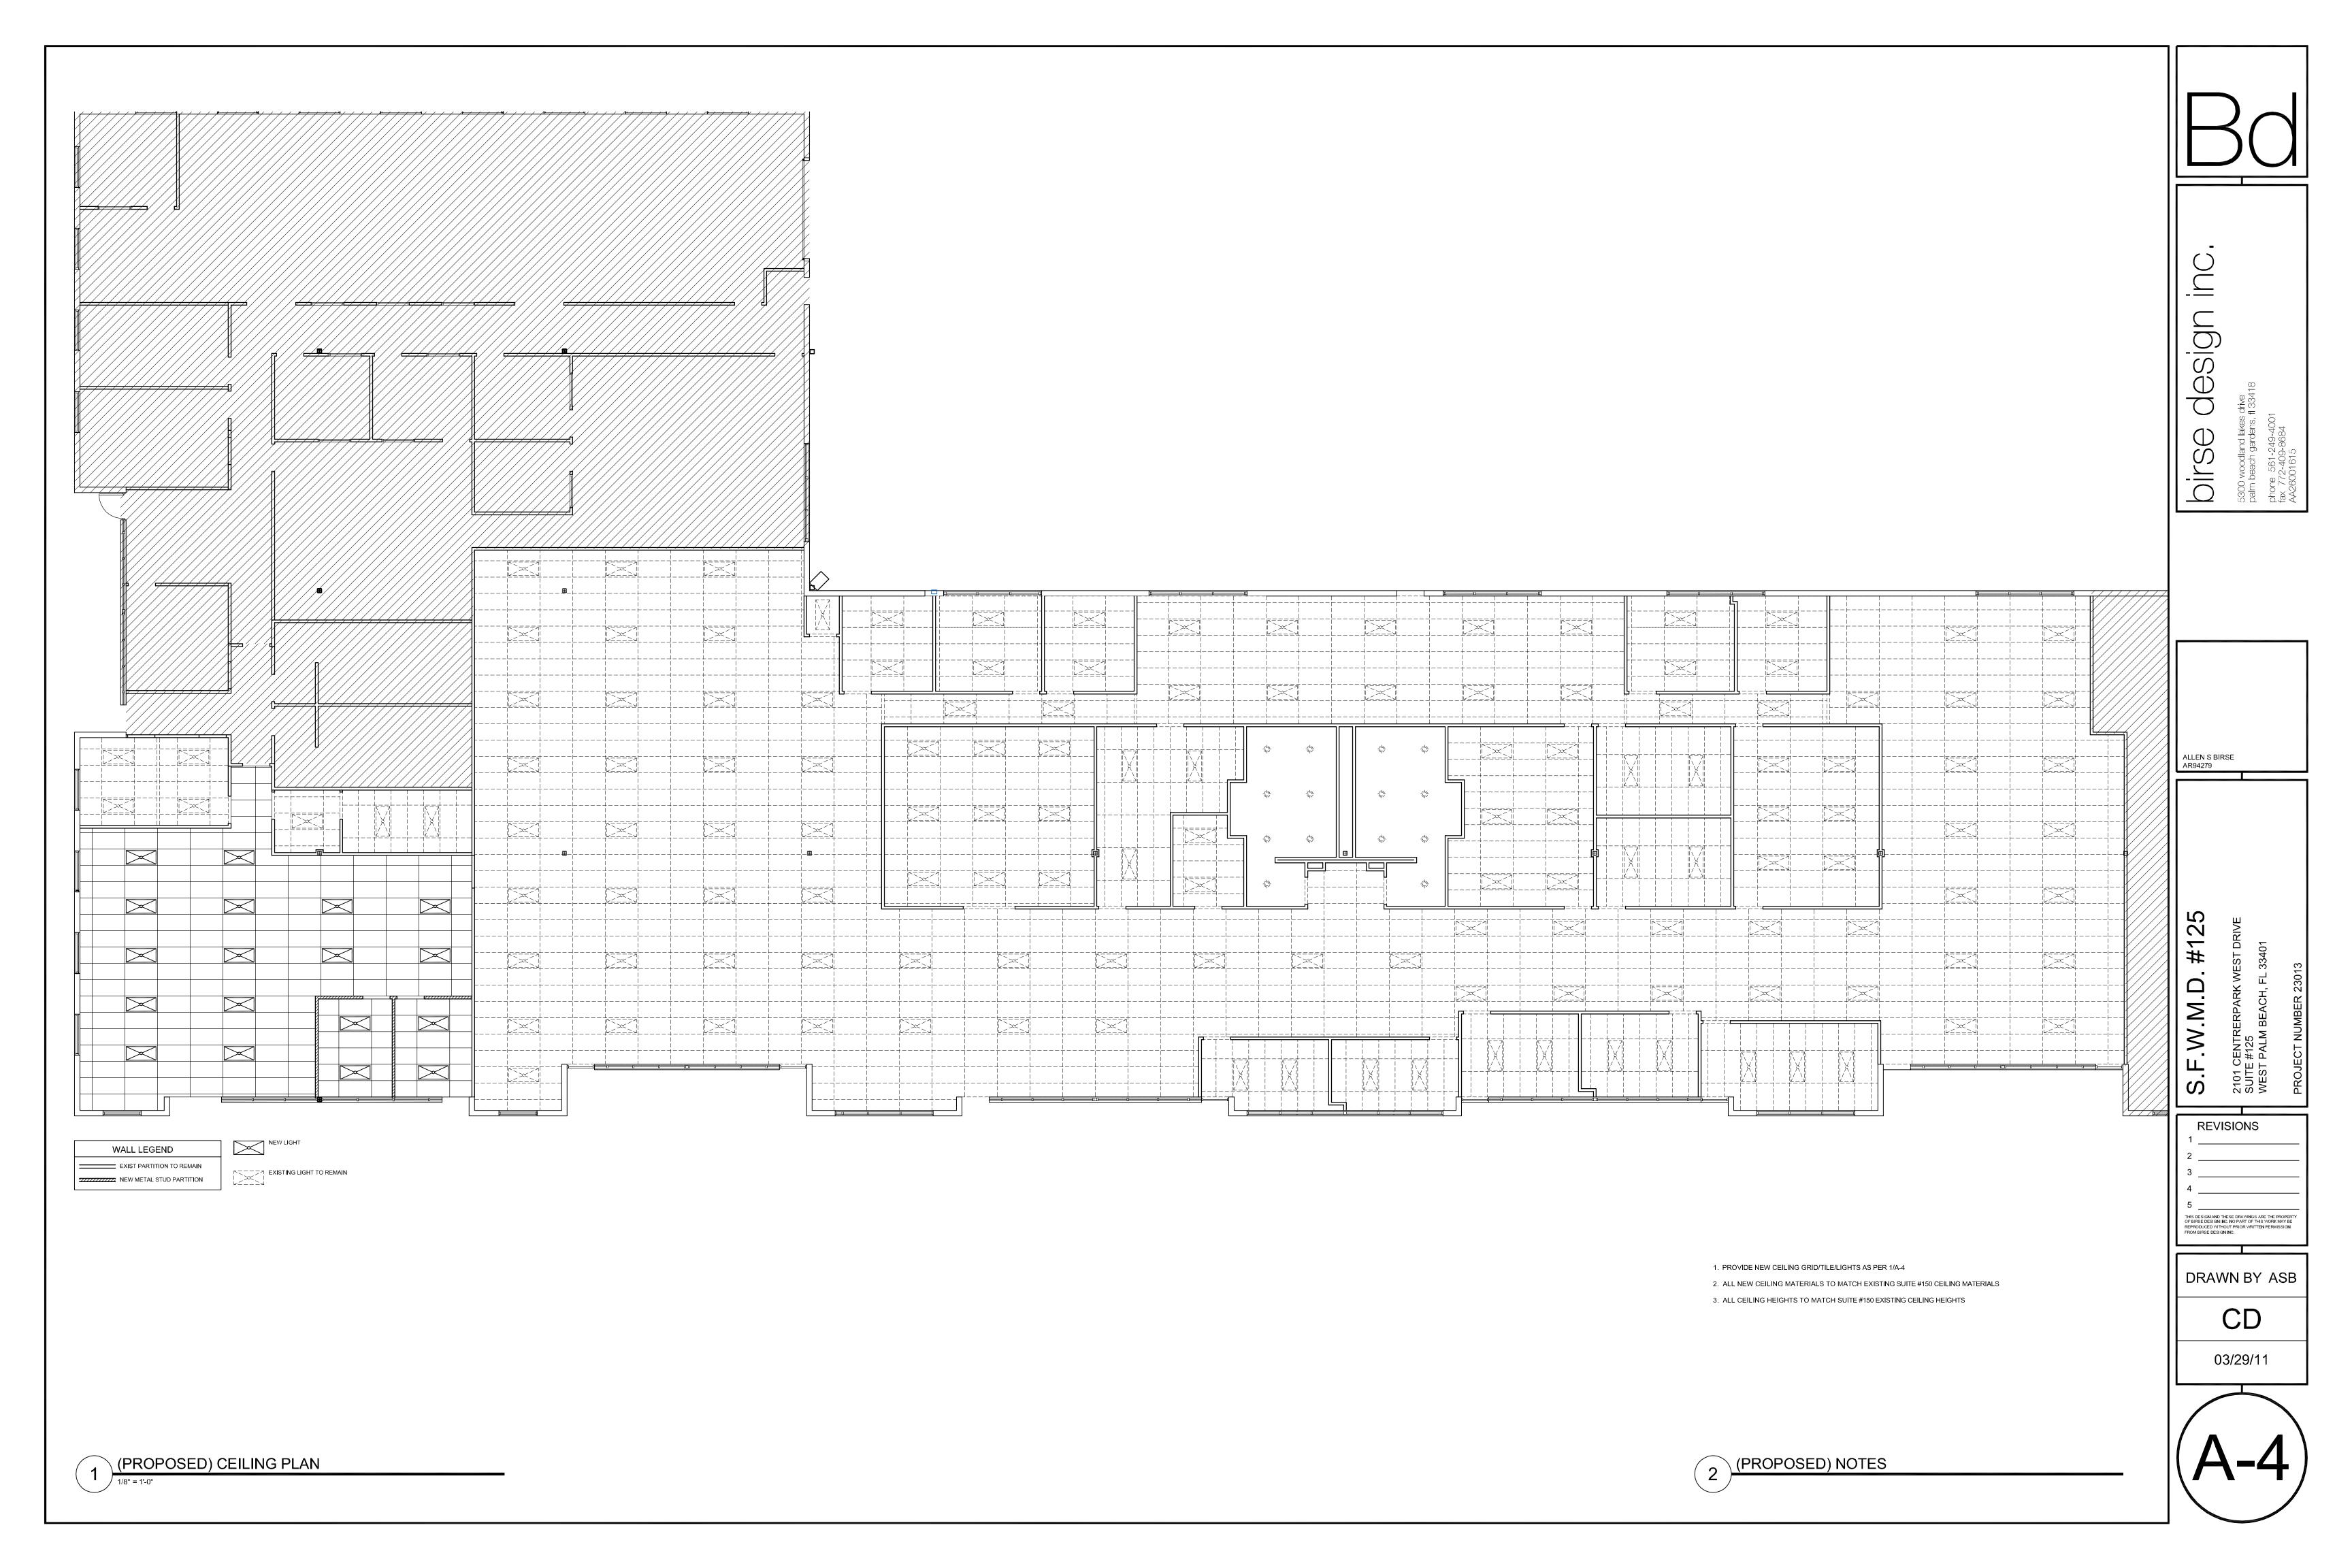

- * NEW TENANT ENTRY DOOR TO MATCH EXISTING BUILDING STANDARD
- * ALL CLOSERS TO BE ON THE INSIDE OF TENANT SPACE
- * NEW TENANT INTERIOR DOOR HARDWARE TO MATCH BUILDING STANDARD
- * DOOR HARDWARE IS REQUIRED TO COMPLY WITH FBC 11-4.13.9 FOR ACCESSIBILITY

DOOR SCHEDULE


MADIC	1.4051			DOOR			FRAME	
MARK	LABEL	NAAT	TVDE		SIZE		SIZE/MAT.	REMARKS
		MAT	TYPE	W	Н	Т		
Α		WD	FLUSH	3'0"	MATCH	1-3/4"	2" HM	GLASS SIDE LIGHT

SILL / HEAD SIM 5/8" GYPSUM BOARD 3-5/8" METAL STUDS (EXCEPT AS NOTED ON PLAN) SOLID CORE WOOD DOOR - SEE PLAN FOR SIZE	Bo
SPOT GROUT FRAME @ ANCHORS 6" HOLLOW METAL JAMB WY MIN. (3) ANCHORS PER JAMB (8-3/8" JAMB @ 6" WALL) 5/8" GYPSUM BOARD	ssign inc.
	5300 woodland lakes drive palm beach gardens, fl 33418 phone 561-249-4001 fax 772-409-8684 AA26001615

* CABS/SINK ARE EXISTING (NO WORK TO BE DONE)

1 WALL TYPE (INTERIOR PARTITION)

3/4" = 1'-0"

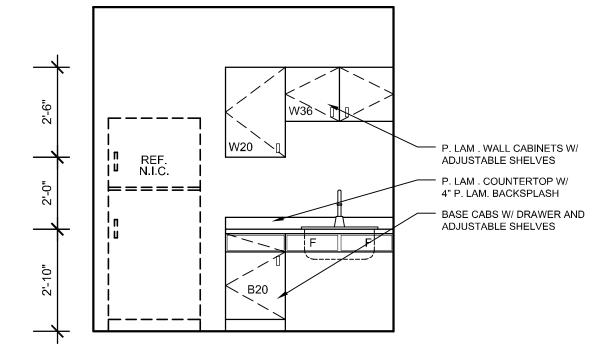

* SINKS SHALL BE MOUNTED WITH THE COUNTER TOP OR RIM NO HIGHER THAN 34" ABOVE THE

- * KNEE CLEARANCE OF AT LEAST 27" HIGH, 30" WIDE, AND 19" DEEP IS PROVIDED UNDERNEATH
- * EACH SINK SHALL BE A MAXIMUM OF 6-1/2" DEEP
- * HOT WATER AND DRAIN PIPES UNDER SINK SHALL BE INSULATED OR OTHERWISE CONFIGURED SO AS TO PROTECT AGAINST CONTACT. THERE SHALL BE NO SHARP OR ABRASIVE SURFACES
- * A CLEAR FLOOR SPACE OF AT LEAST 30" BY 48" SHALL BE PROVIDED IN FRONT OF A SINK TO ALLOW FORWARD APPROACH. THE CLEAR FLOOR SPACE SHALL BE ON AN ACCESSABLE ROUT AND SHALL EXTEND A MAXIMUM OF 19 INCHES UNDERNEATH THE SINK
- * 19" MAX CLEAR AREA SHALL BE PROVIDED UNDERNEATH SINK
- * ALL FAUCETS SHALL BE LEVER OPERATED

N /11/		FLOOR	BA:	SE	WALLS		CE	ILIN	G	DEMADIC
MK	ROOM NAME	MAT MAT HT MAT FIN MAT FI		FIN	НТ	REMARKS				
SUITE #1	110	•								
100	OPEN OFFICE	EXISTING -							\longrightarrow	
101	OPEN OFFICE	EXISTING -							\longrightarrow	
102	OFFICE	EXISTING -							\longrightarrow	
103	OFFICE	EXISTING -							\longrightarrow	
104	OFFICE	EXISTING -							\longrightarrow	
105	OFFICE	EXISTING -							\longrightarrow	
106	OFFICE	EXISTING -							\longrightarrow	
107	OPEN OFFICE	EXISTING -							\longrightarrow	
108	OPEN OFFICE	EXISTING -							\longrightarrow	
109	WORKROOM	EXISTING -							\longrightarrow	
110	OFFICE	EXISTING -							\longrightarrow	
111	OFFICE	EXISTING -							\longrightarrow	
112	BREAK	EXISTING -							\longrightarrow	
113	MENS	EXISTING -							\longrightarrow	
114	WOMENS	EXISTING -							\longrightarrow	
115	STORAGE	EXISTING -							\longrightarrow	
116	FILES	EXISTING -							\longrightarrow	
117	CONFERENCE	EXISTING -							\longrightarrow	
118	OFFICE	EXISTING -							\longrightarrow	
119	OFFICE	EXISTING -							\longrightarrow	
120	OPEN OFFICE	EXISTING -							\longrightarrow	
121	TELCO	EXISTING -							\longrightarrow	
122	OFFICE	EXISTING -							\longrightarrow	
123	OFFICE	EXISTING -							\longrightarrow	
124	CLOSET	EXISTING -							\longrightarrow	
125	OPEN OFFICE	EXISTING -							\longrightarrow	
126	OPEN OFFICE	CPT1	VL	4"	GWB	PT1	ACT1		\longrightarrow	
127	OFFICE	CPT1	VL	4"	GWB	PT1	ACT1	-	\longrightarrow	
128	OFFICE	CPT1	VL	4"	GWB	PT1	ACT1		\longrightarrow	
129	CONFERENCE	CPT1	VL	4"	GWB	PT1	ACT1		\longrightarrow	
130	STORAGE	VCT	VL	4"	GWB	PT1	ACT1		\longrightarrow	
131	TELCO	VCT	VL	4"	GWB	PT1	ACT1		\longrightarrow	

FINISH SELECTIONS

PAINT (PT1)

MANUFACTURER: PITTSBURGH PAINTS COLOR: BLUE HAZE #555-1, FLAT TYPE: "ECO-SPEC" NO VOC PAINT

CARPET (CPT1)

MANUFACTURER: PATCRAFT STYLE: MANNER BOOK #10247 COLOR: SHOTGUN #47407

VINYL COMP TILE (VCT)

MANUFACTURER: ARMSTRONG STYLE: STANDARD EXCELON

COLOR: BLUE CLOUD #51933 VINYL BASE (VL)

COLOR: OCEAN #189

ACOUSTIC CEILING TILE (ACT1)

MANUFACTURER: JOHNSONITE

MANUFACTURER: MATCH EXISTING COLOR: AMATCH EXISTING

* ALL INTERIOR WALL AND CEILING FINISHES TO HAVE A MIN CLASS "C" FLAME SPREAD CLASSIFICATION

* ALL INTERIOR FLOOR FINISH SHALL BE NOT LESS THAN CLASS II

* SAMPLES ARE REQUIRED TO BE APPROVED PRIOR TO ORDERING

ALLEN S BIRSE AR94279

#125

S.F.W.M.D.


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03/29/11

	SUITE #100 BREAK (#109) ELEVATION
\ 4	3/8" = 1'-0"



MECHANICAL GENERAL NOTES:


- THESE DRAWINGS ARE DIAGRAMMATIC. ALL OFFSETS, FITTINGS, TRANSITIONS AND ACCESSORIES ARE NOT SHOWN. THE CONTRACTOR SHALL INCLUDE IN HIS BID ALL ITEMS REQUIRED TO PROVIDE A COMPLETE AND OPERATIONAL SYSTEM. DO NOT SCALE DRAWINGS FOR INSTALLATION.
- ALL WORK SHALL BE PERFORMED IN A FIRST CLASS WORKMANLIKE MANNER BY LICENSED CONTRACTORS.
- THE CONTRACTOR SHALL OBTAIN AT HIS EXPENSE ALL NECESSARY FEES PERMITS, AND TESTS.
- ALL WORK SHALL CONFORM TO ALL APPLICABLE LOCAL, STATE AND NATIONAL CODES. NO CONTRACTOR SHALL BID UNLESS FAMILIAR WITH THESE CODES.
- CORRECTION OF DEFECTS TO THIS WORK SHALL BE MADE PROMPTLY WITHOUT CHARGE TO THE OWNER. REPAIR AND REPLACEMENT FOR DAMAGE CAUSED BY THIS CONTRACTOR SHALL BE MADE PROMPTLY WITHOUT CHARGE TO THE OWNER.
- ALL WORK OF THIS TRADE SHALL BE COORDINATED WITH ALL OTHER TRADES TO AVOID ANY INTERFERENCES THAT MAY DELAY PROGRESS OF CONSTRUCTION.
- THE CONTRACTOR SHALL INCLUDE THE WORK OF ALL REQUIRED SUB-CONTRACTORS, SUCH AS ELECTRICAL, INSULATING, TEST & BALANCE, ETC., AS REQUIRED FOR A COMPLETE AND OPERATIONAL SYSTEM.
- EQUIPMENT SHALL BEAR A U.L. OR OTHER RECOGNIZED LABEL,
- NAMEPLATES. WIRING DIAGRAMS. AND ENERGY RATINGS AS APPLICABLE. THE CONTRACTOR SHALL INSTALL ALL EQUIPMENT AND ACCESSORIES TO BE
- 10. THE CONTRACTOR SHALL PROVIDE A WRITTEN GUARANTEE AGAINST DEFECTS IN ALL MATERIALS AND WORKMANSHIP FOR ONE YEAR FROM ACCEPTANCE, WITH FOUR ADDITIONAL YEARS OF WARRANTY ON COMPRESSORS.

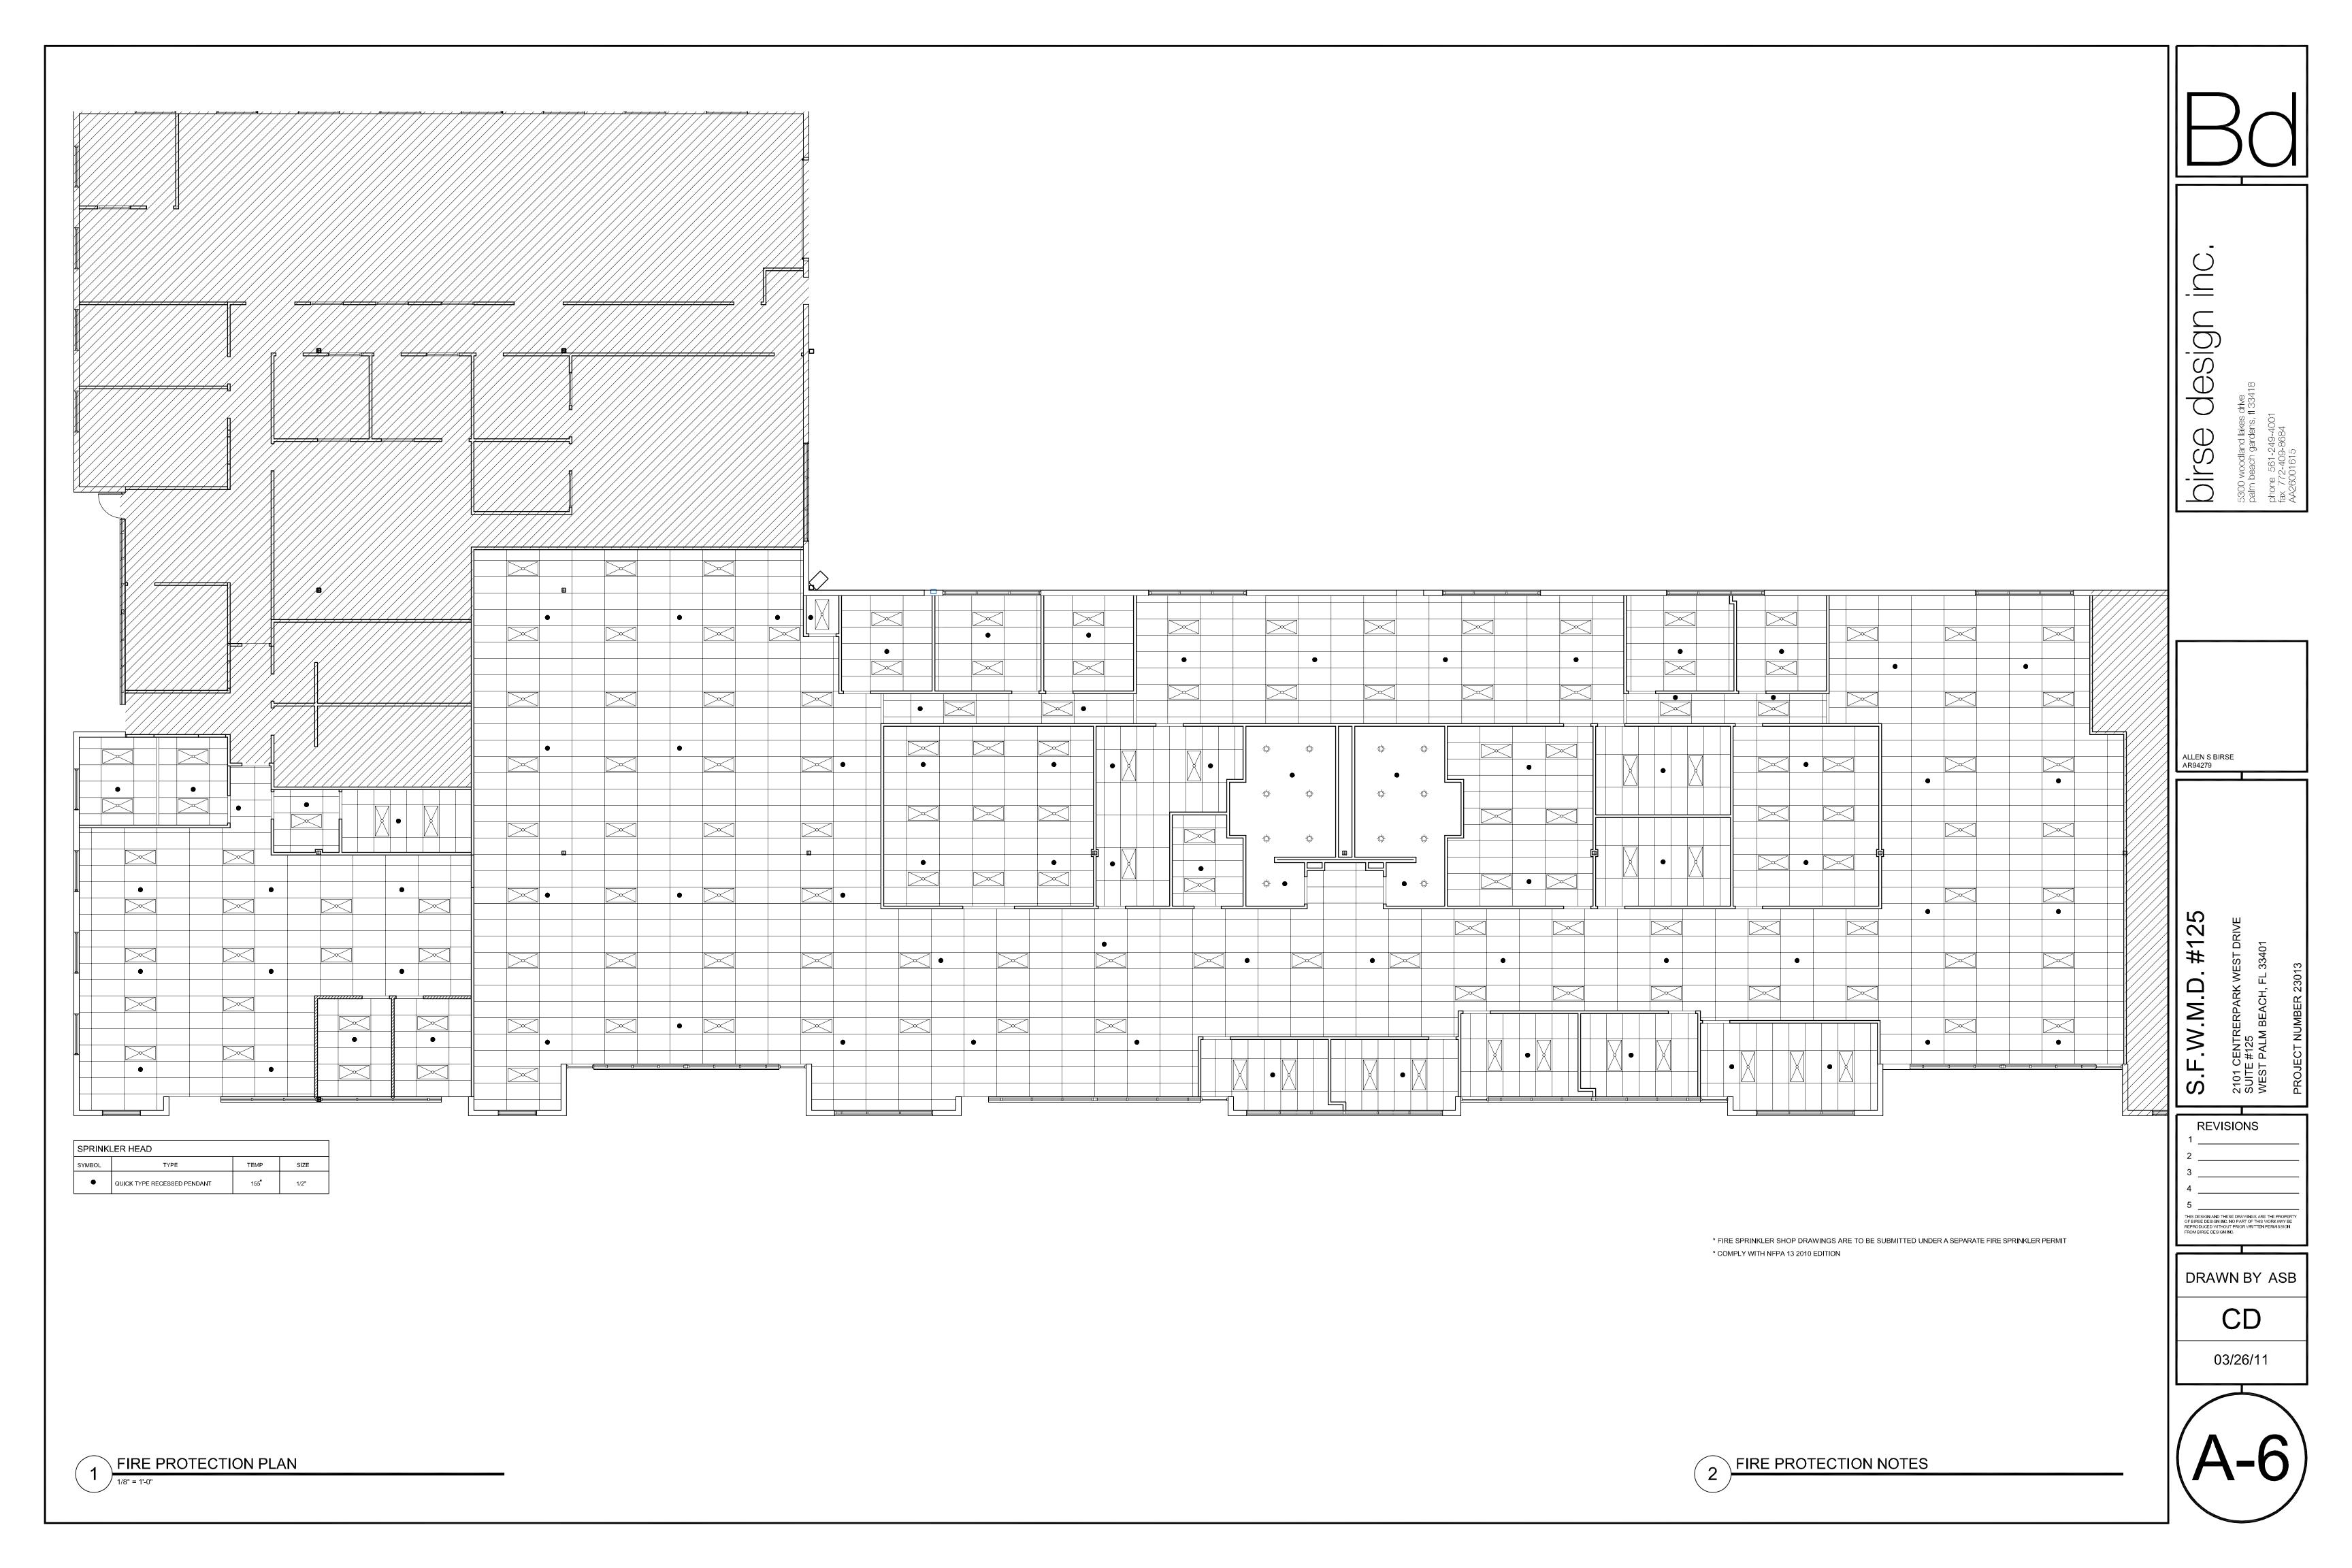READLY ACCESSIBLE FOR SERVICING, TESTING, BALANCING, AND REPLACEMENT.

- THE CONTRACTOR SHALL PROVIDE THREE COPIES OF SUBMITTAL DATA, SHOP DRAWINGS, AND AT COMPLETION OF THE PROJECT TWO SETS OF OPERATION AND MAINTENANCE MANUALS FOR ALL PROJECT ITEMS.
- 12. PROVIDE ALL CONTROLS, STARTERS, CONTROL WIRING, DISCONNECTS, AND OTHER ELECTRICAL EQUIPMENT AS REQUIRED FOR A COMPLETE AND OPERATIONAL SYSTEM.
- THE HVAC CONTRACTOR IS RESPONSIBLE FOR MAINTAINING, ON SITE, A DETAILED AS-BUILT PLAN SHOWING ACTUAL INSTALLATIONS. THE CONTRACTOR IS TO PROVIDE A NEATLY DRAWN COMPREHENSIVE AS-BUILT SET OF PLANS UPON COMPLETION, WHICH ARE SUITABLE FOR SUBMISSION TO THE BUILDING DEPARTMENT AND TO THE OWNER.
- 14. PRIOR TO ACCEPTANCE BY THE OWNER THE SYSTEMS SHALL BE TESTED AND BALANCED BY THE CONTRACTOR. PROVIDE A WRITTEN REPORT.
- 15. SUPPLY AND INSTALL DUCT MOUNTED SMOKE DETECTORS AS REQUIRED.
- 16. COORDINATE LOCATION OF CEILING DIFFUSERS, GRILLES AND REGISTERS IN THE FIELD WITH LIGHTS AND ARCHITECTURAL ELEMENTS.
- 17. ALL GRILLES TO BE TITUS OR METALLAIRE UNLESS OTHERWISE NOTED, SIZES AS SHOWN ON PLANS, ALUMINUM CONSTRUCTION.
- 18. ALL DUCT WORK SHALL BE BUILT AND INSTALLED IN ACCORDANCE WITH
- SMACNA STANDARDS AND LOCAL BUILDING CODES. 19. ALL DUCT SIZES ARE CLEAR INSIDE DIMENSIONS.
- 20. ALL OUTSIDE AIR DUCTWORK SHALL BE SHEETMETAL WITH EXTERIOR R-6 INSULATION. PROVIDE BLANKET TYPE INSULATION IN CONCEALED SPACES, AND BOARD TYPE IN EXPOSED AREAS.
- 21. ALL EXHAUST AIR DUCT SHALL BE GALVANIZED SHEET METAL CONSTRUCTED
- AND INSTALLED IN ACCORDANCE WITH ASHRAE AND SMACNA STANDARDS. 22. FLEXIBLE DUCT, WHERE SHOWN, SHALL BE U.L. CLASS 1, R-6 INSULATION.
- 23. LOW PRESSURE SUPPLY AND RETURN RECTANGULAR DUCTWORK IS RIGID
- DUCTBOARD, 1 IN. THICK, R-4.2 INSULATION. 24. PROVIDE ELBOW TURNING VANES IN ALL RECTANGULAR DUCTS WHERE TURNS
- ARE GREATER THAN 45 DEGREES. 25. PROVIDE BACKDRAFT DAMPERS FOR ALL EXHAUST FANS.
- 26. VERIFY ALL THERMOSTAT LOCATIONS WITH THE LANDLORD.
- 27. CONDENSATE DRAIN PIPING SHALL BE ABOVE GRADE COPPER DRAIN, WASTE AND VENT FITINGS. INSULATE ALL CONDENSATE PIPING W/3/4" IMCOA IMCOLOCK PIPE INSULATION.

GENERAL DEMOLITION NOTES

- UNLESS OTHERWISE NOTED, ALL EQUIPMENT AND DUCTWORK IN THE PROJECT AREA WHICH IS NOT INDICATED TO REMAIN, IS TO BE REMOVED. THE CONTRACTOR SHALL INVESTIGATE THE PROJECT AREA PRIOR TO BID TO DETERMINE ALL REQUIRED DEMOLITION.
- EXISTING CONDITIONS SHOWN ON THIS DRAWING ARE TAKEN FROM ORIGINAL DRAWINGS AND FIELD INVESTIGATION. ALL EXISTING CONDITIONS MUST BE VERIFIED PRIOR TO BID. FIELD CONDITIONS SHALL GOVERN.
- DEMOLITION WORK IS NOT SPECIFICALLY IDENTIFIED ON THESE PLANS, AND MAY BE DESCRIBED ON THE ARCHITECTS PLANS. THE CONTRACTOR IS RESPONSIBLE FOR ALL REQUIRED DEMOLITION WHETHER SHOWN ON THE PLANS OR NOT.
- 4. ALL MECHANICAL SYSTEMS SERVING OTHER SPACES OR FLOORS, THAT RUN THROUGH THE PROJECT AREA SHALL REMAIN ACTIVE DURING CONSTRUCTION, SO AS NOT TO CAUSE ANY DISRUPTION TO THESE OTHER SPACES.
- 5. ALL ITEMS REMOVED UNDER THIS PROJECT SHALL BE DISPOSED OF OR TURNED OVER TO THE OWNER AT THE OWNER'S DISCRETION.
- PROPERLY REMOVE AND DISPOSE OF ALL HVAC DUCTWORK AND AIR DISTRIBUTION DEVICES WHICH ARE TO BE REMOVED. CONSULT WITH OWNER AND OBTAIN THE OWNER'S APPROVAL PRIOR TO DISPOSAL OF REMOVED MATERIAL.
- 7. IT IS THE CONTRACTOR'S RESPONSIBILITY TO ENSURE THAT ALL PIPING AND DUCTS, NEW OR EXISTING, WITHIN THE PROJECT AREA, ARE PROPERLY SUPPORTED.
- 8. ALL OCCUPIED SPACES ARE TO REMAIN OPERATIONAL DURING BUSINESS HOURS THROUGHOUT THE DEMOLITION AND CONSTRUCTION PERIOD. COORDINATE ALL WORK AS DESCRIBED IN THE ARCHITECTS DOCUMENTS.

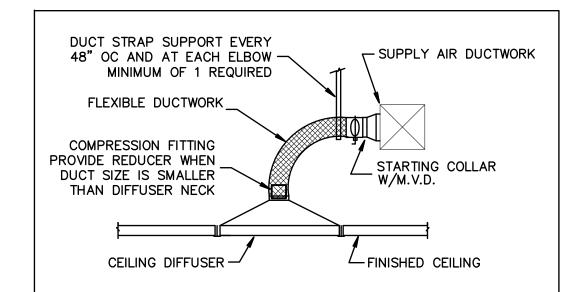

NOTE: DO NOT PROVIDE DUCT TAKE-OFF WITH VOLUME DAMPER ABOVE INACCESSIBLE CEILINGS, PROVIDE DAMPER AT DIFFUSER.

CEILING DIFFUSER DETAIL

\	√ENTIL	ATION	CALCUL	ATIONS		
SYSTEM	AHU-1			AHU-2		
AREA TYPE	OFFICE	OFFICE	CORRIDOR	ELECT.	CONFERENCE	STORAGE
SQUARE FEET OF AREA	614	920	186	128	196	64
CFM/SQ.FT. REQUIRED	0.06	0.06	0.06	0.06	0.06	0.12
TOTAL OCCUPANTS	4	5	_	1	10	1
CFM/PERSON REQUIRED	5	5	_	ı	5	1
ZONE CFM REQUIRED		80	11	8	62	8
TOTAL SYSTEM CFM	56					169
<u>NOTES</u>						

1. ABOVE CALCULATIONS AND OCCUPANCY RATES PER ASHRAE 62.1, 2004.

ABBREVIATIONS S/A SUPPLY AIR

RETURN AIR OUTSIDE AIR

EXHAUST AIR CUBIC FEET PER MINUTE.

MANUAL VOLUME DAMPER (OPPOSED BLADE TYPE).

FIRE DAMPER FD

AIR HANDLING UNIT CONDENSING UNIT

EXISTING

RELOCATED

ROOFCAP

HVAC PROJECT SPECIFIC NOTES

CONTRACTOR IS TO INSPECT ALL EXISTING DUCTWORK SHOWN ON THESE PLANS AS REMAINING. REPAIR AS REQUIRED ANY DAMAGED DUCTWORK OR INSULATION. WHERE DUCTWORK IS SHOWN TO BE PARTIALLY REMOVED, CAP, SEAL, AND INSULATE TO MATCH EXISTING METHODS AND MATERIALS.

PROVIDE NEW FLEXIBLE DUCT

DUCTS AS REQUIRED. EXISTING

TAKE-OFFS MAY BE RE-USED

WHERE PROPERLY SIZED OR

PROVIDED WITH REDUCERS.

TAKE-OFFS FROM MAIN

EXISTING EQUIPMENT WHICH IS REMAINING IS TO BE INSPECTED, ADJUSTED AND REPAIRED WHERE NECESSARY.

LEGEND

EXISTING EQUIPMENT TO REMAIN

SUPPLY AIR DIFFUSER AS NOTED RETURN/TRANSFER AIR GRILLE AS NOTED

EXISTING SUPPLY AIR DIFFUSER

EXISTING EXHAUST/RETURN GRILLE DUCTWORK AS NOTED

--- EXISTING DUCTWORK TO REMAIN

TYPE B FIRE DAMPER W/ACCESS DOOR.

MANUAL VOLUME DAMPER

T PROGRAMMABLE THERMOSTAT

FLEXIBLE DUCT, U.L. CLASS 1

DUCT TRANSITION

FLEXIBLE DUCT TAKE-OFF WITH MVD


DUCT SMOKE DETECTOR WITH AUDIBLE AND VISIBLE INDICATORS


REMOTE TEST & INDICATOR STATION (FOR DUCT SMOKE DETECTOR)

CONNECTION TO EXISTING

DRAWING KEYNOTES:

- 1) EXISTING AIR HANDLING UNIT TO REMAIN AS IS. PROVIDE DUCT AND AIR OUTLET MODIFICATIONS AS INDICATED AND RE-BALANCE O/A AND ALL AIR OUTLETS AS INDICATED.
- 2) CONNECT NEW AIR DEVICES TO EXISTING DUCTWORK AS INDICATED. PROVIDE ANY MODIFICATIONS TO EXISTING DUCTWORK AS REQUIRED FOR NEW CONNECTIONS, FIELD VERIFY (TYPICAL).
- (3) RE-LOCATE EXISTING THERMOSTAT AND TEST/INDICATOR STATION FOR DUCT SMOKE DETECTOR AS SHOWN.
- (4) OUTSIDE AIR DUCT UP TO ROOF CAP, TO REMAIN AS IS (TYPICAL OF 2, NO WORK)
- EXISTING BATHROOMS SUPPLY AND EXHAUST SYSTEMS TO REMAIN AS IS (NO WORK)

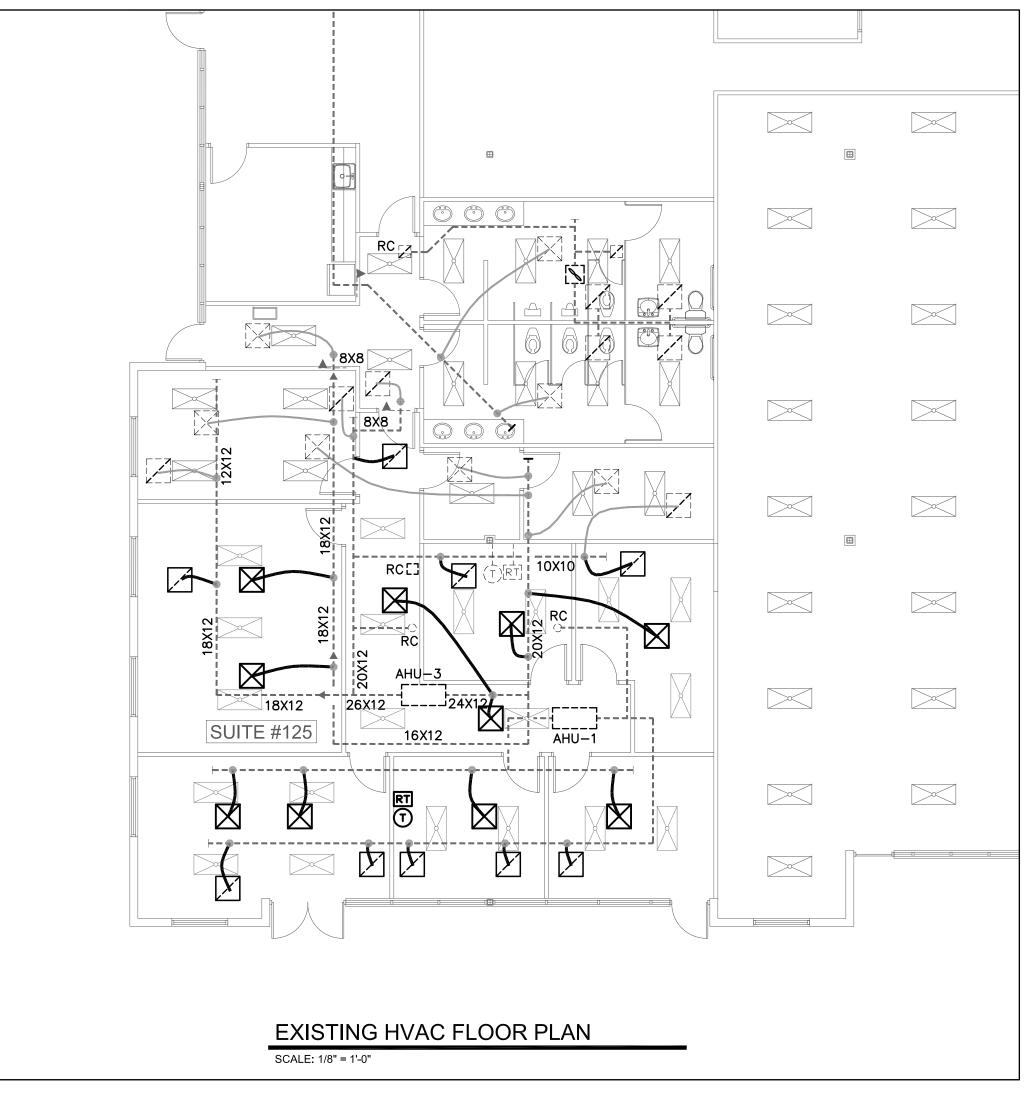

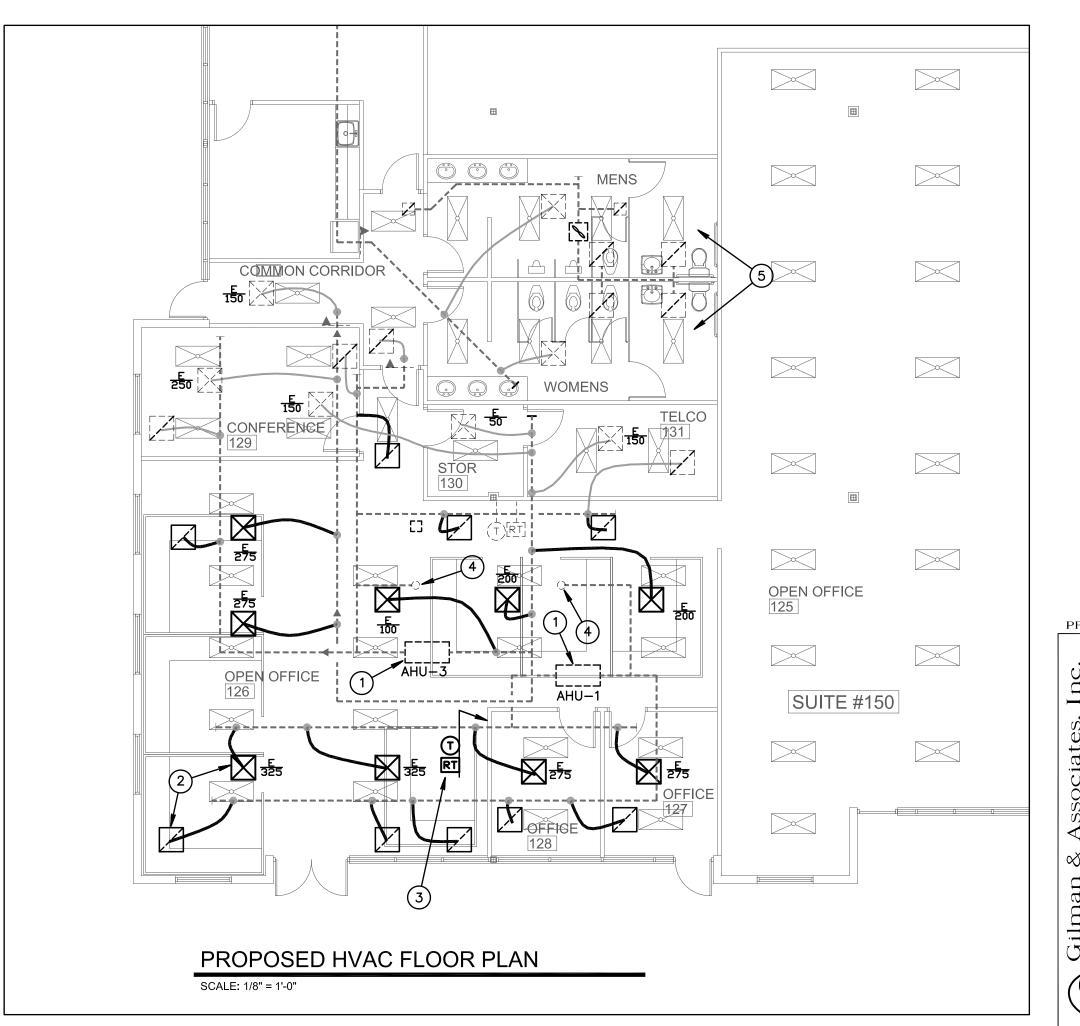







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2101 SUITI WES

REVISIONS


ROM BIRSE DESIGN INC.


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- 1. UNLESS OTHERWISE NOTED, ALL EQUIPMENT, WIRING DEVICES, LIGHT FIXTURES, CONDUIT AND WIRE IN THE PROJECT AREA WHICH IS NOT INDICATED TO REMAIN, IS TO BE REMOVED. THE CONTRACTOR SHALL INVESTIGATE THE PROJECT AREA PRIOR TO BID TO DETERMINE ALL REQUIRED DEMOLITION.
- 2. EXISTING CONDITIONS SHOWN ON THIS DRAWING ARE TAKEN FROM ORIGINAL DRAWINGS AND FIELD INVESTIGATION. ALL EXISTING CONDITIONS MUST BE VERIFIED PRIOR TO BID. FIELD CONDITIONS SHALL GOVERN.
- 3. DEMOLITION WORK IS NOT SPECIFICALLY IDENTIFIED ON THESE PLANS, AND MAY BE DESCRIBED ON THE ARCHITECTS PLANS. THE CONTRACTOR IS RESPONSIBLE FOR ALL REQUIRED DEMOLITION WHETHER SHOWN ON THE PLANS OR NOT.
- 4. ALL CONDUITS SERVING OTHER SPACES OR FLOORS, THAT RUN THROUGH THE PROJECT AREA SHALL REMAIN ACTIVE DURING CONSTRUCTION, SO AS NOT TO CAUSE ANY DISRUPTION TO THESE OTHER SPACES.
- ALL ITEMS REMOVED UNDER THIS PROJECT SHALL BE DISPOSED OF OR TURNED OVER TO THE OWNER AT THE OWNER'S DISCRETION.
- 6. PROPERLY REMOVE AND DISPOSE OF ALL ELECTRICAL EQUIPMENT, CONDUIT AND WIRING WHICH IS TO BE REMOVED. CONSULT WITH OWNER AND OBTAIN THE OWNERS APPROVAL PRIOR TO DISPOSAL OF REMOVED MATERIAL.
- 7. IT IS THE CONTRACTOR'S RESPONSIBLITY TO ENSURE THAT ALL CONDUITS, NEW OR EXISTING, WITHIN THE PROJECT AREA, ARE PROPERLY SUPPORTED AND PROVIDED WITH BONDING BUSHINGS IN ACCORDANCE WITH THE NATIONAL ELECTRIC CODE.





PROPOSED ELECTRICAL FLOOR PLAN

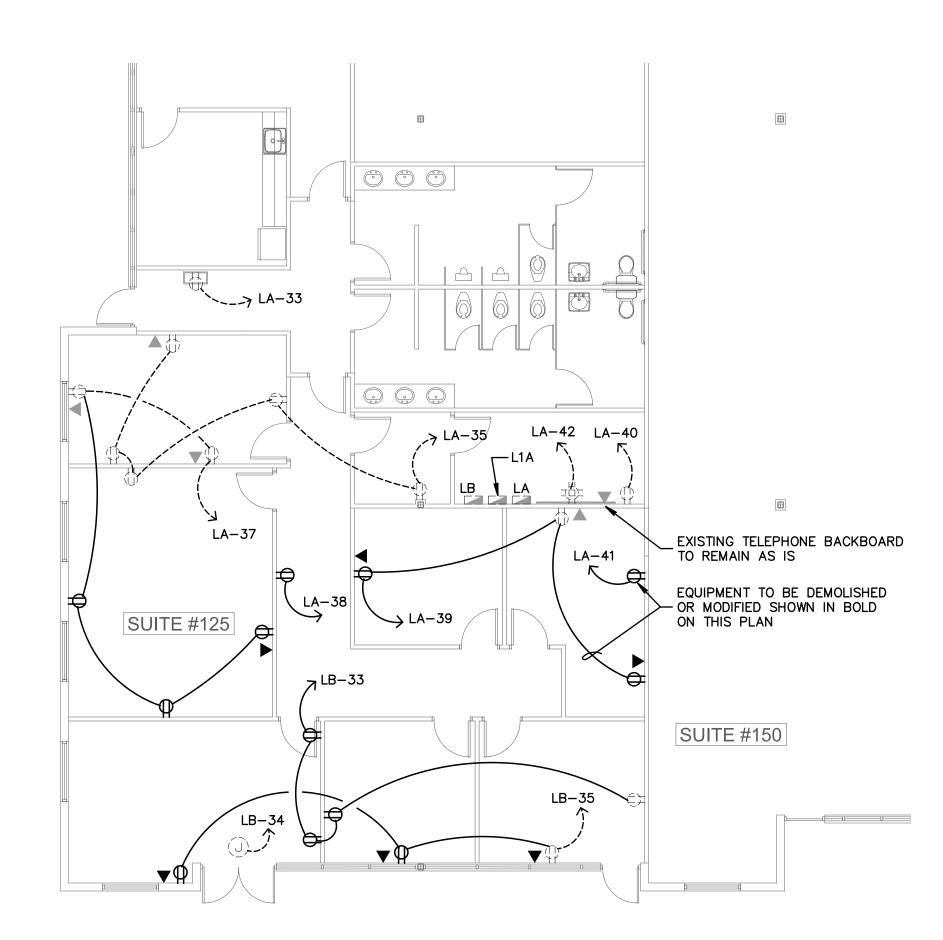SCALE: 1/8" = 1'-0"

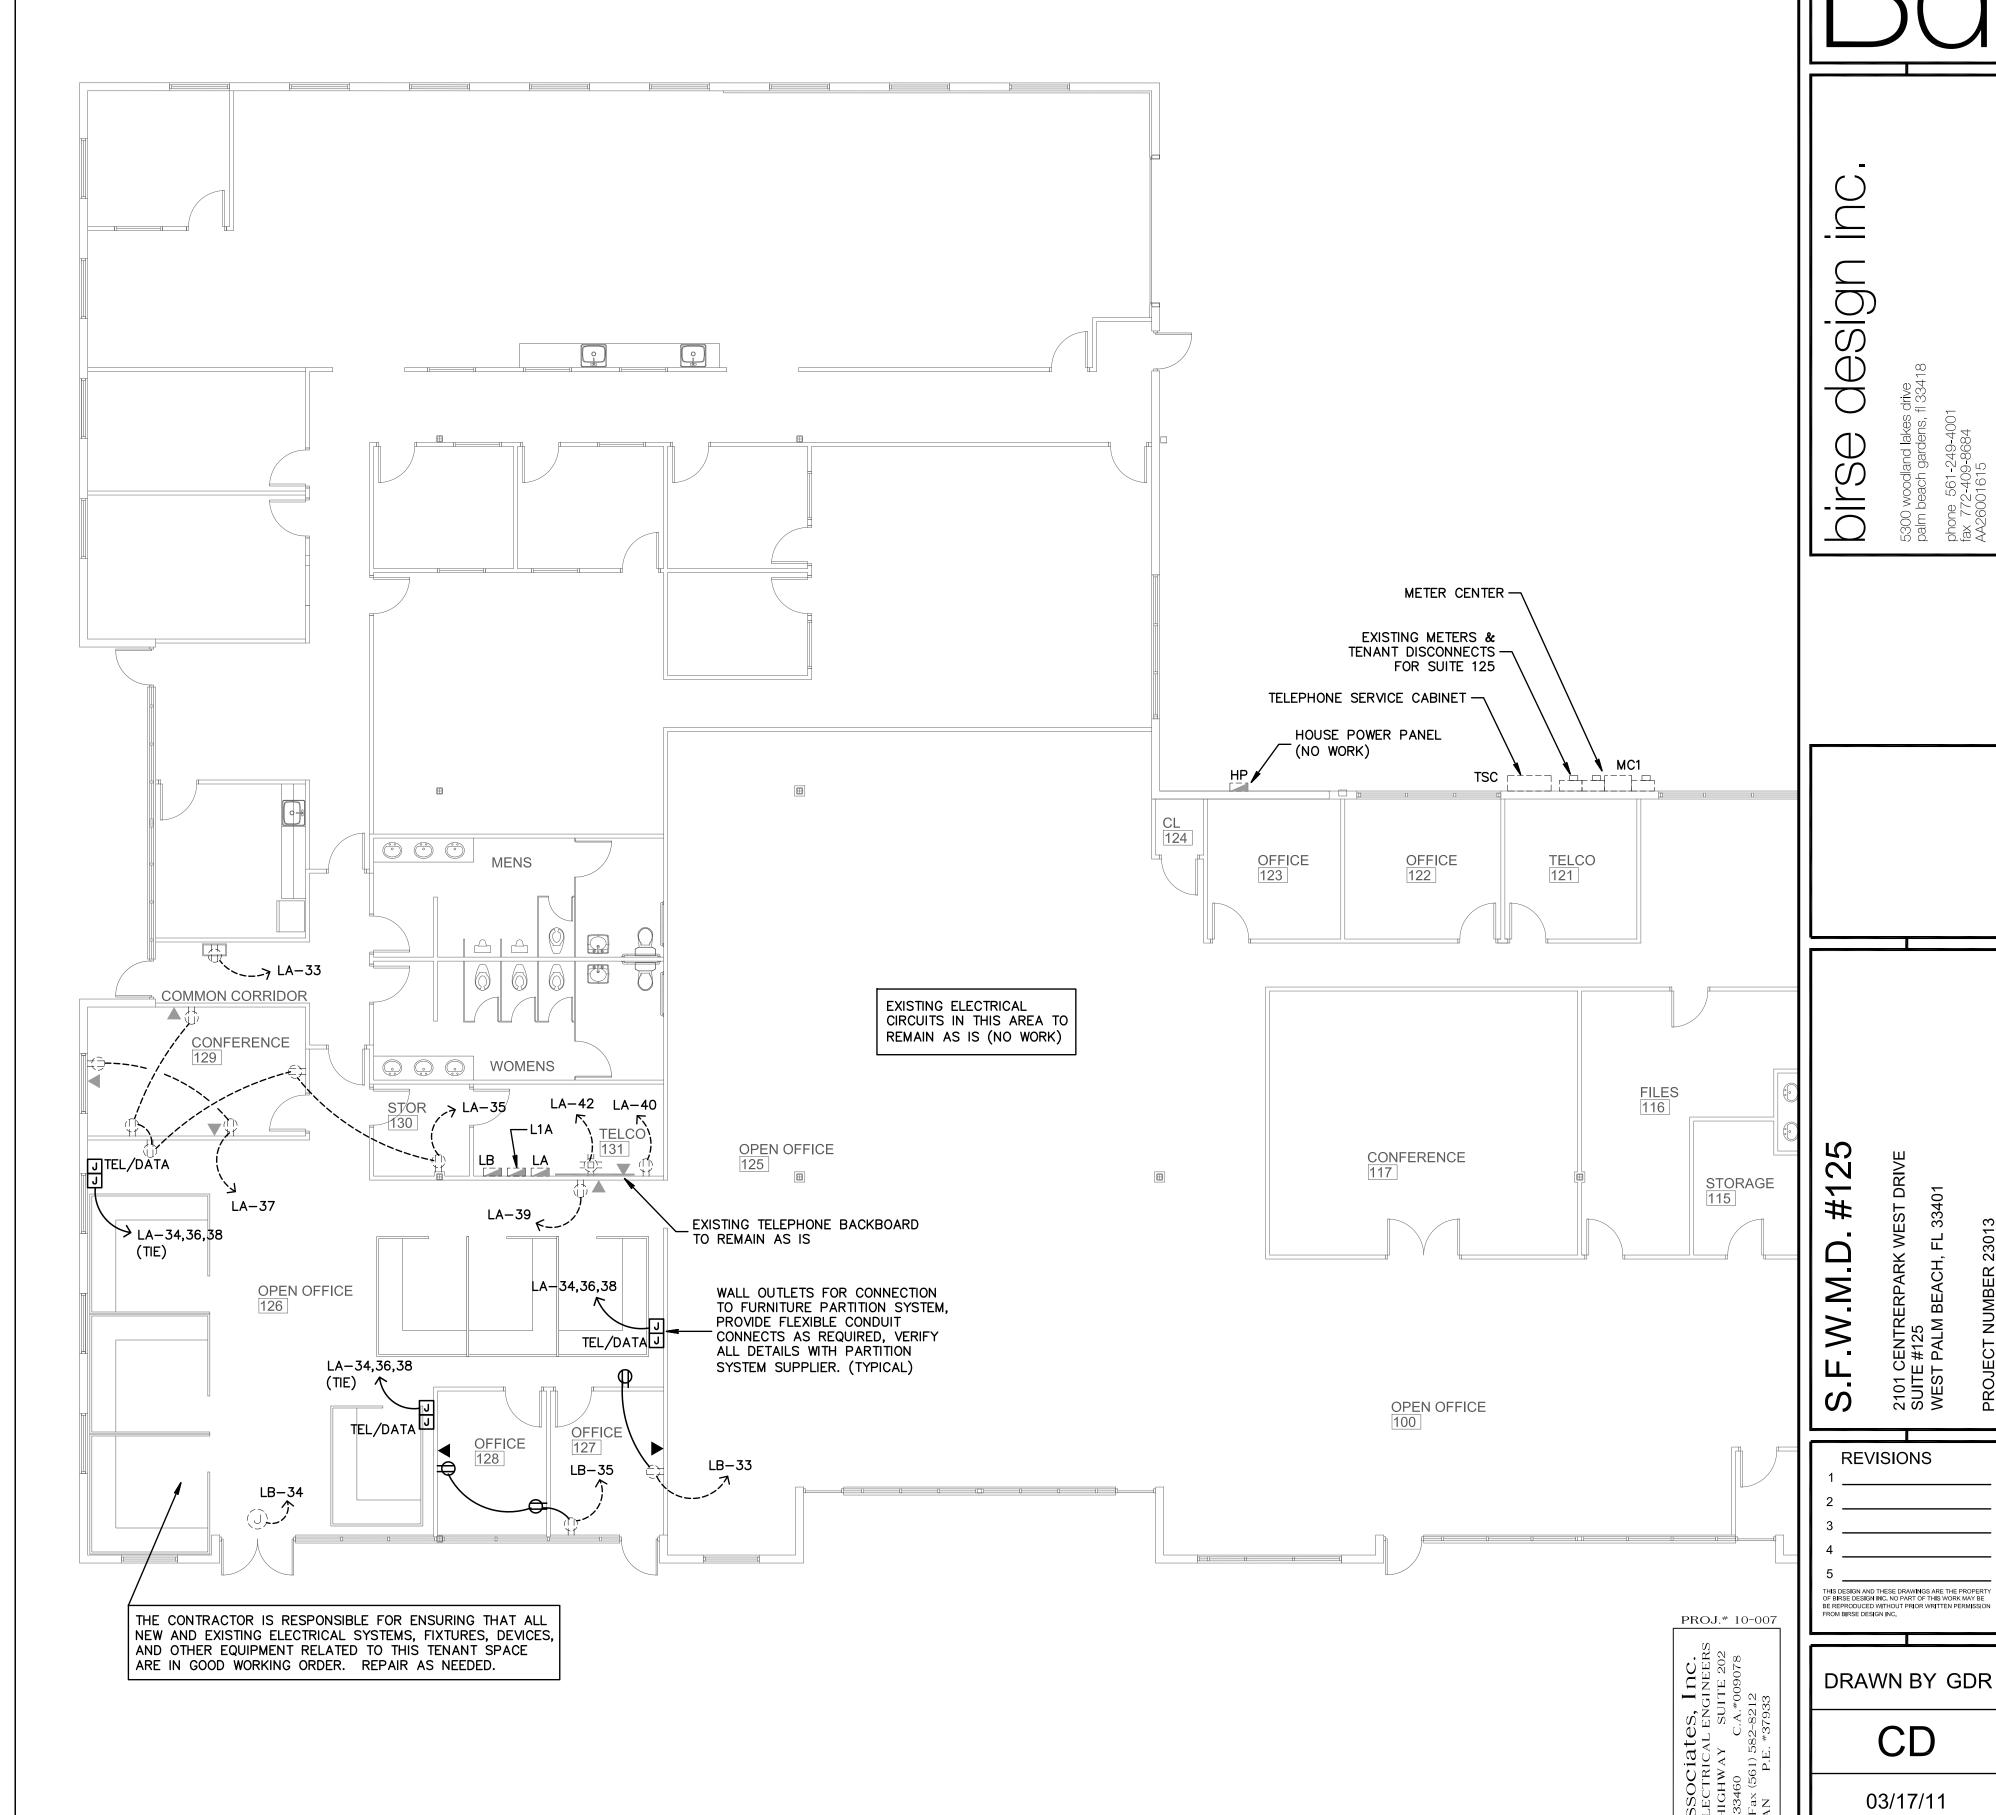EXISTING ELECTRICAL FLOOR PLAN


SCALE: 1/8" = 1'-0"

le: Z:\projects2009\Landfall\e-fp.dwg|Layout: E1 ser: Ron | Date: Wednesday, April 22 2009 04:49:4

E-1)

THESE DRAWINGS PROVIDE
AN EMPTY RACEWAY AND
OUTLET SYSTEM FOR FUTURE
USE BY THE TENANT. THERE
IS NO WIRING INCLUDED. ANY
SUCH WIRING IS TO BE PROVIDED
UNDER SEPARATE PERMIT.

ALL EMPTY RACEWAYS ARE TO BE CLEANED, AND A PULL STRING INSTALLED. PROVIDE A TEMPORARY CAP FOR ALL CONDUITS WHICH ORIGINATE FROM EXTERIOR OF THE BUILDING.

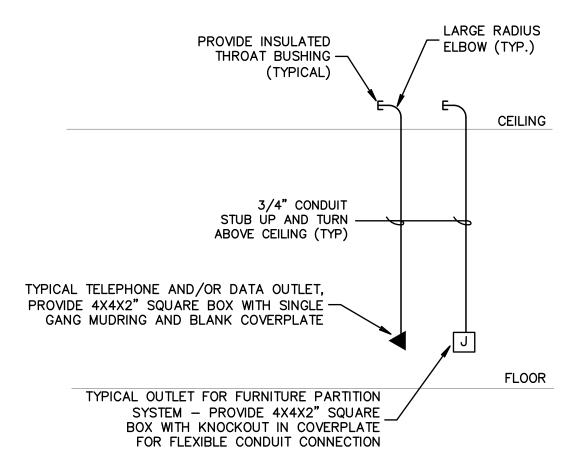

TELEPHONE/DATA OUTLET DETAIL
NO SCALE

OCCUPANCY SENSOR LEGEND (HUBBELL)

O LHMTS1 WALL BOX


 ALL OCCUPANCY SENSORS ARE TO BE INSTALLED IN ACCORDANCE WITH THE MANUFACTURER'S WRITTEN INSTRUCTIONS. PROVIDE POWER PACKS, RELAYS, AND ANY OTHER ACCESSORIES AS REQUIRED FOR A COMPLETE AND OPERATION SYSTEM AS SHOWN, INCLUDING CONTROL OF MULTIPLE CIRCUITS AND 120 OR 277 VOLT SYSTEMS WHERE INDICATED.


OCCUPANCY SENSORS SHALL TURN OFF THE SPACE LIGHTING WITHIN 30 MINUTES OF AN OCCUPANT LEAVING THE SPACE, IN ACCORDANCE WITH FBC 13-415.AB.1.1

THE CONTRACTOR IS RESPONSIBLE TO SET ALL OCCUPANCY SENSORS TO THE MAXIMUM ALLOWABLE DURATION


LIGHTING POWER COMPLIANCE (PER TABLE 13-415.2.B, FBC CHAPTER 13)										
SPACE TYPE TOTAL AREA ALLOWANCE SUB-TOTAL DESIGN (SQ.FT.) PER SQ.FT. ALLOWANCE										
OFFICE	1,550	1.1	1,705	1,564						
CORRIDOR	40	0.5	20	92						
TOTALS			1,725	1,656						

(ABOVE REFLECTS MODIFIED AREAS ONLY)

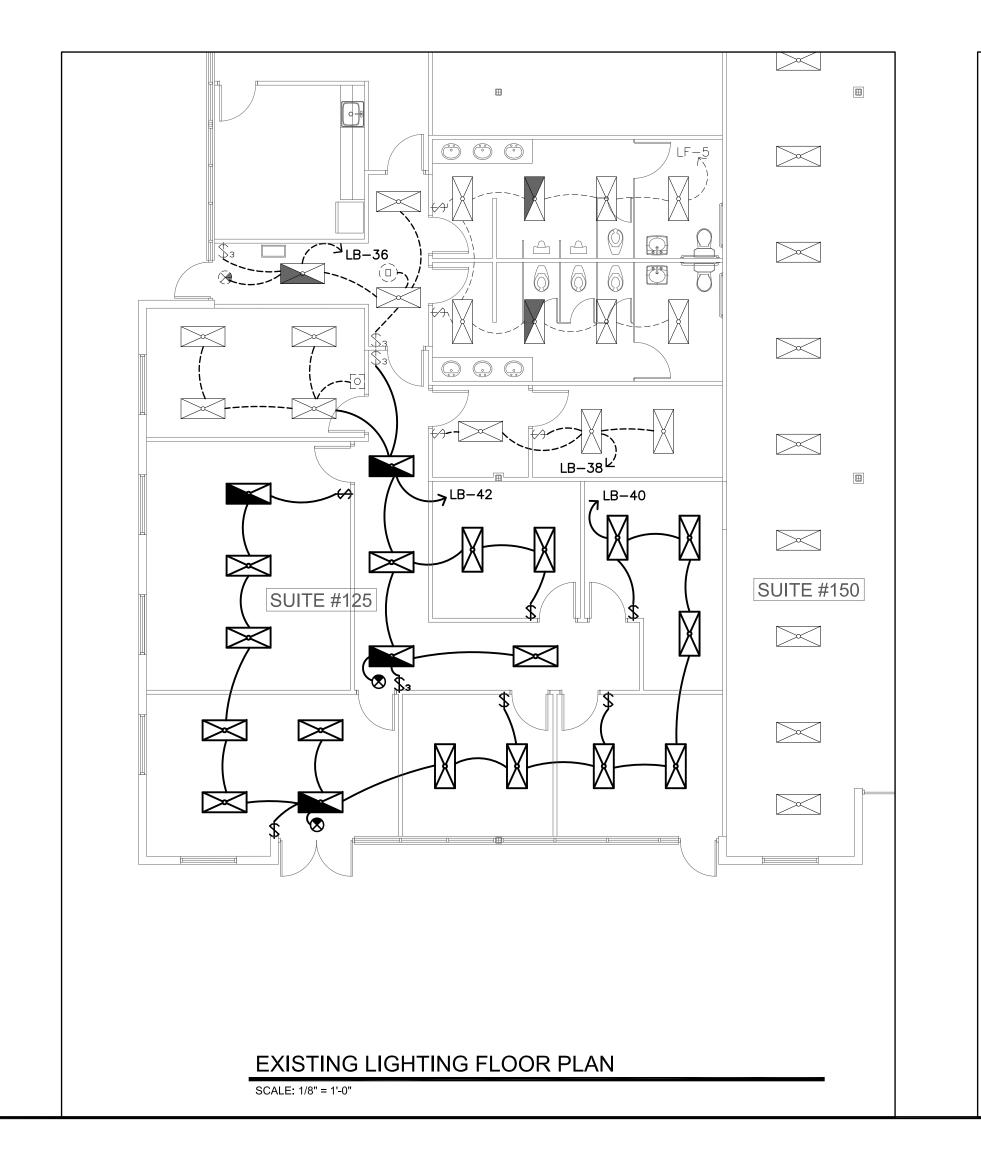

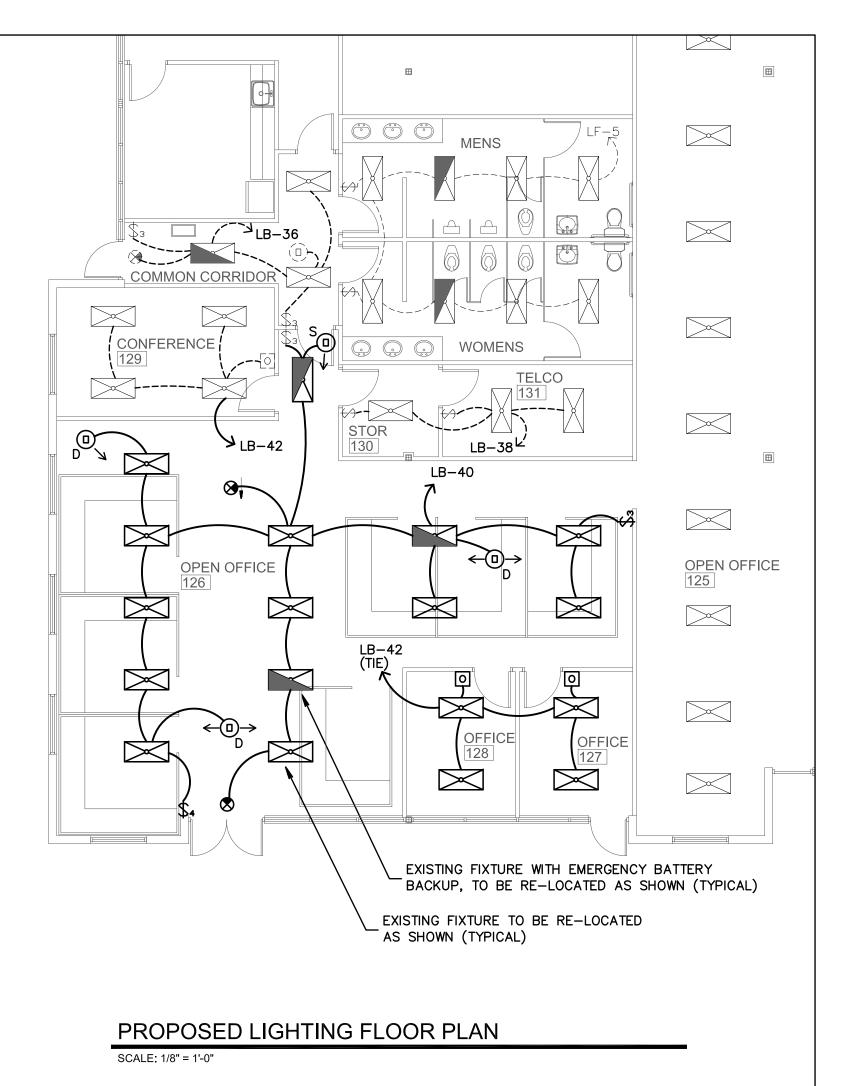



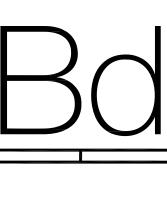

REVISIONS

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DRAWN BY GDR

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03/17/11

#125

EXISTING PANEL

	1	42 		I		 	1	1			4.I.C.		0K	
DEM. K∨A	DTHER KVA	TRIP POLE		WIRE	REMARKS	CKT.	CKT.		REMARKS	WIRE	CON- DUIT		□THER K∨A	DEM. K∨A
		20-1			SPARE	1		SPA	NRE			20-1		
		20-1				3	4					20-1		
		20-1				5	6					20-1		
		20-1				7	8					20-1		
		20-1				9	10					20-1		
		20-1				11	12					20-1		
		20-1				13	14					20-1		
		20-1				15	16					20-1		
		20-1				17	18					20-1		
		20-1				19	20					20-1		
		20-1				21	22					20-1		
		20-1				23	24					20-1		
		20-1				25	26					20-1		
		20-2				 27	28					20-1		
					\	L ₂₉	30					20-1		
	0.5	20-1			ROOF RECEPTACLES	31	32	1				20-1		
	0.5	20-1			DRINKING FOUNTAIN	33	34	PAR	RTITION RECEPTACLES	12	1/2	20-1	0.9	
	0.7	20-1	1/2	12	RECEPTACLES 126,129,130	35	36	PAR	TITION RECEPTACLES	12	1/2	20-1	0.9	
	0.4	20-1	1/2	12	RECEPTACLES RM. 129	37	38	PAR	RTITION RECEPTACLES	12	1/2	20-1	0.9	
	0.2	20-1	1/2	12	RECEPTACLE ROOM 126	39	40	REC	EPTACLE			20-1	0.2	
		20-1			SPARE	41	42	TEL	EPHONE BOARD RECEPT.			20-1	0.4	
	2.3		•		•		•	•		•	•		3.3	

ELECTRICAL NOTES

- 1. DO NOT SCALE THE ELECTRICAL DRAWINGS. REFER TO ARCHITECTURAL PLANS AND ELEVATIONS FOR EXACT LOCATION OF ALL EQUIPMENT. CONFIRM WITH OWNERS REPRESENTATIVE.
- 2. ALL WORK SHALL BE DONE IN ACCORDANCE WITH NATIONAL ELECTRICAL CODE NFPA-70 (2008), THE LIFE SAFETY CODE NFPA-101 (2006), THE NATIONAL FIRE ALARM CODE NFPA-72 (2002), AND THE FLORIDA BUILDING CODE (FBC 2007 WITH 2009 SUPPLEMENTS).
- 3. MINIMUM WIRE SIZE SHALL BE #12 A.W.G., EXCLUDING CONTROL WIRING. UNLESS OTHERWISE NOTED ALL CONDUCTORS SHALL BE COPPER WITH THWN INSULATION.
- 4. DUTLET BOXES SHALL BE SHEET STEEL IN DRY LOCATIONS, CAST ALLOY WITH THREADED HUBS IN WET OR DAMP LOCATIONS AND SPECIAL ENCLOSURES AS REQUIRED FOR OTHER CLASSIFIED AREAS.
- 5. DISCONNECT SWITCHES SHALL BE H.P. RATED , HEAVY DUTY, QUICK-MAKE, QUICK-BREAK ENCLOSURES AS REQUIRED BY EXPOSURE.
- 6. MOTOR STARTERS SHALL BE MANUAL OR MAGNETIC , WITH OVERLOAD RELAYS IN EACH HOT LEG.
- 7. IT IS NOT THE INTENT OF THESE PLANS TO SHOW EVERY MINOR DETAIL OF CONSTRUCTION. THE CONTRACTOR IS EXPECTED TO FURNISH AND INSTALL ALL ITEMS FOR A COMPLETE ELECTRICAL SYSTEM AND PROVIDE ALL REQUIREMENTS NECCESSARY FOR EQUIPMENT TO BE PLACED IN PROPER WORKING
- 8. ELECTRICAL SYSTEM SHALL BE COMPLETE AND EFFECTIVELY GROUNDED AS REQUIRED BY THE LATEST EDITION OF THE N.E.C.
- 9. ALL MATERIALS SHALL BE NEW AND BEAR UNDERWRITERS' LABELS WHERE APPLICABLE.
- 10. ALL WORK SHALL BE PERFORMED BY A LICENSED ELECTRICAL CONTRACTOR IN A FIRST CLASS WORKMANLIKE MANNER. THE COMPLETED SYSTEM SHALL BE FULLY OPERATIVE, AND ACCEPTED BY ENGINEER/ARCHITECT.
- 11. ALL WORK SHALL BE COORDINATED WITH OTHER TRADES TO AVOID INTERFERENCE WITH THE PROGESS OF CONSTRUCTION.
- 12. CONTRACTOR SHALL GUARANTEE ALL MATERIALS AND WORKMANSHIP FREE FROM DEFECTS FOR A PERIOD OF NOT LESS THAN ONE YEAR FROM DATE
- 13. CORRECTION OF ANY DEFECTS SHALL BE COMPLETED WITHOUT ADDITIONAL CHARGE AND SHALL INCLUDE REPLACEMENT OR REPAIR OF ANY OTHER PHASE OF THE INSTALLATION WHICH MAY HAVE BEEN DAMAGED THEREBY.
- 14. ALL REQUIRED INSURANCE SHALL BE PROVIDED FOR PROTECTION AGAINST PUBLIC LIABILTY AND PROPERTY DAMAGE FOR THE DURATION OF THE WORK.
- 15. CONTRACTOR SHALL PAY FOR ALL PERMITS , FEES , INSPECTIONS , AND TESTING
- 16. THE ELECTRICAL INSTALLATION SHALL MEET ALL STANDARD REQUIREMENTS OF POWER AND TELEPHONE COMPANIES.
- 17. FURNISH AND INSTALL DISCONNECT SWITCHES AND WIRING FOR AIR CONDITIONING SYSTEM AS PER MANUFACTURERS RECOMMENDATIONS. CONTROLS ARE TO BE SUPPLIED BY AIR CONDITIONING CONTRACTOR AND CONNECTED BY ELECTRICAL CONTRACTOR.
- 18. ALL RACEWAYS UNDERGROUND SHALL BE A MINIMUM OF 3/4"CONDUIT.

 19. ALL CIRCUIT BREAKERS , TWO AND THREE POLE , TO BE COMMON TRIP. NO
- TIE HANDLES , OR TANDEMS WILL BE ACCEPTED.
- 20. ALL FUSES , UNLESS NOTED ON DRAWING , SHALL BE CURRENT LIMITING (C.L.) RATED FOR 200,000 A.I.C.
- 21. ALL ELECTRICAL EQUIPMENT, DEVICES, WIRE, ETC., SHALL BE LISTED, FOR THE INTENDED USE, WITH UNDERWRITER'S LABORATORIES, INC. (UL), WHERE STANDARDS HAVE BEEN ESTABLISHED BY UL.
- 22. THE CONTRACTOR IS RESPONSIBLE TO MAINTAIN, ON SITE, A DETAILED AS-BUILT PLAN SHOWING ACTUAL INSTALLATIONS. THE CONTRACTOR IS TO PROVIDE A NEATLY DRAWN COMPREHENSIVE AS-BUILT SET OF PLANS UPON COMPLETION, WHICH ARE SUITABLE FOR SUBMISSION TO THE BUILDING DEPARTMENT AND THE OWNER.
- 23. ALL WIRING IS TO BE IN CONDUIT. METAL CLAD CABLES MAY BE USED FOR 30 AMP AND SMALLER BRANCH CIRCUITS EXCEPT HOMERUNS.

ELECTRICAL LEGEND

LIGHTING FIXTURE IDENTIFICATION


RECTANGULAR LIGHTING FIXTURE - AS NOTED

RECTANGULAR LIGHTING FIXTURE - EXISTING AS NOTED

) ROUND LIGHTING FIXTURE

- DIRECTIONAL LIGHTING FIXTURE
- O WALL MOUNTED LIGHTING FIXTURE
- LINEAR STRIP LIGHTING FIXTURE
- EXIT LIGHT WITH EMERGENCY BATTERY BACKUP
- EXECUTIVE EXECUTIVE EXECUTIVE ATTEMPT PARTIES AND
- EMERGENCY LIGHTING FIXTURE WITH BATTERY BACKUP
- RECTANGULAR LIGHTING FIXTURE ON EMERGENCY POWER CIRCUIT.
- ROUND LIGHTING FIXTURE ON EMERGENCY POWER CIRCUIT
- DUPLEX RECEPT 20 AMP (18" A.F.F.)
- SINGLE RECEPT 20 AMP (18" A.F.F.)
- DUPLEX RECEPT MOUNTED ABOVE COUNTER 20 AMP (42" A.F.F.)
- O DUPLEX RECEPT FLUSH FLOOR MOUNTED 20 AMP
- SPECIAL PURPOSE RECEPT (18" A.F.F. MATCH EQUIPMENT PROVIDED)
- QUAD-PLEX RECEPT 20 AMP (18" A.F.F.)
- \$ SINGLE POLE TOGGLE SWITCH, 48" AFF
- $\$_3$ 3-WAY TOGGLE SWITCH, 48" AFF
- $\$_{ t D}$ SLIDE TYPE DIMMER SWITCH, WATTAGE AS REQUIRED, 48" AFF
- JUNCTION BOXES
- $3\frac{100}{100}$ Fusible disconnect (switch poles, amps/fuses as shown)
- \$m MOTOR RATED SWITCH (WITH OVERLOADS)
- ELECTRICAL PANELBOARD
- MOTOR LOAD
- CIRCUIT HOME RUN TO PANELBOARD OR OTHER DEVICE AS INDICATED
- CONDUIT CONCEALED
- EXISTING CIRCUIT AS NOTED
- E CAPPED CONDUIT
- TV TELEVISION OUTLET (18" A.F.F.)
- ▼ TELEPHONE/DATA OUTLET (18" A.F.F.)
 ▼ TEL/DATA OUTLET FLUSH FLOOR MOUNTED
- EXISTING DUPLEX RECEPTACLE DUTLET BOX TO REMAIN.
- ▼ EXISTING TELEPHONE/DATA OUTLET BOX TO REMAIN
- E EXISTING DEVICE TO REMAIN, UNLESS NOTED OTHERWISE
- R EXISTING DEVICE, RELOCATED AS SHOWN
- D EXISTING DEVICE TO BE DEMOLISHED OR RELOCATED


EXISTING PANEL

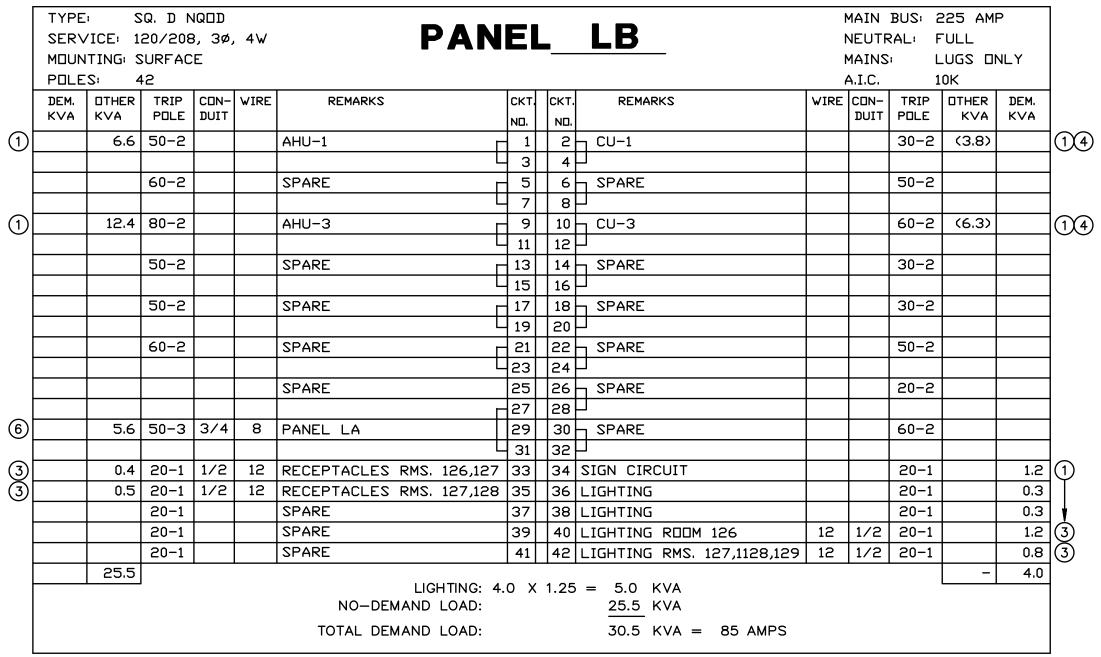

PANEL SCHEDULE KEYNOTES

- (1) EXISTING CIRCUIT TO REMAIN AS IS.
- EXISTING CIRCUIT TO BE REMOVED.
- ③ EXISTING CIRCUIT TO BE MODIFIED AS SHOWN ON FLOOR PLAN.
- (4) CONDENSING UNIT IS NON-COINCIDENT WITH AHU HEAT STRIP.
- (5) NEW CIRCUIT CONNECTED TO EXISTING SPARE CIRCUIT BREAKER. PROVIDE ISOLATED GROUND WIRE.

(6) ADD-ALTERNATE BID ONLY. PROVIDE NEW CIRCUIT BREAKER, MATCH EXISTING BREAKERS. SEE RISER DIAGRAM

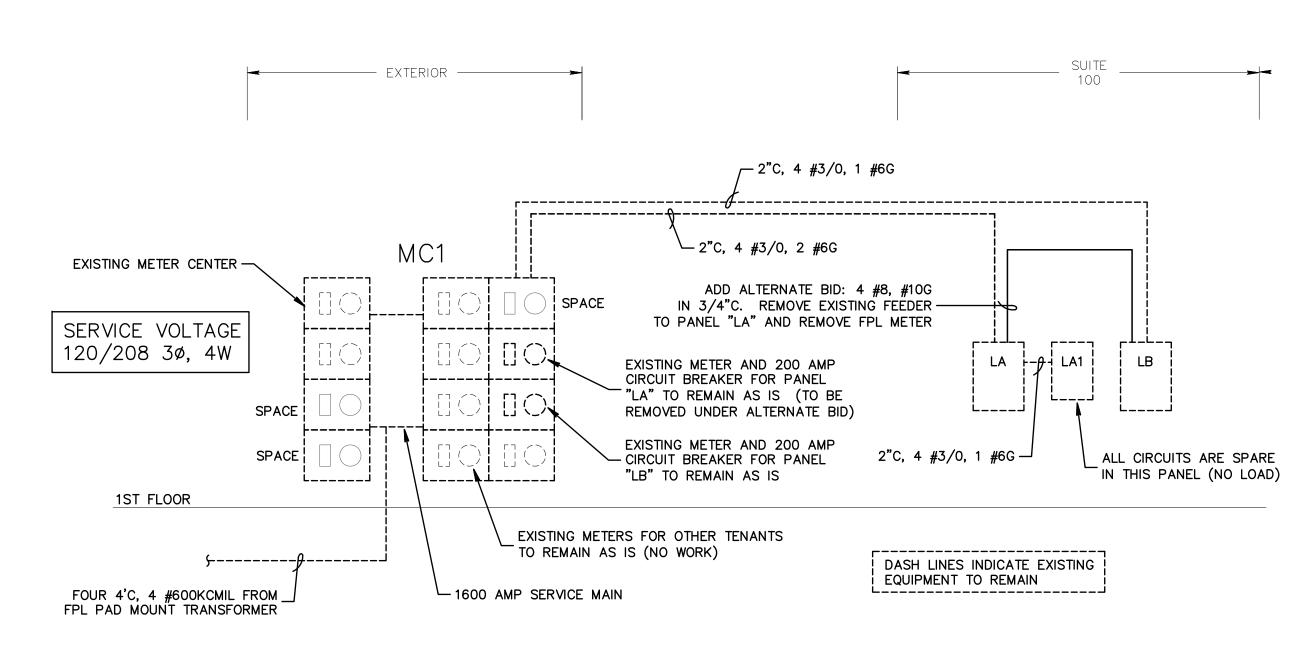

ELECTRICAL RISER DIAGRAM
SCALE: NONE

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CTRICAL ENGINEERS
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P.E. #37933

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ELECTRICAL DETAILS

CALE: NONE