birse design inc + architecture + interior design + planning

5300 woodland lakes drive palm beach gardens, fl 33418

phone 561-249-4001 fax 772-409-8684 AA26001615

MECHANICAL ENGINEER / ELECTRICAL / PLUMBING

SYMBOL INDEX:

- ROOM NAME ROOM NUMBER

- DOOR MARK/NUMBER

WINDOW MARK/NUMBER

- WALL SECTION/SHEET NUMBER

- BUILDING SECTION/SHEET NUMBER

- ELEVATION TARGET/SHEET NUMBER

DETAIL NUMBER/SHEET NUMBER


- 2'x4' FLUORESCENT LIGHT FIXTURE

CEILING HEIGHT

- FIRE EXTINGUISHER



129 N. FEDERAL HWY. SUITE 211 LAKE WORTH, FL 33460 (561) 582-0210 P.E. 37933

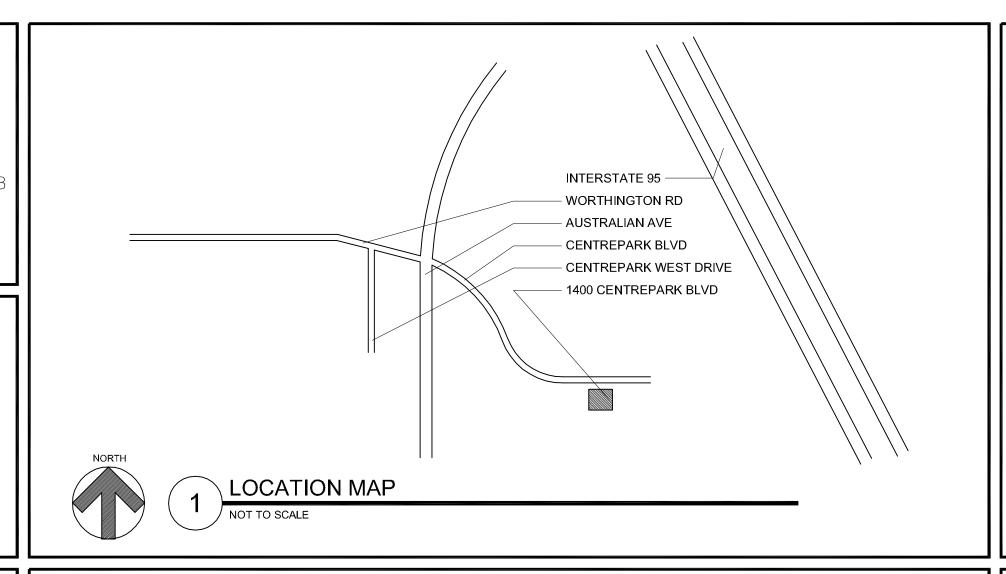

- AREA OF PERMIT

* AREA FOR THIS PERMIT IS HATCHED

* AREA FOR THIS PERMIT = 755 SF

INDEX OF SHEETS:

TITLE SHEET ARCHITECTURAL SHEETS

3RD FLOOR PLANS 4TH FLOOR PLANS DETAILS

MECHANICAL/ELECTRICAL/PLUMBING SHEETS

MECHANICAL PLANS

MECHANICAL NOTES

ELECTRICAL

REFERENCE STANDARDS:

THIS PROJECT IS DESIGNED IN ACCORDANCE WI THE FOLLOWING CODES:

. THE FLORIDA BUILDING CODE (FBC), 2007 EDITION WITH 2009 SUPPLEMENTS (BUILDING, MECHANICAL, PLUMBING, FUEL GAS,

2. NATIONAL ELECTRIC CODE (NEC), 2008 EDITION.

3. FLORIDA FIRE PREVENTION CODE, 2007 EDITION.

4. NATIONAL FIRE PROTECTION ASSOCIATION (NFPA) 101, LIFE SAFETY CODE, 2006 EDITION.

5. NATIONAL FIRE PROTECTION ASSOCIATION (NFPA) 1, UNIFORM FIRE CODE, 2006 EDITION.

GENERAL NOTES:

THE CONTRACTOR SHALL AS A PART OF THIS CONTRACT FURNISH ALL MATERIALS, LABOR, TOOLS, EQUIPMENT, TRANSPORTATION, AND INSURANCE NECESSARY TO PROPERLY EXECUTE AND COMPLETE THE WORK ACCORDING TO THE PLANS AND SPECIFICATIONS.

THE CONTRACTOR IN THE WORK OF ALL TRADES SHALL PROTECT ALL EXISTING BUILDING AND PROPERTY FROM DAMAGE CAUSED BY THE ACTIVITIES OF THE CONTRACTOR AND SUBCONTRACTORS. THE CONTRACTOR SHALL REPAIR AND RESTORE THE JOB SITE AND SURROUNDING AREAS TO IT'S ORIGINAL CONDITION. OWNER TO VERIFY SATISFACTION.

. THE CONTRACTOR SHALL VISIT THE JOB SITE TO VERIFY ALL EXISTING CONDITIONS PRIOR TO BID. CONTRACTOR TO NOTIFY ARCHITECT OF ANY DISCREPANCIES.INCONSISTENCIES OR OMISSIONS BEFORE PROCEEDING WITH ANY WORK.

f i . THE CONTRACTOR SHALL MAKE NO CHANGES TO THE CONSTRUCTION DRAWINGS WITHOUT $\,$ WRITTEN APPROVAL FROM THE ARCHITECT.

5. ALL CONSTRUCTION SHALL CONFORM WITH THE LATEST CODES AND ORDINANCES.

. THESE CONSTRUCTION DOCUMENTS ARE DIAGRAMATIC AND ARE TO CONVEY DESIGN INTENT. IT IS NOT THE INTENT OF THESE CONSTRUCTION DRAWINGS TO SHOW ALL DETAILS OF THE EXISTING CONDITIONS. THE CONTRACTOR SHALL VISIT THE SITE TI VERIFY DIMENSIONS PRIOR

7. EACH CONTRACTOR SHALL ESTABLISH AND VERIFY ALL OPENINGS AND INSERTS FOR MECHANICAL, ELECTRICAL, AND PLUMBING WITH THE APPROPRIATE TRADES.

8. ALL INDICATED UTILITY AND STUB-IN LOCATIONS ARE FOR REFERENCE ONLY. THE EXACT LOCATIONS SHALL BE VERIFIED ON THE JOB SITE.

9. THE CONTRACTOR SHALL BE RESPONSIBLE FOR COORDINATING WITH ENGINEERING AND THE ARCHITECTURAL DRAWINGS FOR THE ACTUAL PLACEMENT OF THE WORK RELATIVE TO FIELD CONDITIONS.

10. THE CONTRACTOR SHALL BE RESPONSIBLE FOR THE OBTAINING INSTALLATION REQUIREMENTS FOR ALL BUILT-IN APPLIANCES, FIXTURES, AND

EQUIPMENT. VERIFY EXACT ROUGH-IN DIMENSIONS AND NOTIFY ARCHITECT OF ANY DISCREPANCIES PRIOR TO ROUGH-IN FRAME.

11. THE COST OF ADDITIONAL DESIGN WORK DUE TO ERRORS OR OMMISIONS IN CONSTRUCTION SHALL BE BORNE BY THE RESPECTIVE

10. DETAILS ON THE STRUCTURAL DRAWINGS (IF PROVIDED) ARE TYPICAL. VERIFY ALL DIMENSIONS WITH THE STRUCTURAL DRAWINGS.

12. CONTRACTOR TO BE RESPONSIBLE FOR CHECKING STRUCTURAL CALCULATIONS FOR SPECIFIC REQUIREMENTS OF STRUCTURAL CONNECTIONS. SUBMIT STEEL TRUSS CALCULATIONS AND SHOP DRAWINGS OF ALL STRUCTURAL STEEL AND MISCELLANEOUS METAL

FABRICATION BEFORE COMMENCING FABRICATION. 13. BIRSE DESIGN, INC. SHALL IN NO WAY BE RESPONSIBLE FOR THE CONSTRUCTION MEANS, METHODS, TECHNOLOGIGES, SEQUENCES OR

PROCEDURES, OR FOR SAFETY PRECAUTIONS AND PROGRAMS IN CONNECTION WITH THE WORK. (THESE ARE SOLELY THE CONTRACTORS

RESPONSIBILITY UNDER THE CONTRACT FOR CONSTRUCTION.

14. EACH CONTRACTOR SHALL PROVIDE ALL NECESSARY TEMPORARY BRACING, SHORING, GUYING, OR OTHER MEANS TO AVOID EXCESSIVE STRESSES AND TO HOLD STRUCTURAL ELEMENTS ASSOCIATED WITH WORK IN PLACE DURING CONSTRUCTION.

15. PROVIDE PORTABLE FIRE EXTINGUISHERS DURING CONSTRUCTION AS REQUIRED BY LOCAL CODES.

16. SPRINKLER SYSTEM: INSTALL FULL BUILDING SPRINKLER SYSTEM IN COMPLIANCE WITH THE REQUIREMENTS OF NFPA 13. SHOP DRAWINGS MUST BE APPROVED BEFORE INSTALLATIONS. PROVIDE OWNER WITH 2 COPIES OF PERMIT SETS.

7. ALL CONTRACTORS AND SUBCONTRACTORS SHALL BE RESPONSIBLE FOR MEETING THE REQUIREMENTS OF ALL CURRENT APPLICABLE BUILDING CODES AND ENFORCEMENT AGENCIES, FIRE MARSHALL, OR ANY OTHER BUILDING CODE ENFORCEMENT OFFICER AT NO EXTRA COST TO THE OWNER. NOTIFY THE ARCHITECT IN WRITING OF ANY DISCREPHANCIES PRIOR TO SUBMITTING A BID FOR THE PROJECT.

18. BASE BID SHALL INCLUDE BUT NOT BE LIMITED TO THE FOLLOWING:

A. ALL PERMITS AND FEES FOR ALL

1. BUILDING AND TRADE PERMITS. 2. ALL ACCESSORY AND SITE IMPROIVEMENT PERMITS.

B. ALL FILL REQUIRED TO MEET MINIMUM FINISHED FLOOR SLAB ELEVATION AND COMPACTION.

C. WATER METER HOOK-UP AND METER DEPOSITS. - OWNER RESPONSIBILITY

D. HOOK-UP AND FEES FOR UNDERGROUND SERVICE FROM FPL

LOCAL PHONE & CABLE T.V. - OWNER RESPONSIBILITY E. SOIL, CONCRETE AND ANY OTHER NECESSARY TESTING.

F. ENGINEERING STAKE OUTS AND SURVEYS INCLUDING FINAL TIE - IN SURVEY.

G. CLEARING, GRUB, AND SITE PREPARATION, INCLUDING GRADING. H. ALL BIDDERS AND THEIR SUBCONTRACTORS SHALL BE CURRENTLY LICENSED

IN THE STATE OF FLORIDA.

OF PERMIT SET TO OWNER

I. THE OWNER RESERVES THE RIGHT TO REJECT ANY BIDS. J. THE G.C. SHALL PROVIDE AN ESTIMATE OF TIME FOR COMPLETION.

K. THE GENERAL CONTRACTOR SHALL PROVIDE PROOF OF INSURANCE FOR WORKMANS' COMPENSATION AND ANY OTHER INSURANCES REQUIRED BY THE OWNER FOR ALL EMPLOYEES EITHER DIRECTLY EMPLOYED BY THE

GENERAL CONTRACTOR OR BY HIS SUBCONTRACTORS. L. THE CONTRACTOR SHALL CLEARLY LIST ANY WORK NOT INCLUDED IN HIS BID.

M. PROVIDE FIRE DEPARTMENT KNOX BOX ADJACENT TO FRONT DOOR OF BLDG. N. CONTRACTOR TO PROVIDE AS BUILT DRAWINGS. PROVIDE TWO COPIES


ALLEN S BIRSE


REVISIONS

DRAWN BY ASB

M BIRSE DESIGNING.

06/22/11

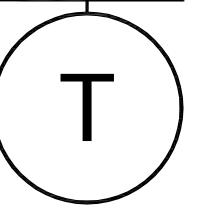

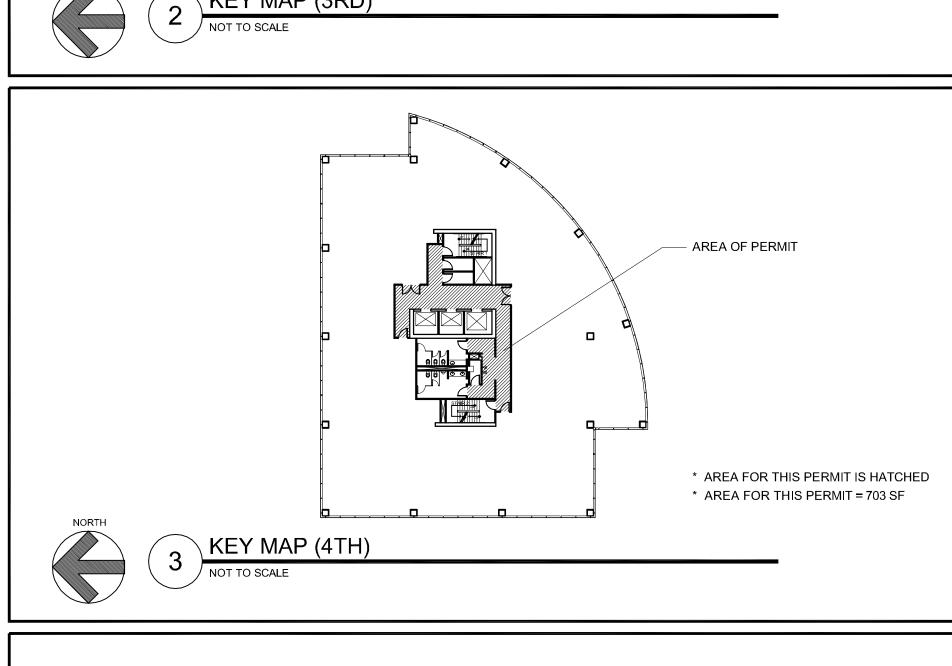

PROJECT DATA:

* PROJECT ADDRESS: 1400 CENTREPARK BLVD 3RD & 4TH FLOORS WEST PALM BEACH, FL 33410

* EXISTING BUILDING IS TYPE I "A"

* EXISTING BUILDING IS A 10 STORY BUILDING


* EXISTING BUILDING CLASSIFICATION IS GROUP "B" * LEVEL 2 ALTERATION PER "EXISTING BUILDING CODE 2007"


WALL MOUNTED LIGHT FIXTURE

RECESSED LIGHT DOWN FIXTURE


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DRAWN BY ASB

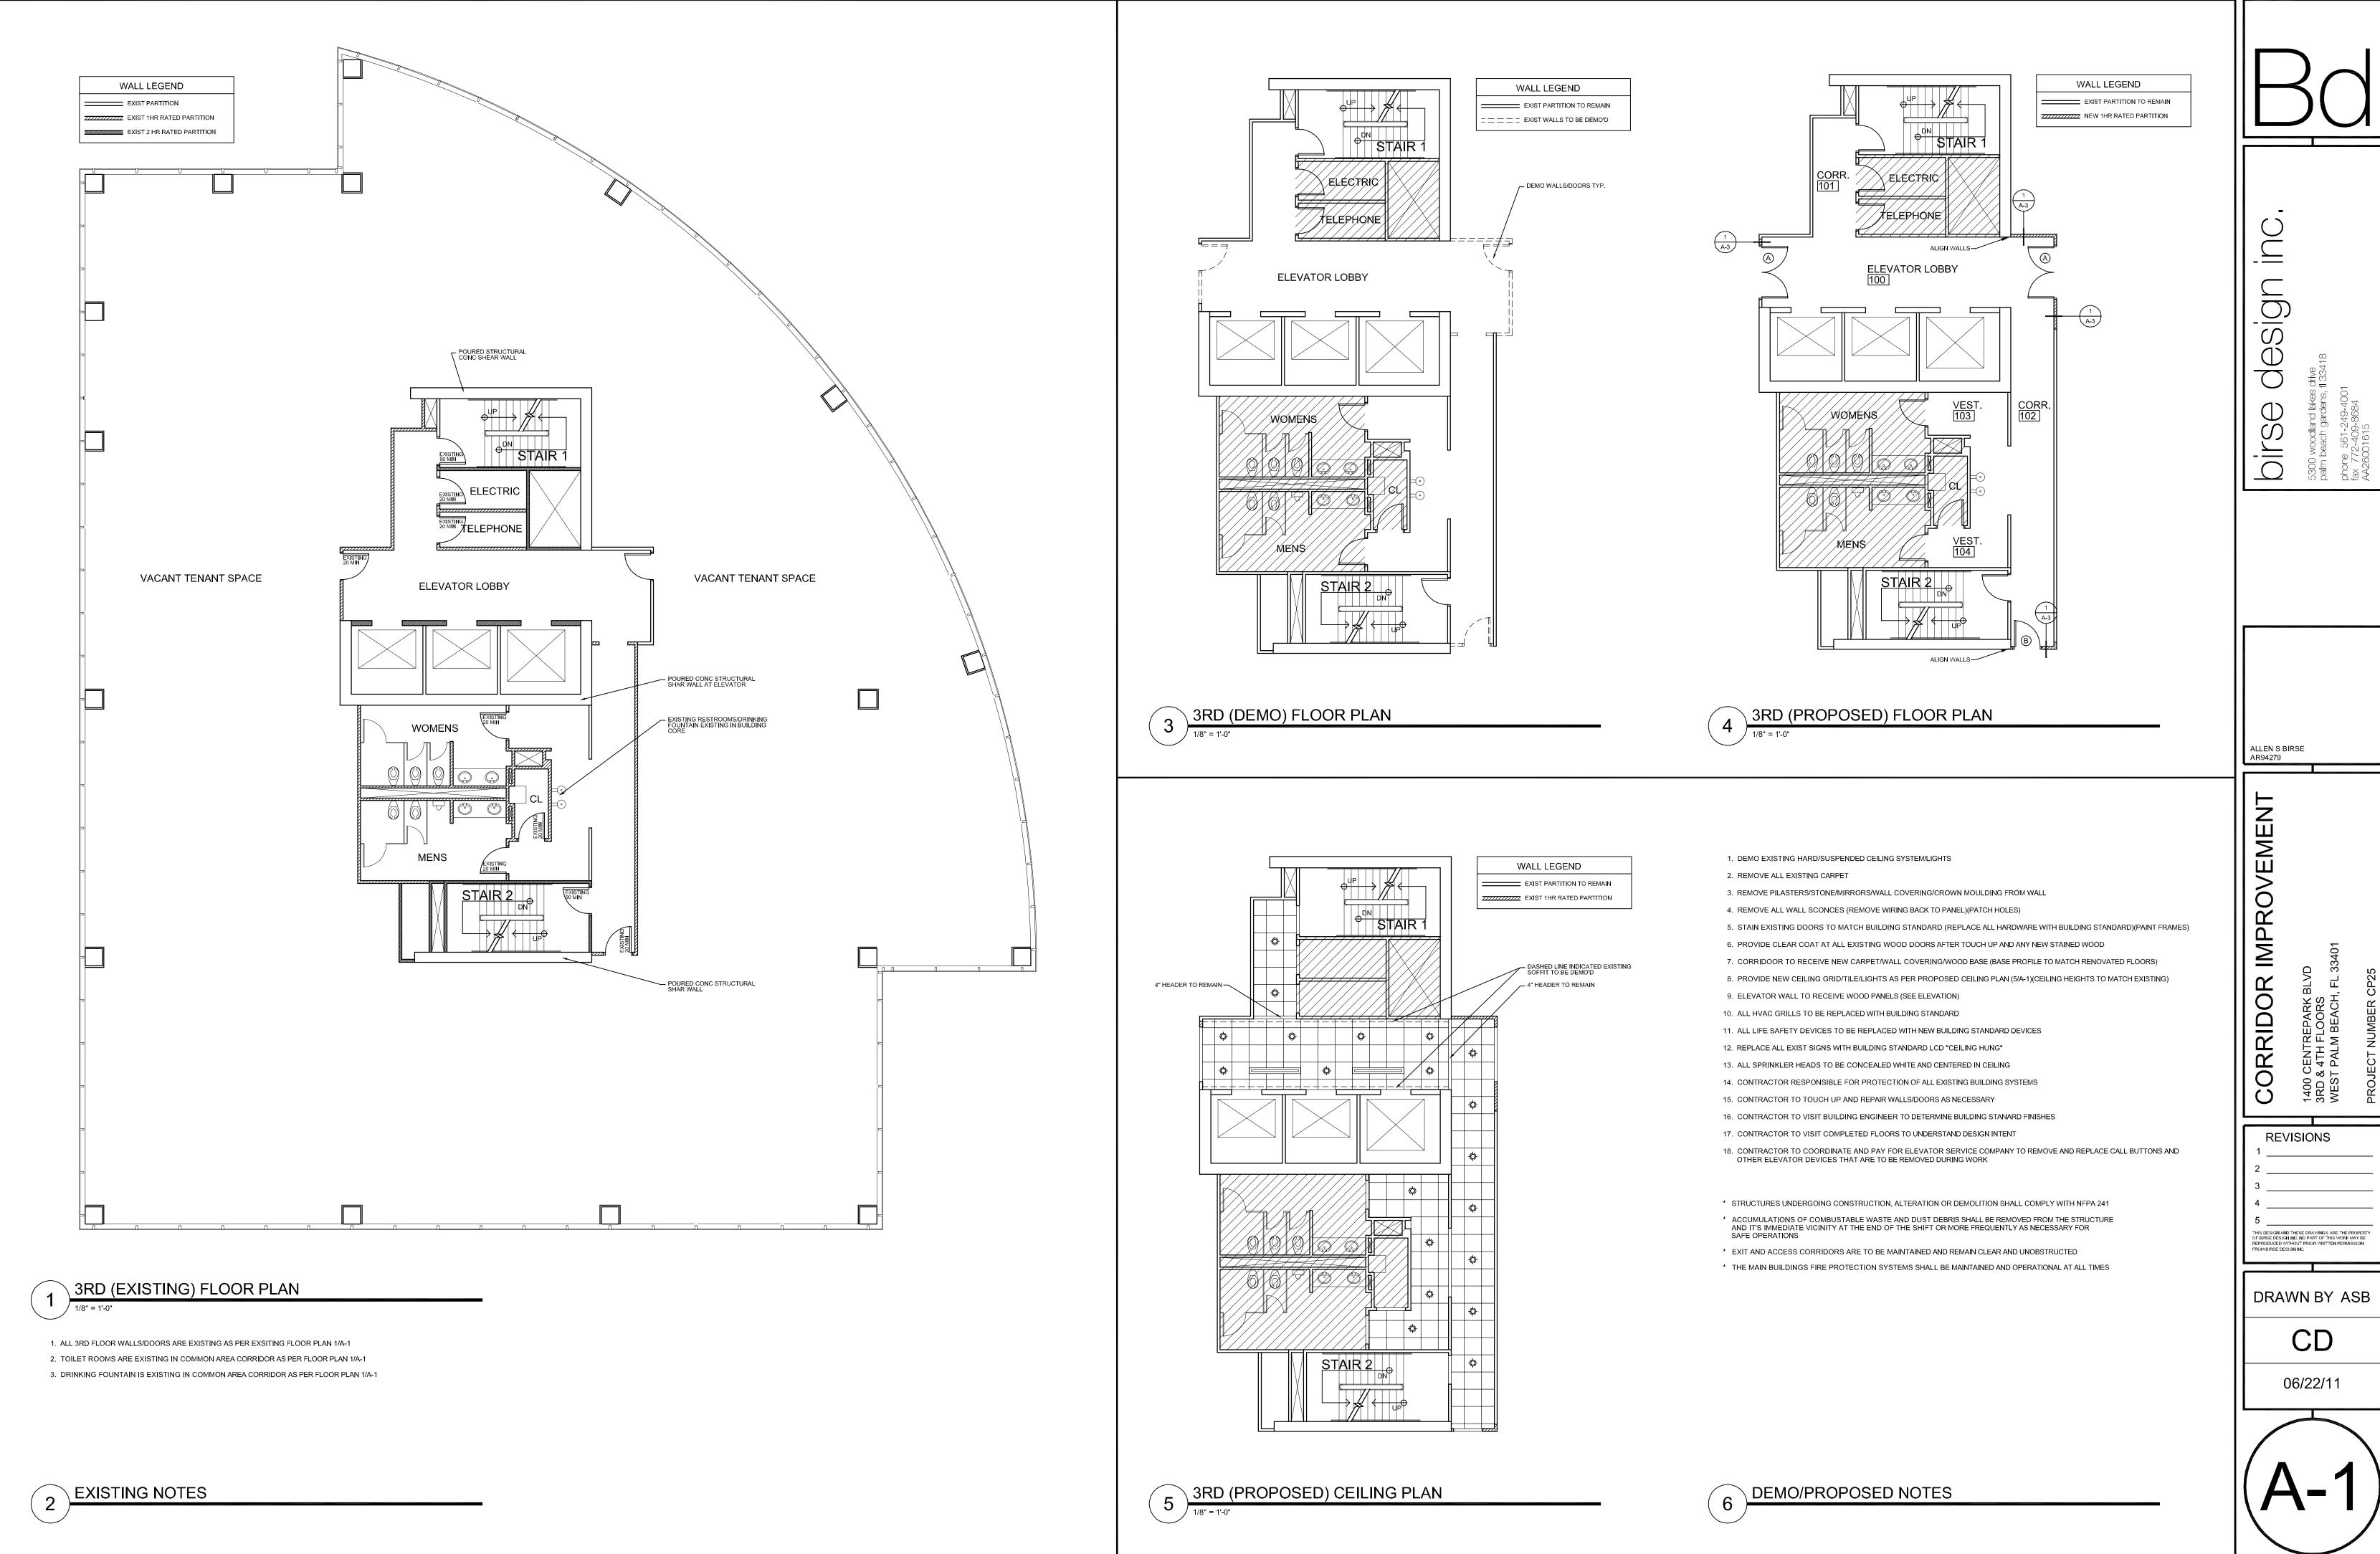

— BOTTOM OF FLOOR SLAB ACOUSTICAL CEILING
SEE REFL. CLG. PLAN — ACOUSTICAL CEILING SYSTEM SEE NOTES FOR BRAND — 5/8" TYPE 'X' GYP. BD. (M.R. @ WET AREAS) TAPED, SANDED, & PAINTED UL DESIGN U465 DESCRIPTION IS AS FOLLOWS: FLOOR & CEILING RUNNERS MIN. 3-5/8"W. 25 GA. FLOOR & CEILING RUNNERS MIN. 3-5/8"W. 25 GA.
STEEL STUDS (MIN 3-5/8"W. 25 GA.)
BATTS & BLANKETS (OPTIONAL)
5/8" WALLBOARD BOTH SIDES ATTACHED TO RUNNERS
& STUDS WITH 1" SELF TAPPING SCREWS @ 8" O.C.
AT BOARD EDGES & 12" O.C. IN THE FIELD.
STAGGER JOINTS OF THE BOARD ON OPPOSITE
SIDES OF THE ASSEMBLY SIDES OF THE ASSEMBLY. JOINT TAPE & COMPOUND (TWO COATS MIN.) ACCEPTABLE BOARD TYPES ARE: ACCEPTABLE BOARD TYPES ARE:
BORAL GYPSUM - TYPE BG-C.
CANADIAN GYPSUM CO. - TYPES C, SCX, SHX, WRX
DOMTAR GYPSUM INC. - TYPE 5 OR C
EAGLE-GYPSUM PRODUCTS - TYPE EG-C
GEORGIA PACIFIC CORP. - TYPE GPFS-6 OR GPFS-C
NATIONAL GYPSUM CO. - TYPE FSK-G, FSW-G
PABCO GYPSUM CO. - TYPE PG-C
REPUBLIC GYPSUM CO. - TYPE RG-C
STANDARD GYPSUM CORP. - TYPE SG-C STANDARD GYPSUM CORP. - TYPE SG-C TEMPLE-INLAND FOREST PRODUCTS CORP. - TYPE TP-5 UNITED STATES GYPSUM CO. - TYPE AR, C, IP-X2, SCX, SHX, WRC, OR WRX WESTROC INDUSTRIES LTD. - TYPE WESTROC FIREBOARD — 3-5/8" 20 GAUGE MTL. STUDS @ 24" O.C. - MINERAL FIBER BATT INSULATION – 5/8" TYPE 'X' GYP. BD. TAPED, SANDED, & PAINTED CAULKING AT ALL PENETRATIONS CONDUIT, JUNCTION BOXES, ETC) — CONTINUOUS FLOOR TRACK FLOOR FINISH-SEE SCHEDULE CONCRETE FLOOR SLAB (EX.)

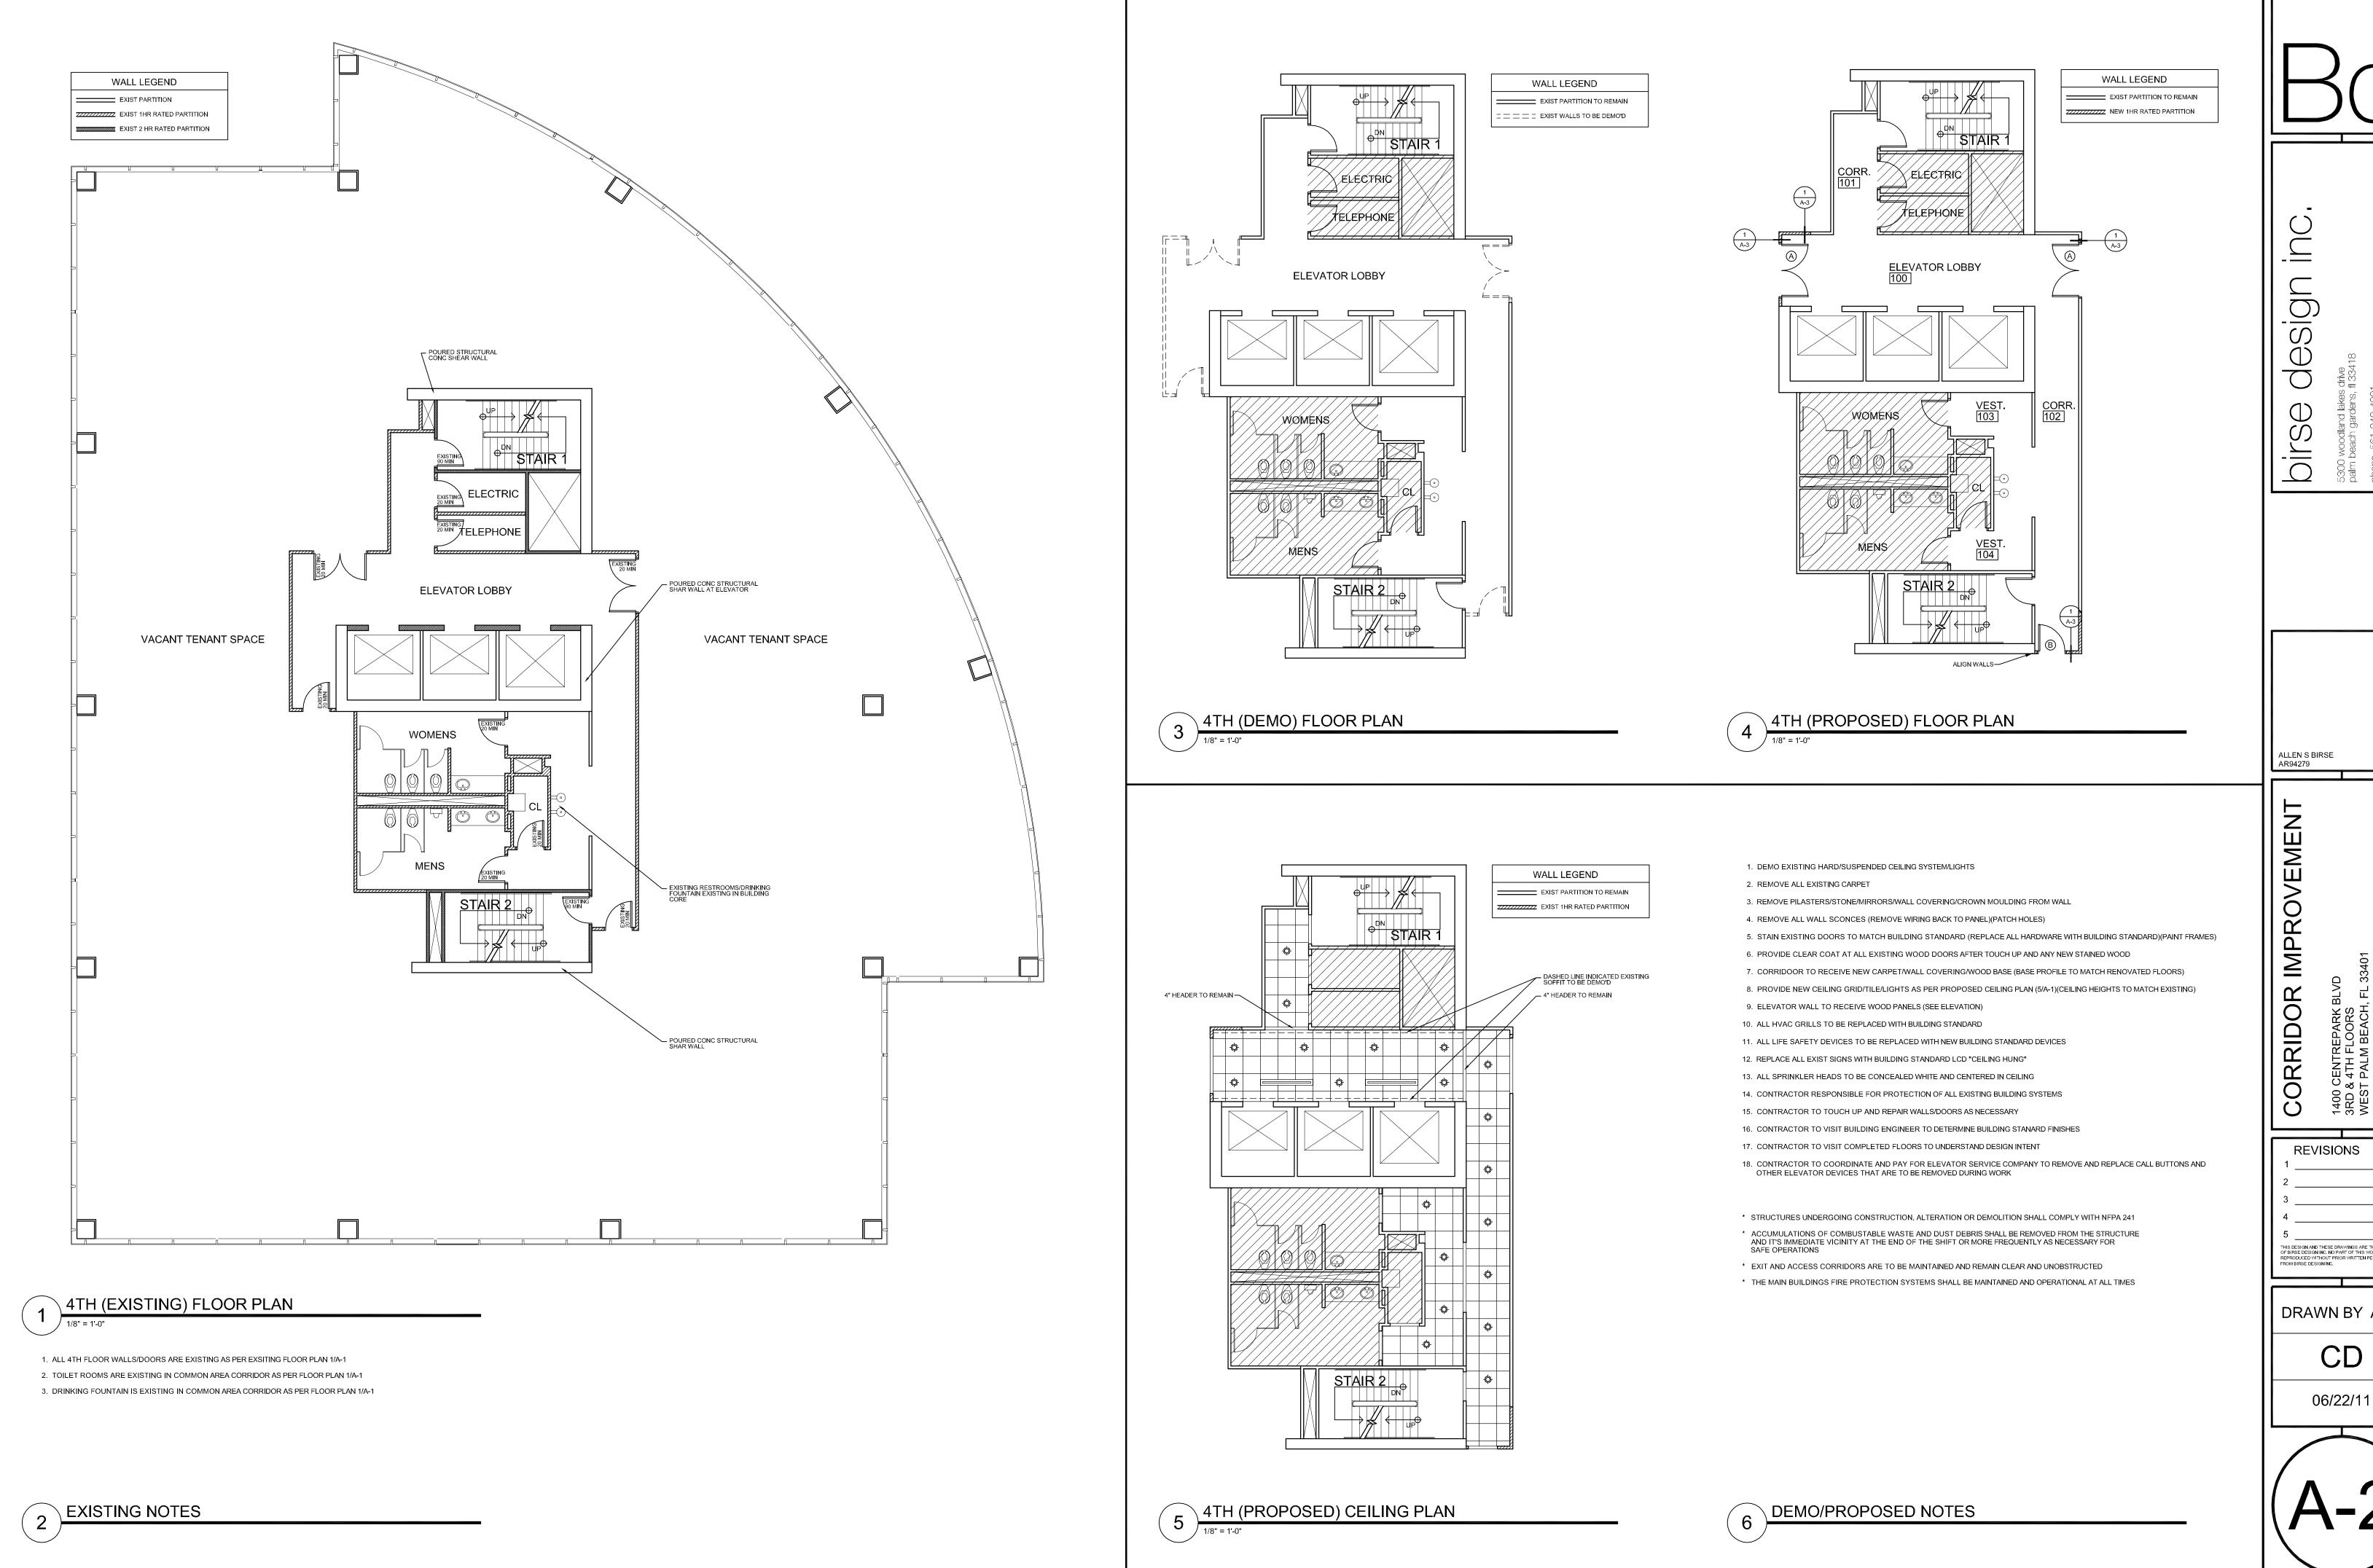CORE WALL

INSULATION BOARD (EXISTING)

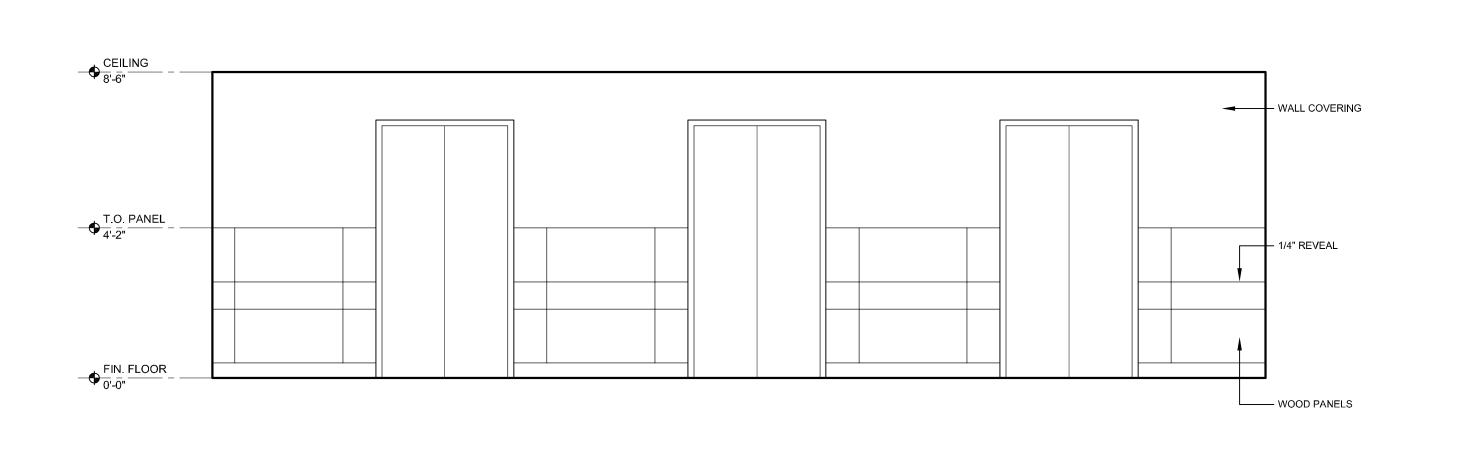1-5/8" 25 GAUGE MTL. STUDS (EXISTING)

WALL COVERING

VENEER CAP FLUSH W/PANEL

1/2" PLYWOOD

1/4" TYP, FILLER
BLOCKING AS REQUIRED

VENEER PANEL (TYP.)


CARPET TYP.

UL DESIGN U465 (1HR)

2 WALL TYPE

3 WOOD PANEL DETAIL

1" = 1'-0"

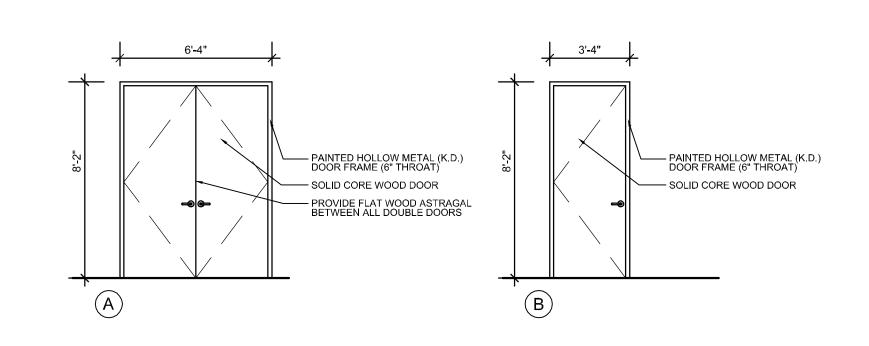


* ALL NEW EXTERIOR TENANT DOORS TO HAVE 5" SOLID TO RAIL (NO THROUGH BOLTING)

DOOR SCHEDULE

	LADEL			DOOR			FRAME	DELLABIO
MARK	LABEL	MAT	TYPE	SIZE			SIZE/MAT.	REMARKS
				W	Н	Т		
А	20 MINUTE RATED	WD	FLUSH	3'0"	8'0"	1-3/4"	2" HM	TENANT ENTRY DOOR
B 20 MINUTE RATED		WD	FLUSH	3'0"	8'0"	1-3/4"	2" HM	TENANT ENTRY DOOR

4 DOORS

1/4" = 1'-0"

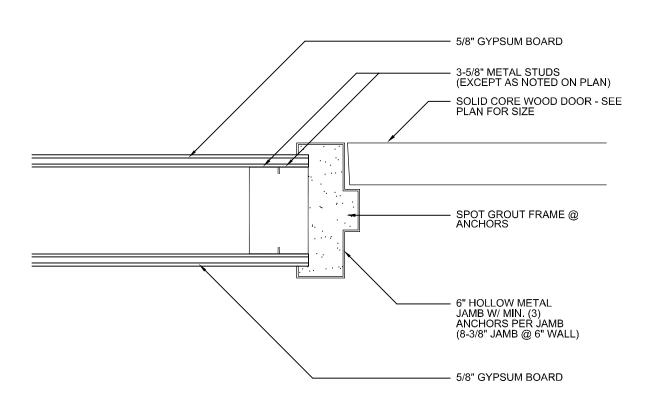

JAMB DETAIL

FINISH SELECTIONS

WALLCOVERING

CARPET

MANUFACTURER: KRAUS

STYLE: 1830 FRONTIER

COLOR: 94 CANYON GORGE

(9/16" EXPOSED TEE SYSTEM, WHITE)
PAINT
MANUFACTURER: SHERWIN WILLIAMS

COLOR: SOFTER TAN #SW6141

COLOR: DUNE #1852 (BEVELED TEGULAR WHITE)

ACOUSTIC CEILING TILE

WOOD VENEER

MANUFACTURER: EDGEMATE
COLOR: RED OAK #458

MANUFACTURER: SEABROOK

STYLE: EPOCH SHIMMER


COLOR: PATINA #2SH11

COLOR: RED OAK #458 (CELAR COAT SEALER, NO STAIN) (GRAIN TO RUN VERTICALLY)

- * PROVIDE TRANSITION STRIPS AT DIFFERING FLOOR TYPES
- * ALL INTERIOR FINISHES TO HAVE A MIN CLASS "B" FLAME SPREAD CLASSIFICATION
- * WOOD VENEER PANELS TO HAVE CLASSS "B' : FLAME SPREAD INDEX 26-75 SMOKE DEVELOPED SPREAD INDEX 0-450
- * ALL INTERIOR FLOOR FINISH SHALL BE NOT LESS THAN CLASS I
- * SAMPLES ARE REQUIRED TO BE APPROVED PRIOR TO ORDERING/OWNER TO APPROVE FINISH SCHEDULE PRIOR TO ORDERING



FINISH

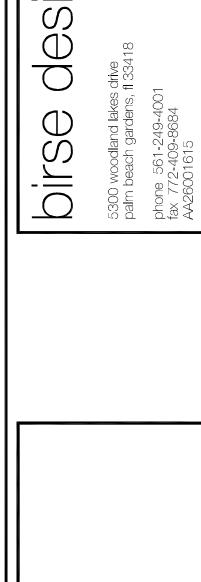

ALLEN S BIRSE AR94279

__

CORRIDOR IMPROVEMEN

1400 CENTREPARK BLVD
3RD & 4TH FLOORS
WEST PALM BEACH, FL 33401

REVISIONS

1
2
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4
5
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DRAWN BY ASB

CD



HVAC PROJECT SPECIFIC NOTES

CONTRACTOR IS TO INSPECT ALL EXISTING DUCTWORK SHOWN ON THESE PLANS AS REMAINING. REPAIR AS REQUIRED ANY DAMAGED DUCTWORK OR INSULATION. WHERE DUCTWORK IS SHOWN TO BE PARTIALLY REMOVED, CAP, SEAL, AND INSULATE TO MATCH EXISTING METHODS AND MATERIALS.

EXISTING EQUIPMENT WHICH IS REMAINING IS TO BE INSPECTED, ADJUSTED AND REPAIRED WHERE NECESSARY.

ABBREVIATIONS

CFM - CUBIC FEET PER MINUTE.

O/A - OUTSIDE AIR.

S/A - SUPPLY AIR.

R/A - RETURN AIR.

MVD - MANUAL VOLUME DAMPER

CWS - CONDENSER WATER SUPPLY CWR - CONDENSER WATER RETURN

EX - EXISTING

LEGEND

- SUPPLY AIR DIFFUSER
- RETURN, EXHAUST OR TRANSFER AIR
- → MANUAL VOLUME DAMPER
- THERMOSTAT
- FLEXIBLE DUCT, U.L. CLASS 1
- --- DUCTWORK NOT SHOWN TO SCALE
- EXISTING DUCT TO REMAIN
- **DUCT TRANSITION**
- DUCT TAKE-OFF WITH


VOLUME DAMPER

- DIFFUSER OR REGISTER TYPE/CFM
- ▲ FIRE DAMPER, STYLE B
- DUCT SMOKE DETECTOR WITH AUDIBLE & VISUAL ALARMS
- CONNECTION TO EXISTING


DRAWING KEYNOTES:

- 1 EXISTING HEAT PUMP A/C UNIT TO REMAIN. PROVIDE ANY REQUIRED MAINTENANCE, THOROUGHLY CLEAN THE UNIT INSIDE AND OUT, INCLUDING THE COILS AND ALL OTHER COMPONENTS, USING A VACUUM AND APPROPRIATE NON-CORROSIVE MATERIALS. STRAIGHTEN ANY BENT COIL FINS AND REPLACE ANY MISSING HARDWARE. PROVIDE NEW FILTER AND VERIFY PROPER OPERATION.
- (2) EXISTING SUPPLY AIR DUCT ABOVE CEILING TO REMAIN.
- (3) PROVIDE NEW GRILLES IN NEW CEILING AS SHOWN, CONNECT S/A GRILLES TO EXISTING S/A DUCT AND PROVIDE ANY DUCT MODIFICATIONS AS REQUIRED. (TYPICAL)
- (4) EXISTING LINEAR SLOT S/A DIFFUSERS TO BE REPLACED.
- (5) EXISTING PRE-CONDITIONED OUTSIDE AIR DUCT RISER FROM ROOFTOP A/C UNIT, TO REMAIN AS IS.
- (6) EXISTING OUTSIDE AIR DUCT ABOVE CEILING TO REMAIN.
- (7) PROVIDE FIRE DAMPER WHERE OUTSIDE AIR DUCT PENETRATES NEW CORRIDOR WALL.
- (8) EXISTING 14X8 TRANSFER AIR OPENING WITH FIRE DAMPER ABOVE CEILING TO REMAIN AS IS. PROVIDE PER UNIT ADD ALTERNATE PRICE TO REPLACE ANY DEFECTIVE DAMPERS.

- (9) EXISTING FIRE DAMPER AND MANUAL VOLUME DAMPER TO REMAIN AS IS. PROVIDE ADD ALTERNATE PER UNIT PRICE TO REPLACE ANY MISSING OR DEFECTIVE DAMPERS.
- REMOVE EXISTING FIRESTAT AND PROVIDE NEW DUCT SMOKE DETECTOR AS SHOWN. FAN COIL UNIT IS TO BE SHUTDOWN UPON DETECTION OF SMOKE.
- (11) EXISTING 14X8 TRANSFER AIR OPENING WITH FIRE DAMPER ABOVE CEILING TO BE RE-LOCATED INTO NEW WALL AS SHOWN. PROVIDE ALTERNATE PRICE TO REPLACE.
- 12) PROVIDE FIRE DAMPER AS SHOWN. ALL WORK INSIDE BATHROOMS IS PROVIDED UNDER SEPARATE PERMIT.
- (13) EXTEND EXISTING S/A DUCT TO NEW FIRE DAMPER.
- PROVIDE ADD ALTERNATE PRICE TO REPLACE HEAT PUMP A/C UNIT PER SCHEDULE. REPLACE ALL ASSOCIATED DÉVICES INCLUDING VALVES, UNIONS, FLEXIBLE PIPING AND DRAIN PAN. SEE DETAIL.
- (15) REMOVE EXISTING THERMOSTAT IN THIS LOCATION AND PROVIDE NEW THERMOSTAT PER BUILDING STANDARDS. COORDINATE ALL DETAILS AND REPROGRAMMING OF BMS WITH THE BUILDING ENGINEER AS NEEDED.

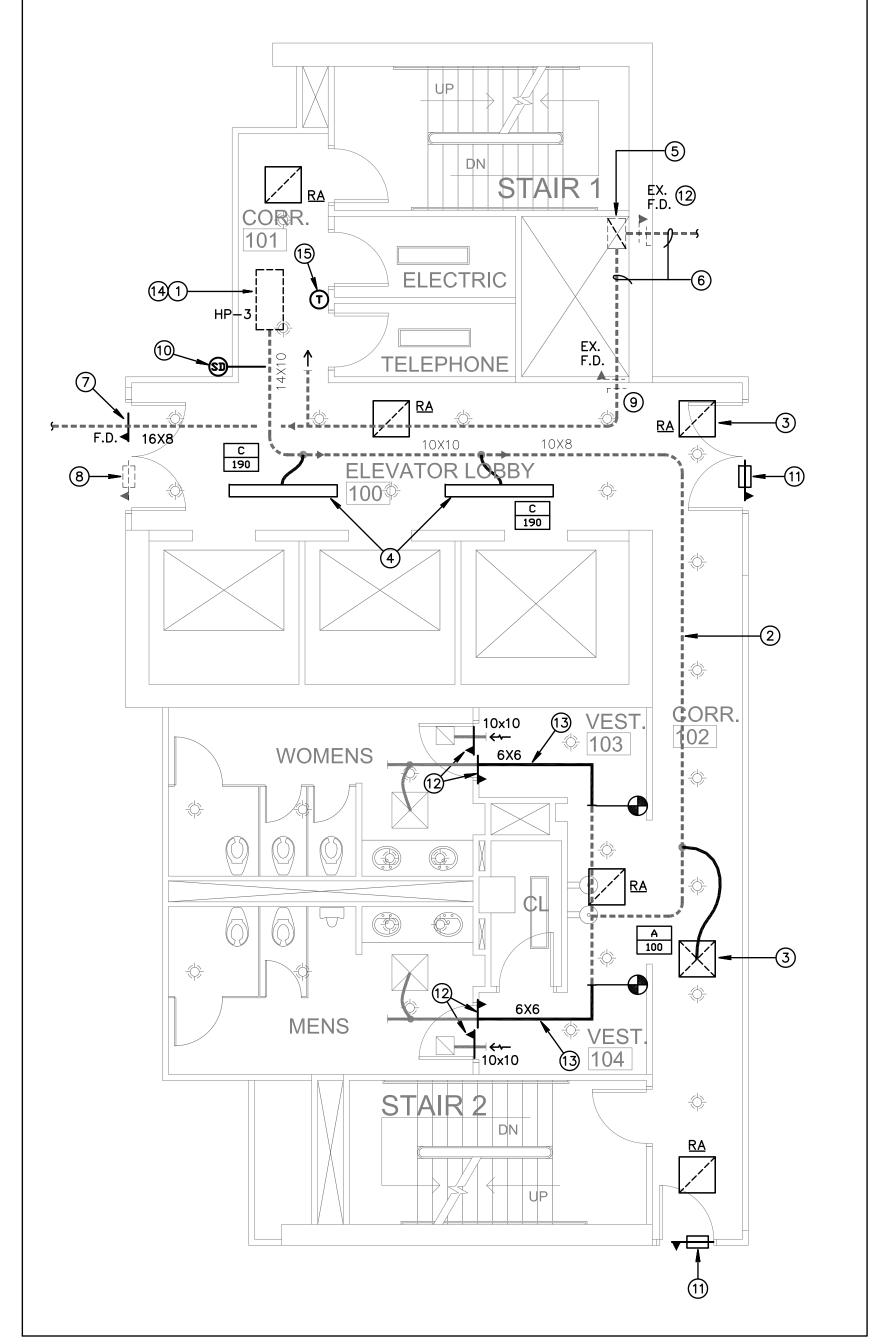


PROPOSED HVAC 3RD FLOOR PLAN

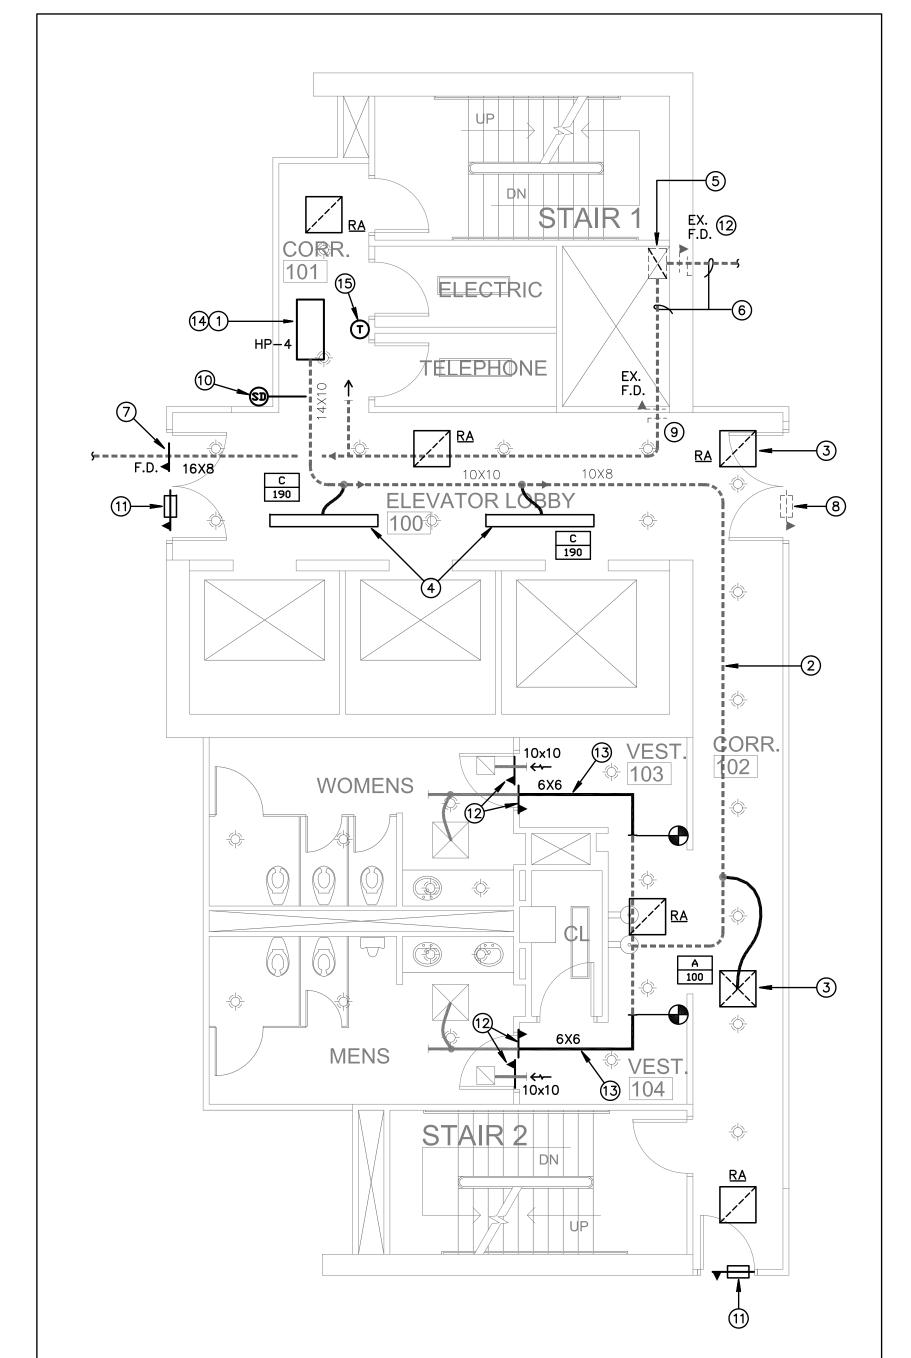

PROPOSED HVAC 4TH FLOOR PLAN

SCALE: 3/16" = 1'-0"

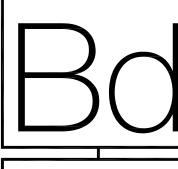

___ $\frac{1}{2}$ \bigcirc \mathcal{O}

CORRIDOR IMPROVEMEN

DRAWN BY GD

CD



MECHANICAL GENERAL NOTES:

- 1. THESE DRAWINGS ARE DIAGRAMMATIC. ALL OFFSETS, FITTINGS, TRANSITIONS AND ACCESSORIES ARE NOT SHOWN. THE CONTRACTOR SHALL INCLUDE IN HIS BID ALL ITEMS REQUIRED TO PROVIDE A COMPLETE AND OPERATIONAL SYSTEM. DO NOT SCALE DRAWINGS FOR INSTALLATION.
- 2. ALL WORK SHALL BE PERFORMED IN A FIRST CLASS WORKMANLIKE MANNER BY LICENSED CONTRACTORS.
- 3. THE CONTRACTOR SHALL OBTAIN AT HIS EXPENSE ALL NECESSARY FEES PERMITS, AND TESTS.
- 4. ALL WORK SHALL CONFORM TO ALL APPLICABLE LOCAL, STATE AND NATIONAL CODES. NO CONTRACTOR SHALL BID UNLESS FAMILIAR WITH THESE CODES.
- 5. CORRECTION OF DEFECTS TO THIS WORK SHALL BE MADE PROMPTLY WITHOUT CHARGE TO THE OWNER. REPAIR AND REPLACEMENT FOR DAMAGE CAUSED BY

THIS CONTRACTOR SHALL BE MADE PROMPTLY WITHOUT CHARGE TO THE OWNER.

- 6. ALL WORK OF THIS TRADE SHALL BE COORDINATED WITH ALL OTHER TRADES TO AVOID ANY INTERFERENCES THAT MAY DELAY PROGRESS OF CONSTRUCTION.
- 7. THE CONTRACTOR SHALL INCLUDE THE WORK OF ALL REQUIRED SUB—
 CONTRACTORS, SUCH AS ELECTRICAL, INSULATING, TEST & BALANCE, ETC.,
 AS REQUIRED FOR A COMPLETE AND OPERATIONAL SYSTEM.
- 8. EQUIPMENT SHALL BEAR A U.L. OR OTHER RECOGNIZED LABEL, NAMEPLATES, WIRING DIAGRAMS, AND ENERGY RATINGS AS APPLICABLE.
- 9. THE CONTRACTOR SHALL INSTALL ALL EQUIPMENT AND ACCESSORIES TO BE READLY ACCESSIBLE FOR SERVICING, TESTING, BALANCING, AND REPLACEMENT.
- 10. THE CONTRACTOR SHALL PROVIDE A WRITTEN GUARANTEE AGAINST DEFECTS IN ALL MATERIALS AND WORKMANSHIP FOR ONE YEAR FROM ACCEPTANCE, WITH FOUR ADDITIONAL YEARS OF WARRANTY ON COMPRESSORS.
- 11. THE CONTRACTOR SHALL PROVIDE THREE COPIES OF SUBMITTAL DATA, SHOP DRAWINGS, AND AT COMPLETION OF THE PROJECT TWO SETS OF OPERATION AND MAINTENANCE MANUALS FOR ALL PROJECT ITEMS.
- 12. PROVIDE ALL CONTROLS, STARTERS, CONTROL WIRING, DISCONNECTS, AND OTHER ELECTRICAL EQUIPMENT AS REQUIRED FOR A COMPLETE AND OPERATIONAL SYSTEM.
- 13. THE HVAC CONTRACTOR IS RESPONSIBLE FOR MAINTAINING, ON SITE, A DETAILED AS—BUILT PLAN SHOWING ACTUAL INSTALLATIONS. THE CONTRACTOR IS TO PROVIDE A NEATLY DRAWN COMPREHENSIVE AS—BUILT SET OF PLANS UPON COMPLETION, WHICH ARE SUITABLE FOR SUBMISSION TO THE BUILDING DEPARTMENT AND TO THE OWNER.
- 14. PRIOR TO ACCEPTANCE BY THE OWNER THE SYSTEMS SHALL BE TESTED AND BALANCED BY AN INDEPENDENT NEBB CERTIFIED T&B CONTRACTOR EXPERIENCED WITH THIS SYSTEM, AND CERTIFIED T&B REPORTS SUBMITTED.
- 15. SUPPLY AND INSTALL DUCT MOUNTED SMOKE DETECTORS AS REQUIRED.
- 16. COORDINATE LOCATION OF CEILING DIFFUSERS, GRILLES AND REGISTERS IN THE FIELD WITH LIGHTS AND ARCHITECTURAL ELEMENTS.
- 17. ALL GRILLES TO BE TITUS OR METALLAIRE UNLESS OTHERWISE NOTED, SIZES AS SHOWN ON PLANS, ALUMINUM CONSTRUCTION.
- 18. ALL DUCT WORK SHALL BE BUILT AND INSTALLED IN ACCORDANCE WITH SMACNA STANDARDS AND LOCAL BUILDING CODES.
- 19. ALL DUCT SIZES ARE CLEAR INSIDE DIMENSIONS.
- 20. ALL OUTSIDE AIR DUCTWORK SHALL BE SHEETMETAL WITH EXTERIOR R-6 INSULATION. PROVIDE BLANKET TYPE INSULATION IN CONCEALED SPACES, AND BOARD TYPE IN EXPOSED AREAS.
- 21. ALL EXHAUST AIR DUCT SHALL BE GALVANIZED SHEET METAL CONSTRUCTED AND INSTALLED IN ACCORDANCE WITH ASHRAE AND SMACNA STANDARDS.
- 22. FLEXIBLE DUCT, WHERE SHOWN, SHALL BE U.L. CLASS 1, R-6 INSULATION.
- 23. LOW PRESSURE SUPPLY AND RETURN DUCTWORK IS RIGID DUCTBOARD WITH VAPOR BARRIER, 1 IN. THICK, R-4.2 INSULATION, EXCEPT AS NOTED.
- 24. PROVIDE ELBOW TURNING VANES IN ALL RECTANGULAR DUCTS WHERE TURNS ARE GREATER THAN 45 DEGREES.
- 25. PROVIDE BACKDRAFT DAMPERS FOR ALL EXHAUST FANS.
- 26. VERIFY ALL THERMOSTAT LOCATIONS WITH THE ARCHITECT.
- 27. CONDENSATE DRAIN PIPING IS COPPER WITH SOLDERED FITTINGS AND ARMAFLEX INSULATION.

GENERAL DEMOLITION NOTES


- 1. UNLESS OTHERWISE NOTED, ALL EQUIPMENT AND DUCTWORK IN THE PROJECT AREA WHICH IS NOT INDICATED TO REMAIN, IS TO BE REMOVED. THE CONTRACTOR SHALL INVESTIGATE THE PROJECT AREA PRIOR TO BID TO DETERMINE ALL REQUIRED DEMOLITION.
- 2. EXISTING CONDITIONS SHOWN ON THIS DRAWING ARE TAKEN FROM ORIGINAL DRAWINGS AND FIELD INVESTIGATION. ALL EXISTING CONDITIONS MUST BE VERIFIED PRIOR TO BID. FIELD CONDITIONS SHALL GOVERN.
- DEMOLITION WORK IS NOT SPECIFICALLY IDENTIFIED ON THESE PLANS, AND MAY BE DESCRIBED ON THE ARCHITECTS PLANS. THE CONTRACTOR IS RESPONSIBLE FOR ALL REQUIRED DEMOLITION WHETHER SHOWN ON THE PLANS OR NOT.
- 4. ALL MECHANICAL SYSTEMS SERVING OTHER SPACES OR FLOORS, THAT RUN THROUGH THE PROJECT AREA SHALL REMAIN ACTIVE DURING CONSTRUCTION, SO AS NOT TO CAUSE ANY DISRUPTION TO THESE OTHER SPACES.
- 5. ALL ITEMS REMOVED UNDER THIS PROJECT SHALL BE DISPOSED OF OR TURNED OVER TO THE OWNER AT THE OWNER'S DISCRETION.
- 6. PROPERLY REMOVE AND DISPOSE OF ALL HVAC DUCTWORK AND AIR DISTRIBUTION DEVICES WHICH ARE TO BE REMOVED. CONSULT WITH OWNER AND OBTAIN THE OWNER'S APPROVAL PRIOR TO DISPOSAL OF REMOVED MATERIAL.
- IT IS THE CONTRACTOR'S RESPONSIBILITY TO ENSURE THAT ALL PIPING AND DUCTS, NEW OR EXISTING, WITHIN THE PROJECT AREA, ARE PROPERLY SUPPORTED.
- 8. ANY UN-USED DUCT OPENINGS ARE TO BE CLOSED, SEALED AND INSULATED WITH MATERIALS AND METHODS TO MATCH EXISTING INSTALLATIONS.


	<u>AIR DISTRIBUTION SCHEDULE</u>										
MARK	MAKE	MODEL	SIZE	NECK	MATERIAL	BORDER TYPE	MOUNTING TYPE	DAMPER	THROW	FINISH	REMARKS
Α	TITUS	TDC-AA	9X9	6 " ø	ALUMINUM	3	LAY-IN	AG-100	4 WAY	WHITE	SEE NOTES
В	TITUS	TDC-AA	12X12	8"ø	ALUMINUM	3	LAY-IN	AG-100	4 WAY	WHITE	SEE NOTES
С	TITUS	MLS-38	2 SLOT 3/4"	-	ALUMINUM	1	SURFACE	_	2 WAY	WHITE	SEE NOTES
RA	TITUS	50F	-	22X22	ALUMINUM	3	LAY-IN	AG-15	_	WHITE	SEE NOTES
RB	TITUS	50F	-	14X14	ALUMINUM	1	SURFACE	AG-15	_	WHITE	SEE NOTES
RC	TITUS	50F	_	10X10	ALUMINUM	1	SURFACE	AG-15	_	WHITE	SEE NOTES


PROVIDE INTEGRAL VOLUME DAMPERS WHERE SHOWN ON PLAN OR WHERE DAMPER IN DUCTWORK IS NOT ACCESSIBLE ABOVE CEILING. PROVIDE SQUARE TO ROUND ADAPTERS WHERE REQUIRED FOR ROUND DUCT CONNECTION.

PROVIDE SQUARE TO ROUND ADAPTERS WHERE REQUIRED FOR ROUND DUCT CONN PROVIDE SAMPLE WITH OFF-WHITE FINISH TO ARCHITECT FOR APPROVAL.

PROVIDE FLEXIBLE DUCT SIZED TO MATCH S/A DIFFUSER NECK UNLESS NOTED OTHERWISE. FIELD VERIFY EXACT SIZE OF EXISTING SLOT DIFFUSERS PRIOR TO ORDERING NEW.

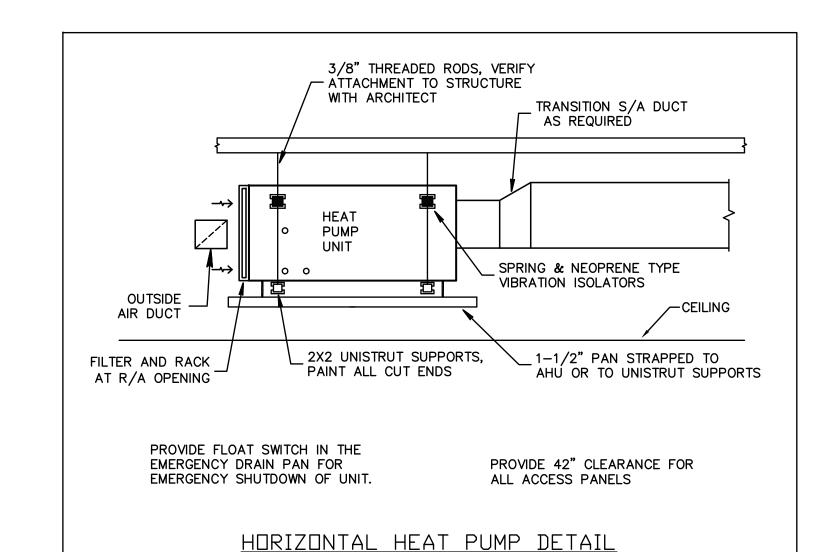


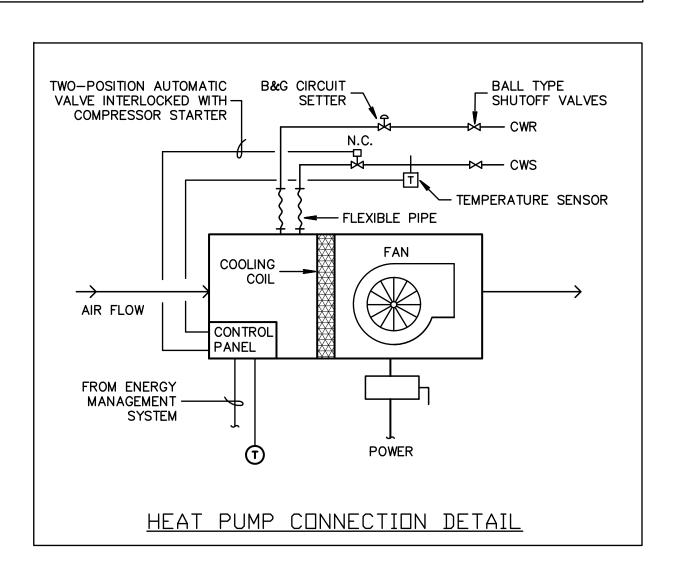

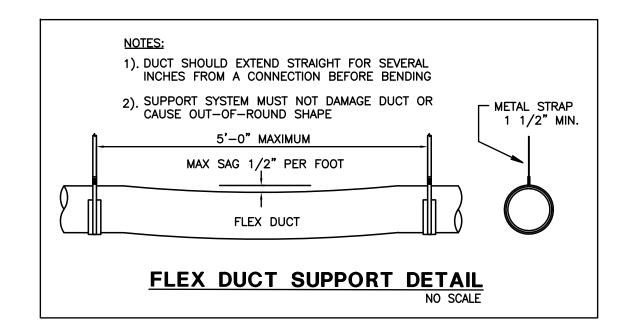


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NO SCALE

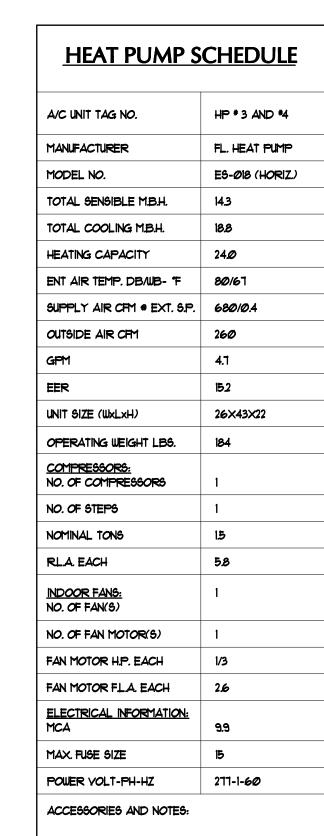

design inc.

5300 woodland lakes drive palm beach gardens, fl 334 phone 561-249-4001

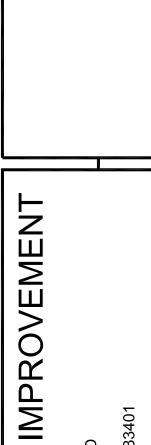

CORRIDOR IMPROVI
1400 CENTREPARK BLVD
3RD & 4TH FLOORS
WEST PALM BEACH, FL 33401

REVISIONS

1
2
3
4
5
THIS DESIGN AND THESE DRAWINGS ARE THE PROF BIRSE DESIGN INC, NO PART OF THIS WORK METERS.

DRAWN BY GD

PROJ.# 11-017

06/22/11

M-2

ELECTRICAL NOTES

- DO NOT SCALE THE ELECTRICAL DRAWINGS, REFER TO ARCHITECTURAL PLANS AND ELEVATIONS FOR EXACT LOCATION OF ALL EQUIPMENT. CONFIRM WITH OWNERS REPRESENTATIVE.
- 2. ALL WORK SHALL BE DONE IN ACCORDANCE WITH NATIONAL ELECTRICAL CDDE NFPA-70 (2005), THE LIFE SAFETY CDDE NFPA-101 (2003), THE NATIONAL FIRE ALARM CODE NFPA-72 (2002), AND THE FLORIDA BUILDING CODE (FBC 2004, WITH 2007 SUPPLEMENTS).
- MINIMUM WIRE SIZE SHALL BE #12 A.W.G., EXCLUDING CONTROL WIRING. UNLESS OTHERWISE NOTED ALL CONDUCTORS SHALL BE COPPER WITH THWN
- 4. DUTLET BOXES SHALL BE SHEET STEEL IN DRY LOCATIONS, CAST ALLOY WITH THREADED HUBS IN WET OR DAMP LOCATIONS AND SPECIAL ENCLOSURES AS REQUIRED FOR OTHER CLASSIFIED AREAS.
- DISCONNECT SWITCHES SHALL BE H.P. RATED , HEAVY DUTY, QUICK-MAKE, QUICK-BREAK ENCLOSURES AS REQUIRED BY EXPOSURE.
- MOTOR STARTERS SHALL BE MANUAL OR MAGNETIC , WITH OVERLOAD RELAYS IN EACH HOT LEG.
- 7. IT IS NOT THE INTENT OF THESE PLANS TO SHOW EVERY MINOR DETAIL OF CONSTRUCTION, THE CONTRACTOR IS EXPECTED TO FURNISH AND INSTALL ALL ITEMS FOR A COMPLETE ELECTRICAL SYSTEM AND PROVIDE ALL RE-QUIREMENTS NECCESSARY FOR EQUIPMENT TO BE PLACED IN PROPER WORKING
- 8. ELECTRICAL SYSTEM SHALL BE COMPLETE AND EFFECTIVELY GROUNDED AS REQUIRED BY THE LATEST EDITION OF THE N.E.C.
- 9. ALL MATERIALS SHALL BE NEW AND BEAR UNDERWRITERS' LABELS WHERE APPLICABLE.
- 10. ALL WORK SHALL BE PERFORMED BY A LICENSED ELECTRICAL CONTRACTOR IN A FIRST CLASS WORKMANLIKE MANNER. THE COMPLETED SYSTEM SHALL BE FULLY OPERATIVE, AND ACCEPTED BY ENGINEER/ARCHITECT.
- 11. ALL WORK SHALL BE COORDINATED WITH OTHER TRADES TO AVOID INTERFERENCE WITH THE PROGESS OF CONSTRUCTION.

- 12. CONTRACTOR SHALL GUARANTEE ALL MATERIALS AND WORKMANSHIP FREE FROM DEFECTS FOR A PERIOD OF NOT LESS THAN ONE YEAR FROM DATE OF ACCEPTANCE.
- 13. CORRECTION OF ANY DEFECTS SHALL BE COMPLETED WITHOUT ADDITIONAL CHARGE AND SHALL INCLUDE REPLACEMENT OR REPAIR OF ANY OTHER PHASE OF THE INSTALLATION WHICH MAY HAVE BEEN DAMAGED THEREBY.
- 14. ALL REQUIRED INSURANCE SHALL BE PROVIDED FOR PROTECTION AGAINST PUBLIC LIABILTY AND PROPERTY DAMAGE FOR THE DURATION OF THE WORK.
- 15. CONTRACTOR SHALL PAY FOR ALL PERMITS , FEES , INSPECTIONS , AND TESTING.
- 16. THE ELECTRICAL INSTALLATION SHALL MEET ALL STANDARD REQUIREMENTS OF POWER AND TELEPHONE COMPANIES.
- 17. FURNISH AND INSTALL DISCONNECT SWITCHES AND WIRING FOR AIR CONDITIONING SYSTEM AS PER MANUFACTURERS RECOMMENDATIONS, CONTROLS ARE TO BE SUPPLIED BY AIR CONDITIONING CONTRACTOR AND CONNECTED BY ELECTRICAL CONTRACTOR.
- 18. ALL RACEWAYS UNDERGROUND SHALL BE A MINIMUM OF 3/4"CONDUIT.
- 19. ALL CIRCUIT BREAKERS , TWO AND THREE POLE , TO BE COMMON TRIP. NO TIE HANDLES , OR TANDEMS WILL BE ACCEPTED.
- 20. ALL FUSES , UNLESS NOTED ON DRAWING , SHALL BE CURRENT LIMITING (C.L.) RATED FOR 200,000 A.I.C.
- 21. ALL ELECTRICAL EQUIPMENT, DEVICES, WIRE, ETC., SHALL BE LISTED, FOR THE INTENDED USE, WITH UNDERWRITER'S LABORATORIES, INC. (UL), WHERE STANDARDS HAVE BEEN ESTABLISHED BY UL.
- 21. THE CONTRACTOR IS RESPONSIBLE TO MAINTAIN, ON SITE, A DETAILED AS-BUILT PLAN SHOWING ACTUAL INSTALLATIONS. THE CONTRACTOR IS TO PROVIDE A NEATLY DRAWN COMPREHENSIVE AS-BUILT SET OF PLANS UPON COMPLETION, WHICH ARE SUITABLE FOR SUBMISSION TO THE BUILDING DEPARTMENT AND THE OWNER.

	LIGHTING FIXTURE SCHEDULE								
SYMBOL	TYPE	MOUNT	LAMP	VOLT	MANUFACTURER	CATALOG	REMARKS		
A	FLUORESCENT DOWNLIGHT	RECESSED	(1)26WTT 35K	277	PRESCOLITE	CFT632HEB-STF602H	2		
•	EXIT LIGHT	SURFACE	BY MFGR.	277	DUAL LITE	LXURW	1)		

- (1) PROVIDE SINGLE OR DUAL FACE, WALL OR CEILING MOUNT, AS SHOWN ON PLANS. CONNECT FIXTURES TO UNSWITCHED HOT LEG OF CIRCUIT.
- (2) PROVIDE MANUFACTURERS LABEL FOR MAXIMUM OF 26 WATT LAMP. TOTAL FIXTURE INPUT POWER TO BE 28 WATTS MAXIMUM.

LIGHTING POWER COMPLIANCE (PER TABLE 13-415.2.B, FBC CHAPTER 13)								
SPACE TYPE	TOTAL AREA (SQ.FT.)	ALLOWANCE PER SQ.FT.	SUB-TOTAL ALLOWANCE	DESIGN				
ELEVATOR LOBBYS	500	1.3	650	392				
CORRIDORS	952	0.5	476	728				
TOTALS	1,126	1,120						

KEYNOTES

- (1) CONNECT DESIGNATED EMERGENCY LIGHTING FIXTURES TO EXISTING EMERGENCY POWER LIGHTING CIRCUIT SERVING THIS AREA. EXISTING EMERGENCY POWER PANEL 'ELP1' IS LOCATED ON THE 1ST FLOOR AND PANEL 'ELP5' IS ON THE 4TH FLOOR.
- (2) CONNECT NORMAL POWER LIGHTING FIXTURES TO EXISTING NORMAL POWER LIGHTING CIRCUIT SERVING THIS AREA, FROM PANEL ON
- (3) PROVIDE SEPARATE LIGHTING CONTACTORS FOR THE EMERGENCY AND NORMAL POWER CORRIDOR LIGHTING CIRCUITS. CONTACTORS ARE TO BE CONTROLLED BY THE EXISTING BUILDING MANAGEMENT SYSTEM (BMS). PROVIDE ALL EQUIPMENT AND SOFTWARE PROGRAMMING AS REQUIRED FOR CONTROL BY THE BMS. COORDINATED ALL WORK WITH THE BUILDING'S BMS PROVIDER.
- 4 RE-LOCATE EXISTING SPEAKERS IN NEW CEILING SYSTEM (TYPICAL)
- (5) EXISTING FIRE ALARM STROBE @ 72" A.F.F. TO BE REMOVED AND REPLACED WITH NEW 75 CANDELA DEVICES MOUNTED @ 80" A.F.F. FIELD VERIFY THE EXACT QUANTITY OF DEVICES REQUIRED. (THERE ARE SOME COMPLIANT DEVICES EXISTING, MATCH THESE
- (6) REPLACE EXISTING DEVICES IN THE AREA OF WORK WITH NEW DEVICES AND FACEPLATES. VERIFY COLOR WITH ARCHITECT.

DEVICES). TYPICAL FOR ALL STROBES SHOWN.

(7) RELOCATE EXISTING FIRE ALARM SPEAKERS AND SMOKE DETECTORS IN NEW CEILING SYSTEM AS REQUIRED. (TYPICAL)

ELECTRICAL LEGEND

LIGHTING FIXTURE IDENTIFICATION

RECTANGULAR LIGHTING FIXTURE - AS NOTED

RECTANGULAR LIGHTING FIXTURE - EXISTING AS NOTED

ROUND LIGHTING FIXTURE

O+ WALL MOUNTED LIGHTING FIXTURE

EXIT LIGHT ON EMERGENCY POWER CIRCUIT

RECTANGULAR LIGHTING FIXTURE ON EMERGENCY POWER CIRCUIT.

ROUND LIGHTING FIXTURE ON EMERGENCY POWER CIRCUIT

DUPLEX RECEPT - 20 AMP (18" A.F.F.)

DUPLEX RECEPT MOUNTED ABOVE COUNTER - 20 AMP (42" A.F.F.)

SINGLE POLE TOGGLE SWITCH, 48" AFF

JUNCTION BOXES

ELECTRICAL PANELBOARD

CIRCUIT HOME RUN TO PANELBOARD OR OTHER DEVICE AS INDICATED

CONDUIT CONCEALED

EXISTING DUPLEX RECEPTACLE TO REMAIN.

TELEPHONE/DATA OUTLET - EXISTING TO REMAIN

EXISTING DEVICE TO REMAIN AS IS

EXISTING DEVICE TO BE RELOCATED AS SHOWN.

NEW DEVICE IN EXISTING DUTLET BOX (REPLACE EXISTING DEVICE)

EXISTING SINGLE POLE TOGGLE SWITCH TO REMAIN.

UNLESS OTHERWISE NOTED, ALL EQUIPMENT, WIRING DEVICES, LIGHT FIXTURES,

EXISTING CONDITIONS SHOWN ON THIS DRAWING ARE TAKEN FROM ORIGINAL

DRAWINGS AND FIELD INVESTIGATION. ALL EXISTING CONDITIONS MUST BE

DEMOLITION WORK IS NOT SPECIFICALLY IDENTIFIED ON THESE PLANS, AND MAY

BE DESCRIBED ON THE ARCHITECTS PLANS. THE CONTRACTOR IS RESPONSIBLE FOR

CONDUIT AND WIRE IN THE PROJECT AREA WHICH IS NOT INDICATED TO REMAIN, IS TO BE REMOVED. THE CONTRACTOR SHALL INVESTIGATE THE PROJECT AREA PRIOR

CONCEALED CIRCUIT AS NOTED

OCCUPANCY SENSOR, CEILING MOUNT, HUBBELL OMNI DT-2000

LIGHTING CONTACTOR

AFF ABOVE FINISHED FLOOR

GENERAL DEMOLITION NOTES

TO BID TO DETERMINE ALL REQUIRED DEMOLITION.

CAUSE ANY DISRUPTION TO THESE OTHER SPACES.

OVER TO THE OWNER AT THE OWNER'S DISCRETION.

APPROVAL PRIOR TO DISPOSAL OF REMOVED MATERIAL.

VERIFIED PRIOR TO BID. FIELD CONDITIONS SHALL GOVERN.

ALL REQUIRED DEMOLITION WHETHER SHOWN ON THE PLANS OR NOT.

4. ALL CONDUITS SERVING OTHER SPACES OR FLOORS. THAT RUN THROUGH THE

PROJECT AREA SHALL REMAIN ACTIVE DURING CONSTRUCTION, SO AS NOT TO

5. ALL ITEMS REMOVED UNDER THIS PROJECT SHALL BE DISPOSED OF OR TURNED

B. PROPERLY REMOVE AND DISPOSE OF ALL ELECTRICAL EQUIPMENT, CONDUIT AND

WIRING WHICH IS TO BE REMOVED. CONSULT WITH OWNER AND OBTAIN THE OWNERS

IT IS THE CONTRACTOR'S RESPONSIBLITY TO ENSURE THAT ALL CONDUITS, NEW OR

EXISTING, WITHIN THE PROJECT AREA, ARE PROPERLY SUPPORTED AND PROVIDED

WITH BONDING BUSHINGS IN ACCORDANCE WITH THE NATIONAL ELECTRIC CODE.

FIRE ALARM LEGEND

F MANUAL PULL STATION

WALL MOUNT SPEAKER/STROBE

PHOTOELECTRIC SMOKE DETECTOR

ADA COMPLIANT STROBE LIGHT MONITOR MODULE

DUCT SMOKE DETECTOR W/O RELAY

CONTROL MODULE OUTPUT RELAY

HEAT DETECTOR

(S) CEILING SPEAKER

← FIREMAN'S TELEPHONE OUTLET

AUDIBLE ALARMS SHALL HAVE A MINIMUM LEVEL OF 15 DBA IN EXCESS OF THE AMBIENT SOUND LEVEL OF THE ROOM, AND SHALL OTHERWISE BE IN ACCORDANCE WITH FBC 11-4.28.2.

OF 75 CANDELA AND SHALL OTHERWISE BE IN ACCORDANCE WITH FBC 11-4.28.3.

VISUAL ALARMS SHALL HAVE A MINIMUM LEVEL

PROVIDE A RE-CERTIFICATION OF THE FIRE ALARM SYSTEM UPON COMPLETION OF WORK.


NEW FIRE ALARM DEVICES ARE TO BE COMPATIBLE WITH EXISTING SYSTEM. PROVIDE ADDITIONAL POWER SUPPLIES AS REQUIRED. PROVIDE ADDITIONAL HORNS AND STROBES AS REQUIRED TO MEET AUDIBLE AND VISIBLE REQUIREMENTS OF NFPA 72, ADA, AND NFPA 101. VERIFY EXISTING POINT OF CONNECTION TO EXISTING SYSTEM. EXISTING DEVICES MAY BE RE-USED AT THE DISCRETION OF THE LANDLORD, VERIFY ALL SUCH EQUIPMENT PRIOR TO BID.

THE CONTRACTOR IS RESPONSIBLE FOR ENSURING THAT ALL NEW AND EXISTING ELECTRICAL SYSTEMS, FIXTURES, DEVICES, AND OTHER EQUIPMENT RELATED TO THE AREA OF WORK ARE IN GOOD WORKING ORDER. REPAIR AS NEEDED.

ELP1-9 € LP3-4 ELEVATOR LOBBY 🍑 104 SEE OTHER PLANS FOR WORK INSIDE BATHROOMS, TO BE -PROVIDED UNDER SEPARATE PERMIT


PARTIAL 3RD FLOOR ELECTRICAL PLAN

SCALE: 3/16" = 1'-0"

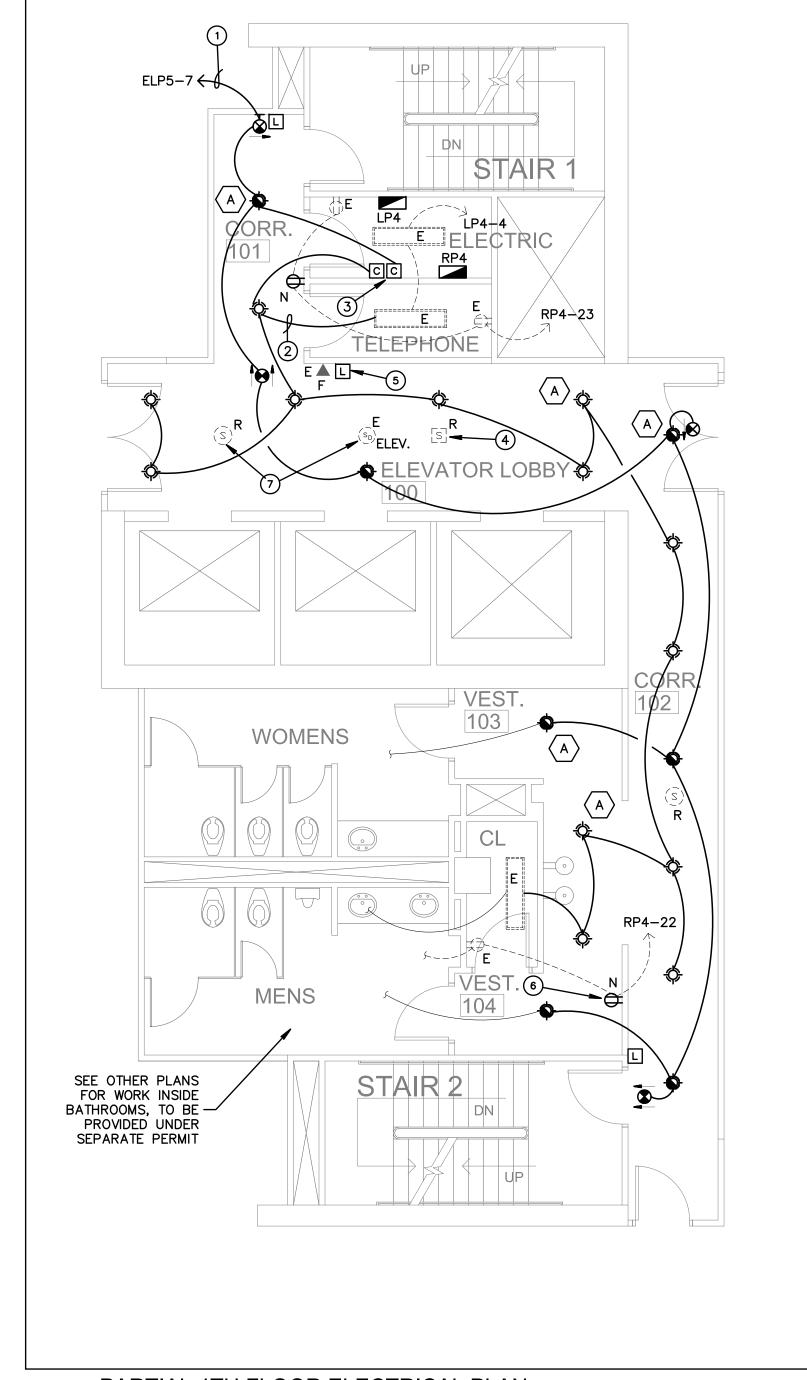

PARTIAL 4TH FLOOR ELECTRICAL PLAN

SCALE: 3/16" = 1'-0"

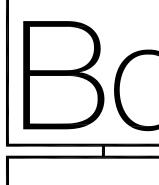

IMPROVEM

ORRIDOR

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PROJ.# 11-017

DRAWN BY GD

birse design inc + architecture + interior design + planning


5300 woodland lakes drive palm beach gardens, fl 33418

phone 561-249-4001 fax 772-409-8684 AA26001615

MECHANICAL ENGINEER / ELECTRICAL / PLUMBING



129 N. FEDERAL HWY. SUITE 211 LAKE WORTH, FL 33460 (561) 582-0210 P.E. 37933

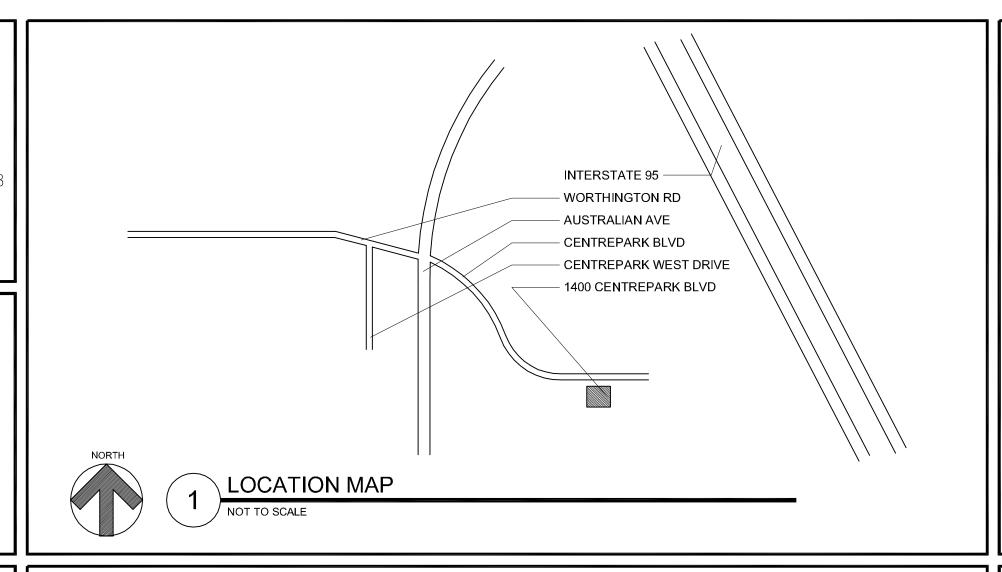

INDEX OF SHEETS:

T TITLE SHEET


ARCHITECTURAL SHEETS

A-1 FLOOR PLAN/NOTES

A-2 ELEVATIONS


MECHANICAL/ELECTRICAL/PLUMBING SHEETS
M-1 MECHANICAL

E-1 ELECTRICAL

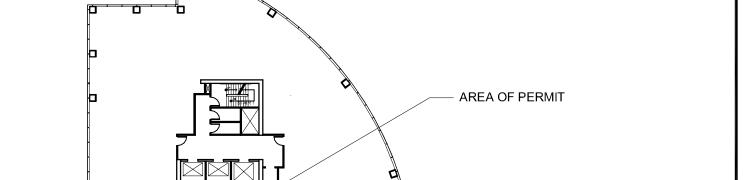

* AREA FOR THIS PERMIT IS HATCHED

* AREA FOR THIS PERMIT = 347 SF

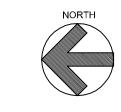

2 KEY MAP (3R

SYMBOL INDEX:

ADMIN. — ROOM NAME

108 — ROOM NUMBER

A DOOR MARK/NUMBER

1 window mark/number

WALL SECTION/SHEET NUMBER



ELEVATION TARGET/SHEET NUMBER

DETAIL NUMBER/SHEET NUMBER

8'-6" CEILING HEIGHT

2'x4' FLUORESCENT LIGHT FIXTURE


- FIRE EXTINGUISHER

WALL MOUNTED LIGHT FIXTURE

RECESSED LIGHT DOWN FIXTURE

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WITHOUT APPROVAL FROM BIRSE DESIGN, INC. THE DRAWINGS AND SPECIFICATIONS REMAIN THE PROPERTY OF BIRSE DESIGN, INC.

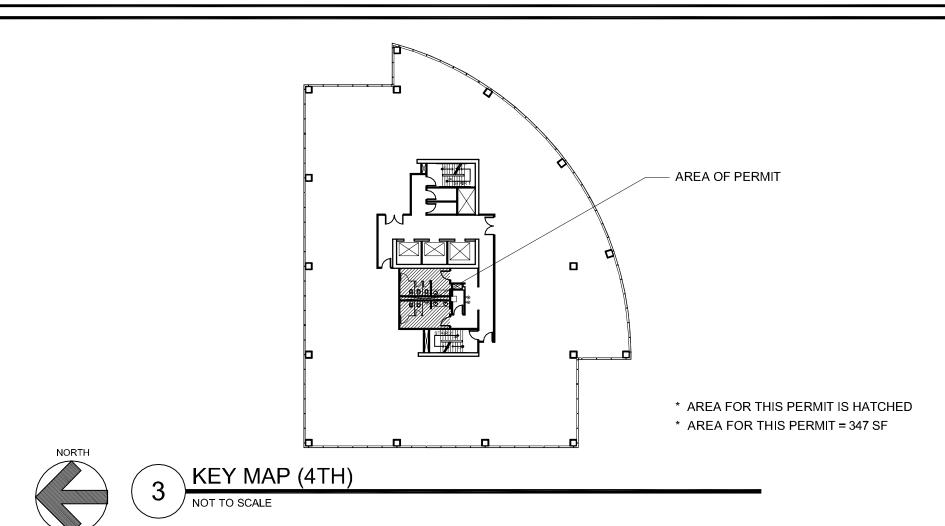

PROJECT DATA:

* PROJECT ADDRESS: 1400 CENTREPARK BLVD 3RD & 4TH FLOORS

WEST PALM BEACH, FL 33410

* EXISTING BUILDING IS TYPE I "A"

* EXISTING BUILDING IS A 10 STORY BUILDING

* EXISTING BUILDING CLASSIFICATION IS GROUP "B"

* LEVEL 2 ALTERATION PER "EXISTING BUILDING CODE 2007"

REFERENCE STANDARDS:

THIS PROJECT IS DESIGNED IN ACCORDANCE WITHE FOLLOWING CODES:

1. THE FLORIDA BUILDING CODE (FBC), 2007 EDITION WITH 2009 SUPPLEMENTS (BUILDING, MECHANICAL, PLUMBING, FUEL GAS, EXISTING BUILDING).

2. NATIONAL ELECTRIC CODE (NEC), 2008 EDITION.

3. FLORIDA FIRE PREVENTION CODE, 2007 EDITION.

4. NATIONAL FIRE PROTECTION ASSOCIATION (NFPA) 101, LIFE SAFETY CODE, 2006 EDITION.

5. NATIONAL FIRE PROTECTION ASSOCIATION (NFPA) 1, UNIFORM FIRE CODE, 2006 EDITION.

GENERAL NOTES:

1. THE CONTRACTOR SHALL AS A PART OF THIS CONTRACT FURNISH ALL MATERIALS, LABOR, TOOLS, EQUIPMENT, TRANSPORTATION, AND INSURANCE NECESSARY TO PROPERLY EXECUTE AND COMPLETE THE WORK ACCORDING TO THE PLANS AND SPECIFICATIONS.

2. THE CONTRACTOR IN THE WORK OF ALL TRADES SHALL PROTECT ALL EXISTING BUILDING AND PROPERTY FROM DAMAGE CAUSED BY THE ACTIVITIES OF THE CONTRACTOR AND SUBCONTRACTORS. THE CONTRACTOR SHALL REPAIR AND RESTORE THE JOB SITE AND SURROUNDING AREAS TO IT'S ORIGINAL CONDITION. OWNER TO VERIFY SATISFACTION.

3. THE CONTRACTOR SHALL VISIT THE JOB SITE TO VERIFY ALL EXISTING CONDITIONS PRIOR TO BID. CONTRACTOR TO NOTIFY ARCHITECT OF ANY DISCREPANCIES,INCONSISTENCIES OR OMISSIONS BEFORE PROCEEDING WITH ANY WORK.

ANY DISCREPANCIES, INCONSISTENCIES OR OMISSIONS BEFORE PROCEEDING WITH ANY WORK.

4. THE CONTRACTOR SHALL MAKE NO CHANGES TO THE CONSTRUCTION DRAWINGS WITHOUT WRITTEN APPROVAL FROM THE ARCHITECT.

5. ALL CONSTRUCTION SHALL CONFORM WITH THE LATEST CODES AND ORDINANCES.

6. THESE CONSTRUCTION DOCUMENTS ARE DIAGRAMATIC AND ARE TO CONVEY DESIGN INTENT. IT IS NOT THE INTENT OF THESE CONSTRUCTION DRAWINGS TO SHOW ALL DETAILS OF THE EXISTING CONDITIONS. THE CONTRACTOR SHALL VISIT THE SITE TI VERIFY DIMENSIONS PRIOR

7. EACH CONTRACTOR SHALL ESTABLISH AND VERIFY ALL OPENINGS AND INSERTS FOR MECHANICAL, ELECTRICAL, AND PLUMBING WITH THE APPROPRIATE TRADES.

8. ALL INDICATED UTILITY AND STUB-IN LOCATIONS ARE FOR REFERENCE ONLY. THE EXACT LOCATIONS SHALL BE VERIFIED ON THE JOB SITE.

9. THE CONTRACTOR SHALL BE RESPONSIBLE FOR COORDINATING WITH ENGINEERING AND THE ARCHITECTURAL DRAWINGS FOR THE ACTUAL PLACEMENT OF THE WORK RELATIVE TO FIELD CONDITIONS.

10. THE CONTRACTOR SHALL BE RESPONSIBLE FOR THE OBTAINING INSTALLATION REQUIREMENTS FOR ALL BUILT-IN APPLIANCES, FIXTURES, AND

EQUIPMENT. VERIFY EXACT ROUGH-IN DIMENSIONS AND NOTIFY ARCHITECT OF ANY DISCREPANCIES PRIOR TO ROUGH-IN FRAME.

11. THE COST OF ADDITIONAL DESIGN WORK DUE TO ERRORS OR OMMISIONS IN CONSTRUCTION SHALL BE BORNE BY THE RESPECTIVE

10. DETAILS ON THE STRUCTURAL DRAWINGS (IF PROVIDED) ARE TYPICAL. VERIFY ALL DIMENSIONS WITH THE STRUCTURAL DRAWINGS.

12. CONTRACTOR TO BE RESPONSIBLE FOR CHECKING STRUCTURAL CALCULATIONS FOR SPECIFIC REQUIREMENTS OF STRUCTURAL CONNECTIONS. SUBMIT STEEL TRUSS CALCULATIONS AND SHOP DRAWINGS OF ALL STRUCTURAL STEEL AND MISCELLANEOUS METAL

FABRICATION BEFORE COMMENCING FABRICATION.

13. BIRSE DESIGN, INC. SHALL IN NO WAY BE RESPONSIBLE FOR THE CONSTRUCTION MEANS, METHODS, TECHNOLOGIGES, SEQUENCES OR PROCEDURES, OR FOR SAFETY PRECAUTIONS AND PROGRAMS IN CONNECTION WITH THE WORK. (THESE ARE SOLELY THE CONTRACTORS

RESPONSIBILITY UNDER THE CONTRACT FOR CONSTRUCTION.

14. EACH CONTRACTOR SHALL PROVIDE ALL NECESSARY TEMPORARY BRACING, SHORING, GUYING, OR OTHER MEANS TO AVOID EXCESSIVE

STRESSES AND TO HOLD STRUCTURAL ELEMENTS ASSOCIATED WITH WORK IN PLACE DURING CONSTRUCTION.

16. SPRINKLER SYSTEM: INSTALL FULL BUILDING SPRINKLER SYSTEM IN COMPLIANCE WITH THE REQUIREMENTS OF NFPA 13. SHOP DRAWINGS MUST BE APPROVED BEFORE INSTALLATIONS. PROVIDE OWNER WITH 2 COPIES OF PERMIT SETS.

17. ALL CONTRACTORS AND SUBCONTRACTORS SHALL BE RESPONSIBLE FOR MEETING THE REQUIREMENTS OF ALL CURRENT APPLICABLE BUILDING CODES AND ENFORCEMENT AGENCIES, FIRE MARSHALL, OR ANY OTHER BUILDING CODE ENFORCEMENT OFFICER AT NO EXTRA COST TO THE OWNER. NOTIFY THE ARCHITECT IN WRITING OF ANY DISCREPHANCIES PRIOR TO SUBMITTING A BID FOR THE PROJECT.

18. BASE BID SHALL INCLUDE BUT NOT BE LIMITED TO THE FOLLOWING:

A. ALL PERMITS AND FEES FOR ALL 1. BUILDING AND TRADE PERMITS.

2. ALL ACCESSORY AND SITE IMPROIVEMENT PERMITS.

B. ALL FILL REQUIRED TO MEET MINIMUM FINISHED FLOOR SLAB ELEVATION AND COMPACTION.

C. WATER METER HOOK-UP AND METER DEPOSITS. - OWNER RESPONSIBILITY

D. HOOK-UP AND FEES FOR UNDERGROUND SERVICE FROM FPL LOCAL PHONE & CABLE T.V. - OWNER RESPONSIBILITY

E. SOIL, CONCRETE AND ANY OTHER NECESSARY TESTING.

F. ENGINEERING STAKE OUTS AND SURVEYS INCLUDING FINAL TIE - IN SURVEY.G. CLEARING, GRUB, AND SITE PREPARATION, INCLUDING GRADING.

15. PROVIDE PORTABLE FIRE EXTINGUISHERS DURING CONSTRUCTION AS REQUIRED BY LOCAL CODES.

H. ALL BIDDERS AND THEIR SUBCONTRACTORS SHALL BE CURRENTLY LICENSED IN THE STATE OF FLORIDA.

I. THE OWNER RESERVES THE RIGHT TO REJECT ANY BIDS.

I. THE G.C. SHALL PROVIDE AN ESTIMATE OF TIME FOR COMPLETION.

J. THE G.C. SHALL PROVIDE AN ESTIMATE OF TIME FOR COMPLETION.
K. THE GENERAL CONTRACTOR SHALL PROVIDE PROOF OF INSURANCE FOR WORKMANS' COMPENSATION AND ANY OTHER INSURANCES REQUIRED BY THE OWNER FOR ALL EMPLOYEES EITHER DIRECTLY EMPLOYED BY THE

GENERAL CONTRACTOR OR BY HIS SUBCONTRACTORS.

L. THE CONTRACTOR SHALL CLEARLY LIST ANY WORK NOT

INCLUDED IN HIS BID.

M. PROVIDE FIRE DEPARTMENT KNOX BOX ADJACENT TO FRONT DOOR OF BLDG.

N. CONTRACTOR TO PROVIDE AS BUILT DRAWINGS. PROVIDE TWO COPIES OF PERMIT SET TO OWNER

Bo

DITSE OESIGN
5300 woodland takes drive
palm beach gardens, if 33418
phone 561-249-4001

ALLEN S BIRSE AR94279

RADE

RESTROOM UPGRAE

1400 CENTREPARK BLVD
3RD & 4TH FLOORS
MEST BAIM BEACH EL 33401


REVISIONS


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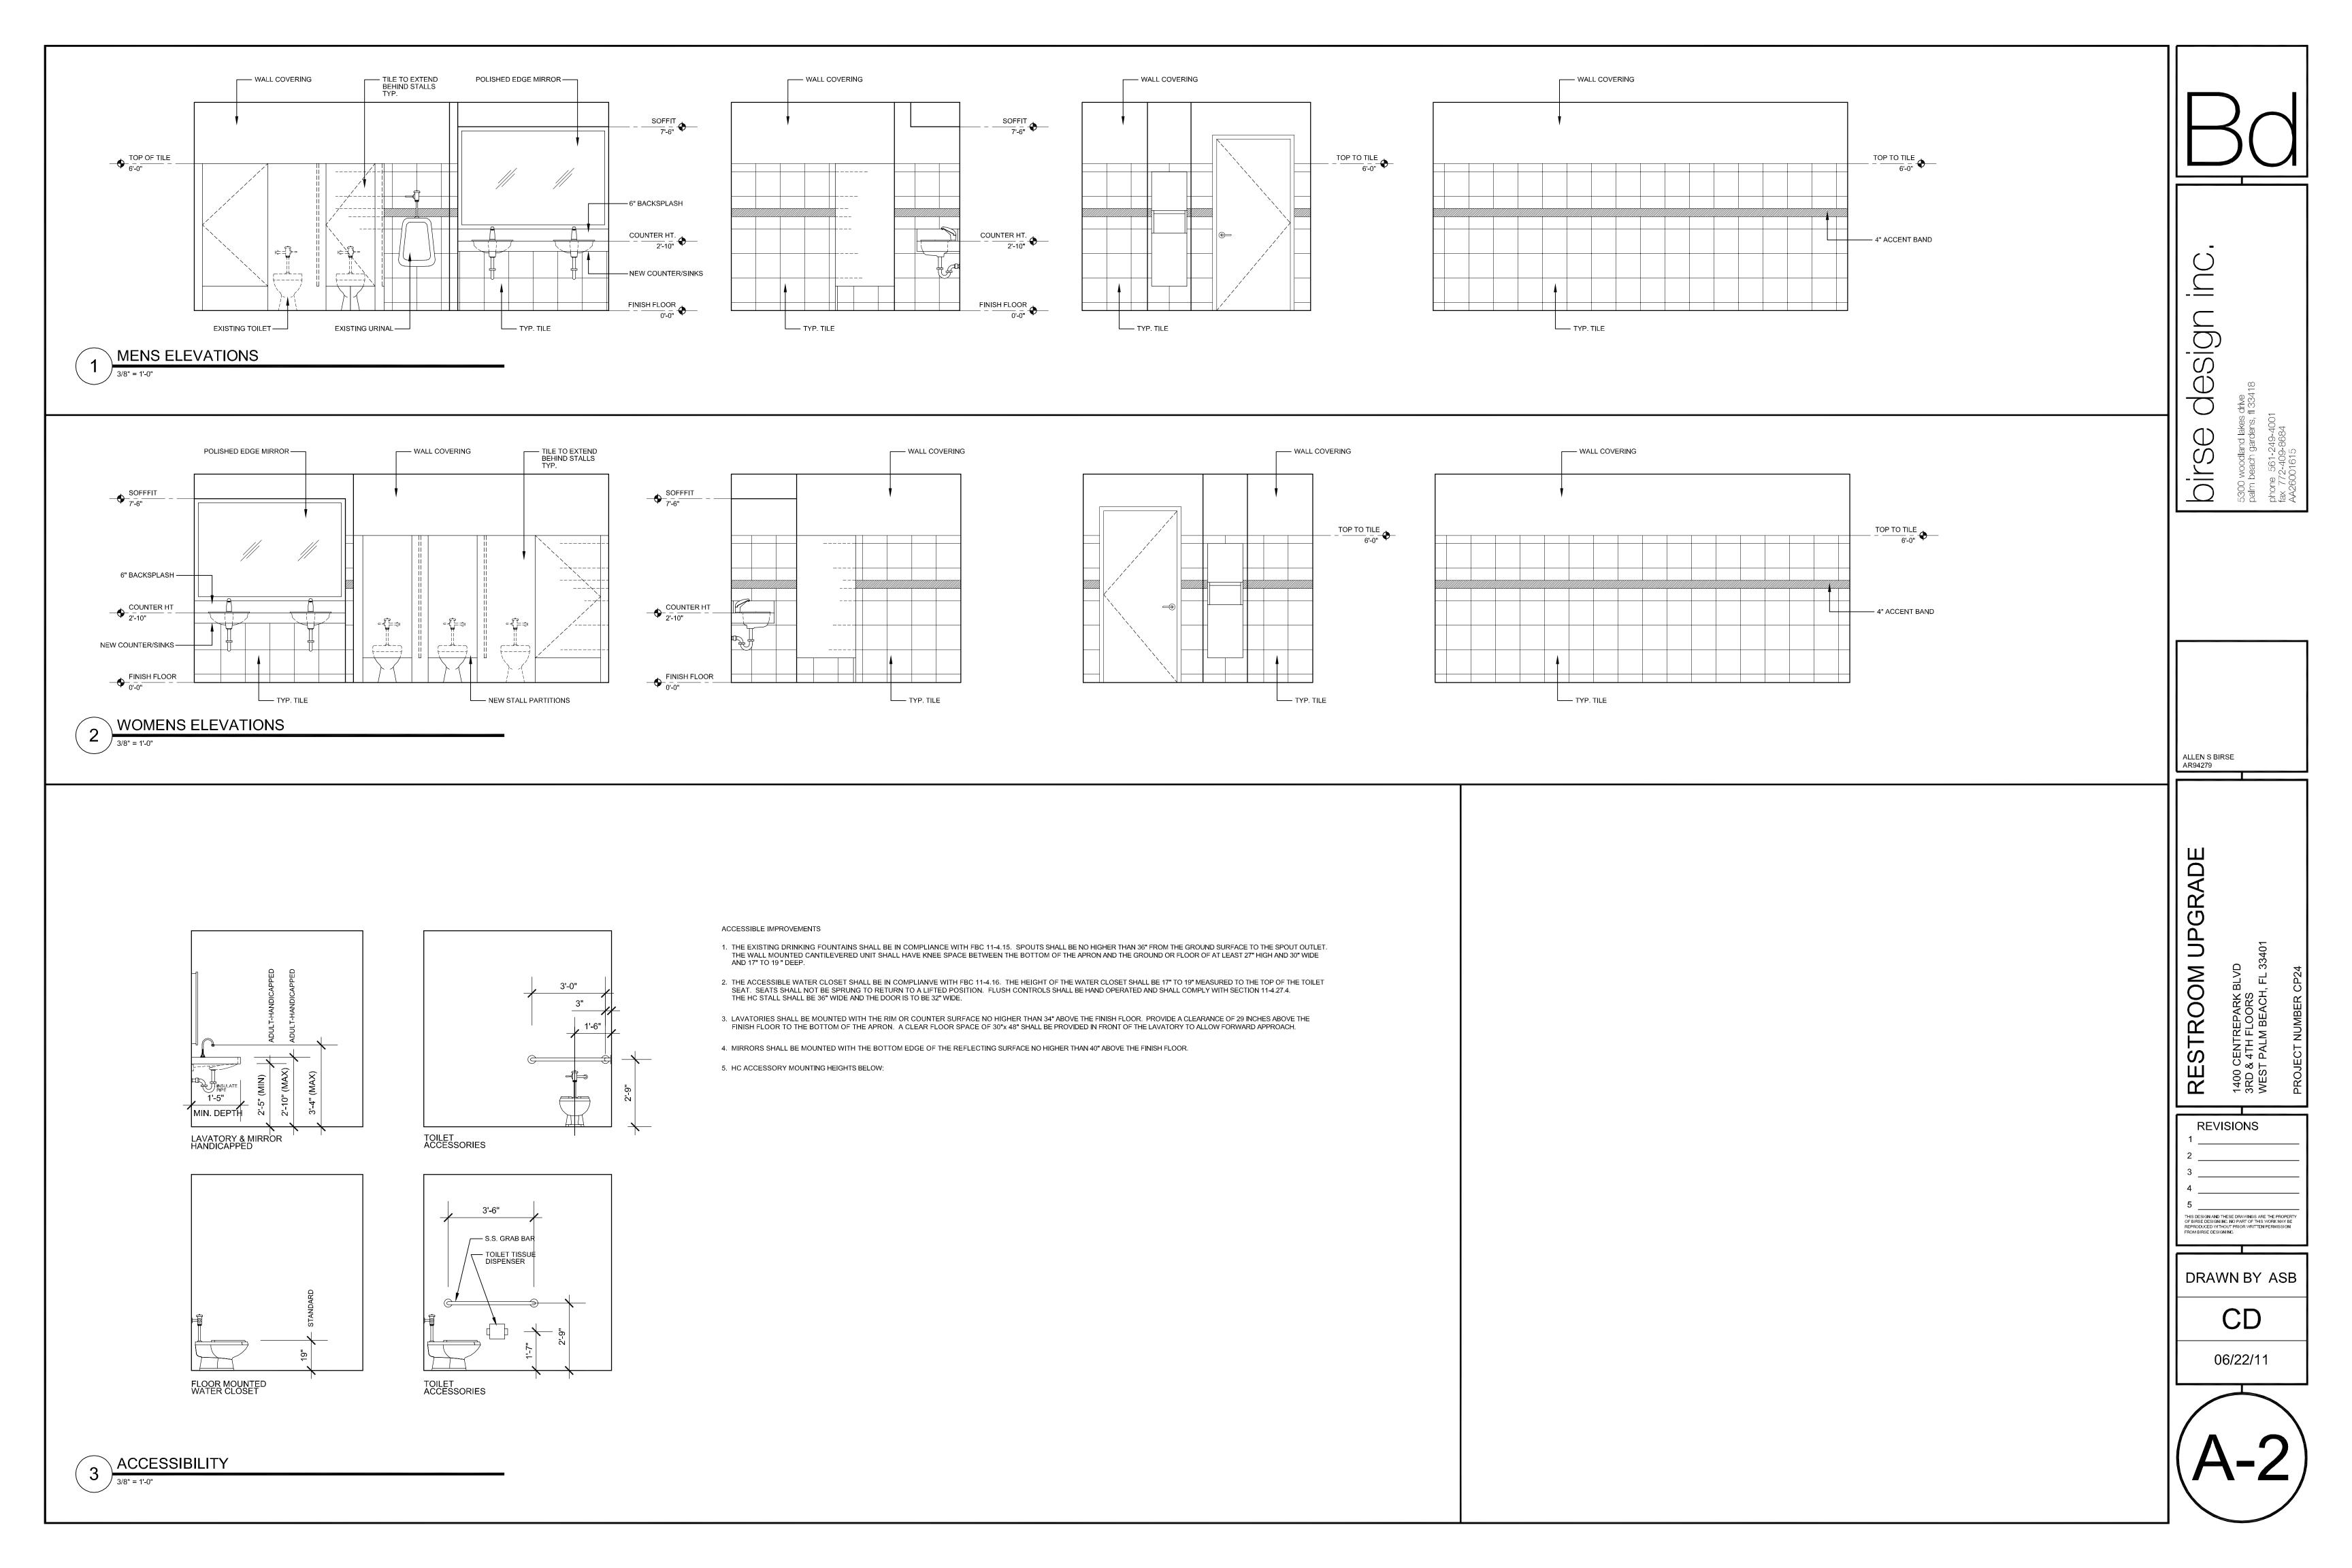
M BIRSE DESIGNING.

DRAWN BY ASB

CD



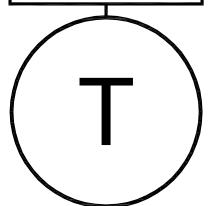

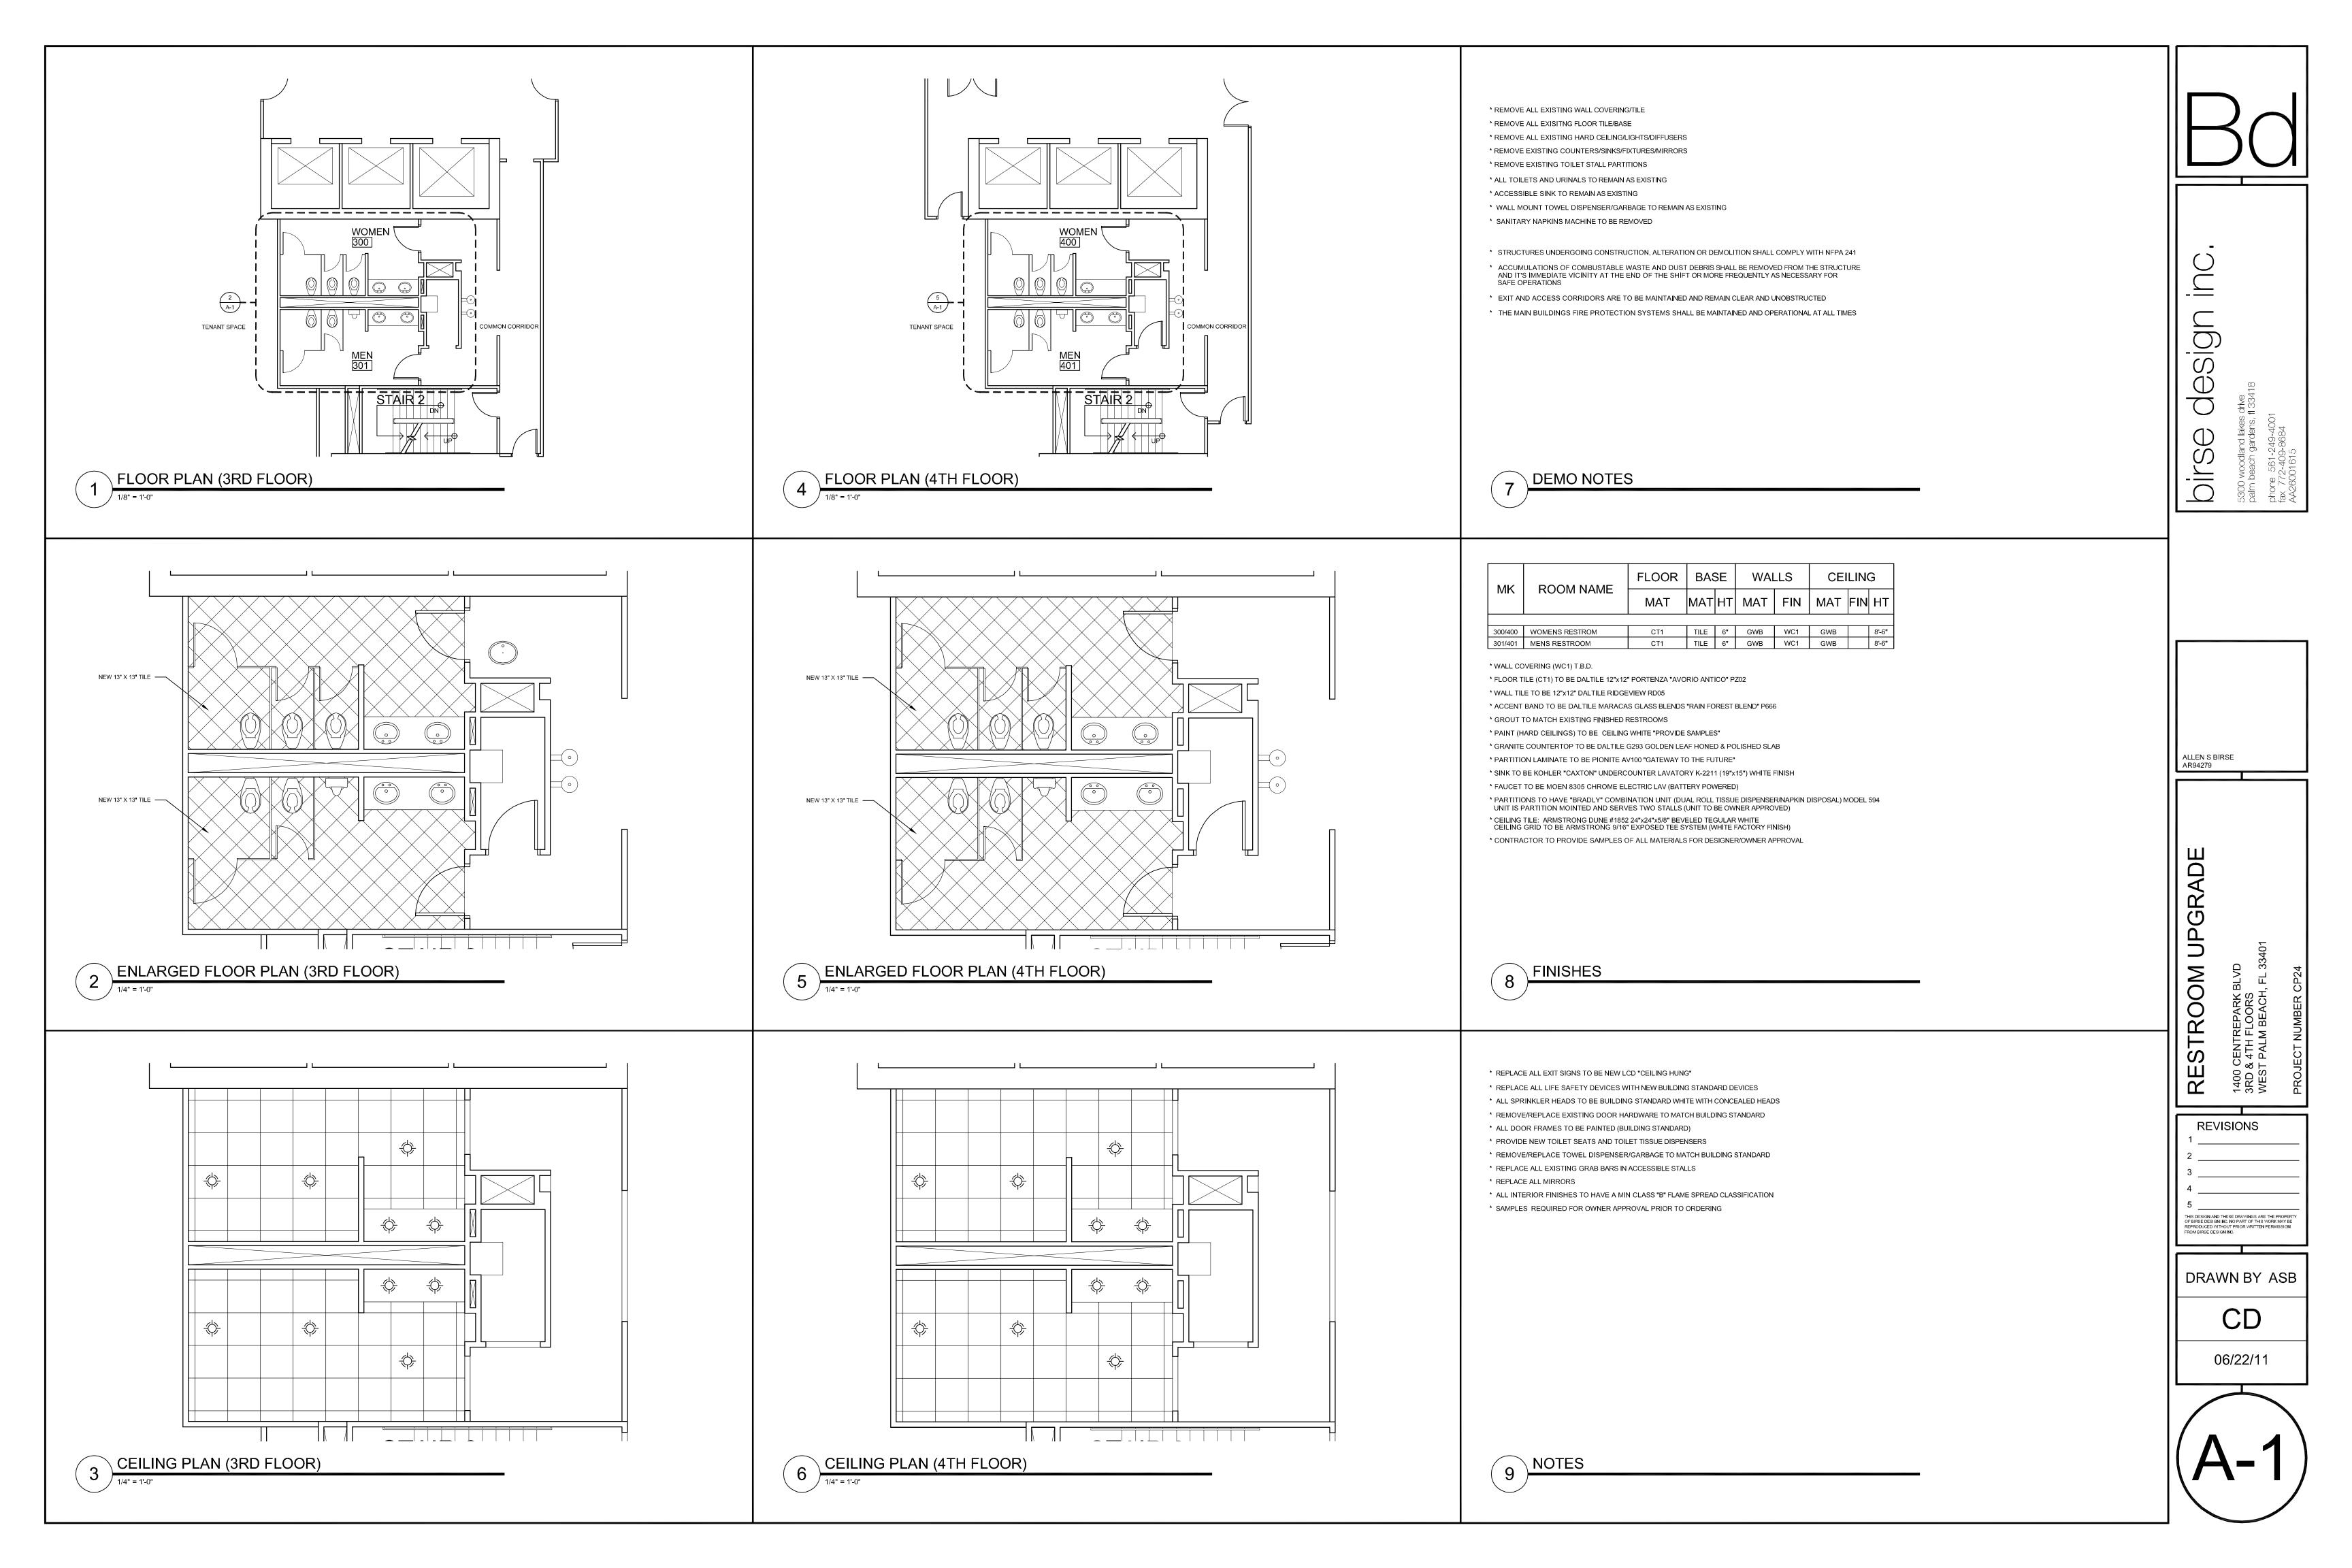

GENERAL DEMOLITION NOTES

- UNLESS OTHERWISE NOTED, ALL EQUIPMENT AND DUCTWORK IN THE PROJECT AREA WHICH IS NOT INDICATED TO REMAIN, IS TO BE REMOVED. THE CONTRACTOR SHALL INVESTIGATE THE PROJECT AREA PRIOR TO BID TO DETERMINE ALL REQUIRED DEMOLITION.
- EXISTING CONDITIONS SHOWN ON THIS DRAWING ARE TAKEN FROM ORIGINAL DRAWINGS AND FIELD INVESTIGATION. ALL EXISTING CONDITIONS MUST BE VERIFIED PRIOR TO BID. FIELD CONDITIONS SHALL GOVERN.
- BE DESCRIBED ON THE ARCHITECTS PLANS. THE CONTRACTOR IS RESPONSIBLE FOR ALL REQUIRED DEMOLITION WHETHER SHOWN ON THE PLANS OR NOT.

DEMOLITION WORK IS NOT SPECIFICALLY IDENTIFIED ON THESE PLANS. AND MAY

- ALL MECHANICAL SYSTEMS SERVING OTHER SPACES OR FLOORS, THAT RUN THROUGH THE PROJECT AREA SHALL REMAIN ACTIVE DURING CONSTRUCTION, SO AS NOT TO CAUSE ANY DISRUPTION TO THESE OTHER SPACES.
- ALL ITEMS REMOVED UNDER THIS PROJECT SHALL BE DISPOSED OF OR TURNED OVER TO THE OWNER AT THE OWNER'S DISCRETION.
- PROPERLY REMOVE AND DISPOSE OF ALL HVAC DUCTWORK AND AIR DISTRIBUTION DEVICES WHICH ARE TO BE REMOVED. CONSULT WITH OWNER AND OBTAIN THE OWNER'S APPROVAL PRIOR TO DISPOSAL OF REMOVED MATERIAL.
- IT IS THE CONTRACTOR'S RESPONSIBILITY TO ENSURE THAT ALL PIPING AND DUCTS, NEW OR EXISTING, WITHIN THE PROJECT AREA, ARE PROPERLY SUPPORTED.
- ANY UN-USED DUCT OPENINGS ARE TO BE CLOSED, SEALED AND INSULATED WITH MATERIALS AND METHODS TO MATCH EXISTING INSTALLATIONS.

DUCT STRAP SUPPORT EVERY - SUPPLY AIR DUCTWORK 48" OC AND AT EACH ELBOW -MINIMUM OF 1 REQUIRED FLEXIBLE DUCTWORK COMPRESSION FITTING PROVIDE REDUCER WHEN STARTING COLLAR DUCT SIZE IS SMALLER W/M.V.D. THAN DIFFUSER NECK CEILING DIFFUSER -FINISHED CEILING

NOTE: DO NOT PROVIDE DUCT TAKE-OFF WITH VOLUME DAMPER ABOVE INACCESSIBLE CEILINGS, PROVIDE DAMPER AT DIFFUSER.

CEILING DIFFUSER DETAIL

ABBREVIATIONS

CFM - CUBIC FEET PER MINUTE.

O/A - OUTSIDE AIR.

S/A - SUPPLY AIR.

R/A -RETURN AIR.

MANUAL VOLUME DAMPER

CWS - CONDENSER WATER SUPPLY CWR - CONDENSER WATER RETURN

MAKE

TITUS

TITUS

EX - EXISTING

MARK

RC

LEGEND

- SUPPLY AIR DIFFUSER
- RETURN, EXHAUST OR TRANSFER AIR
- MANUAL VOLUME DAMPER
- THERMOSTAT
- FLEXIBLE DUCT, U.L. CLASS 1 — DUCTWORK NOT SHOWN TO SCALE
- EXISTING DUCT TO REMAIN
- **DUCT TRANSITION**
- DUCT TAKE-OFF WITH VOLUME DAMPER
- DIFFUSER OR REGISTER TYPE/CFM
- FIRE DAMPER, STYLE B

CONNECTION TO EXISTING

- DUCT SMOKE DETECTOR WITH AUDIBLE & VISUAL ALARMS
- (7) REPLACE EXISTING EXHAUST GRILLES AS SHOWN, PROVIDE DUCT TRANSITIONS AS REQUIRED TO CONNECT TO EXISTING DUCTWORK ABOVE CEILING.

(1) EXISTING WATER SOURCE HEAT PUMP. SEE CORRIDOR

(2) EXISTING SUPPLY AIR DUCT ABOVE CEILING TO REMAIN.

(3) FIRE DAMPER PROVIDED UNDER SEPARATE PERMIT FOR

(5) EXISTING EXHAUST AIR DUCT RISER UP TO EXHAUST FAN

(6) EXISTING EXHAUST AIR DUCT ABOVE CEILING TO REMAIN.

(4) EXTEND S/A DUCT INSIDE BATHROOM AS SHOWN.

IMPROVEMENT PLANS FOR ALL RELATED WORK OUTSIDE OF

THE BATHROOMS, PROVIDED UNDER SEPARATE PERMIT.

DRAWING KEYNOTES:

CORRIDOR IMPROVEMENTS.

ON THE ROOF, TO REMAIN AS IS.

(8) PROVIDE NEW TRANSFER AIR DUCT SYSTEM FOR TOILET MAKE-UP AIR AS SHOWN.

HVAC PROJECT SPECIFIC NOTES

CONTRACTOR IS TO INSPECT ALL EXISTING DUCTWORK SHOWN ON THESE PLANS AS REMAINING. REPAIR AS REQUIRED ANY DAMAGED DUCTWORK OR INSULATION. WHERE DUCTWORK IS SHOWN TO BE PARTIALLY REMOVED, CAP, SEAL, AND INSULATE TO MATCH EXISTING METHODS AND MATERIALS.

EXISTING EQUIPMENT WHICH IS REMAINING IS TO BE INSPECTED, ADJUSTED AND REPAIRED WHERE NECESSARY.

AIR DISTRIBUTION SCHEDULE MOUNTING SIZE NECK DAMPER THROW **FINISH** MODEL MATERIAL TYPE TYPE AG-100 WHITE TDC-AA 9X9 6**"**ø ALUMINUM LAY-IN 4 WAY SURFACE WHITE 10X10 ALUMINUM AG-15

PROVIDE INTEGRAL VOLUME DAMPERS WHERE SHOWN ON PLAN OR WHERE DAMPER IN DUCTWORK IS NOT ACCESSIBLE ABOVE CEILING. PROVIDE SQUARE TO ROUND ADAPTERS WHERE REQUIRED FOR ROUND DUCT CONNECTION.

PROVIDE SAMPLE WITH OFF-WHITE FINISH TO ARCHITECT FOR APPROVAL. PROVIDE FLEXIBLE DUCT SIZED TO MATCH S/A DIFFUSER NECK UNLESS NOTED OTHERWISE.

FIELD VERIFY EXACT SIZE OF EXISTING SLOT DIFFUSERS PRIOR TO ORDERING NEW.

THESE DRAWNGS ARE DIAGRAMMATIC. ALL OFFSETS, FITTINGS, TRANSITIONS AND ACCESSORIES ARE NOT SHOWN. THE CONTRACTOR SHALL INCLUDE IN HIS BID ALL ITEMS REQUIRED TO PROVIDE A COMPLETE AND OPERATIONAL SYSTEM. DO NOT SCALE DRAWINGS FOR INSTALLATION.


- ALL WORK SHALL BE PERFORMED IN A FIRST CLASS WORKMANLIKE MANNER BY LICENSED CONTRACTORS.
- THE CONTRACTOR SHALL OBTAIN AT HIS EXPENSE ALL NECESSARY FEES PERMITS, AND TESTS.
- ALL WORK SHALL CONFORM TO ALL APPLICABLE LOCAL, STATE AND NATIONAL CODES. NO CONTRACTOR SHALL BID UNLESS FAMILIAR WITH THESE CODES.

MECHANICAL GENERAL NOTES:


- CORRECTION OF DEFECTS TO THIS WORK SHALL BE MADE PROMPTLY WITHOUT CHARGE TO THE OWNER. REPAIR AND REPLACEMENT FOR DAMAGE CAUSED BY THIS CONTRACTOR SHALL BE MADE PROMPTLY WITHOUT CHARGE TO THE OWNER.
- ALL WORK OF THIS TRADE SHALL BE COORDINATED WITH ALL OTHER TRADES TO AVOID ANY INTERFERENCES THAT MAY DELAY PROGRESS OF CONSTRUCTION.
- THE CONTRACTOR SHALL INCLUDE THE WORK OF ALL REQUIRED SUB-CONTRACTORS, SUCH AS ELECTRICAL, INSULATING, TEST & BALANCE, ETC., AS REQUIRED FOR A COMPLETE AND OPERATIONAL SYSTEM.
- EQUIPMENT SHALL BEAR A U.L. OR OTHER RECOGNIZED LABEL, NAMEPLATES, WIRING DIAGRAMS, AND ENERGY RATINGS AS APPLICABLE.
- THE CONTRACTOR SHALL INSTALL ALL EQUIPMENT AND ACCESSORIES TO BE READLY ACCESSIBLE FOR SERVICING, TESTING, BALANCING, AND REPLACEMENT.
- 10. THE CONTRACTOR SHALL PROVIDE A WRITTEN GUARANTEE AGAINST DEFECTS IN ALL MATERIALS AND WORKMANSHIP FOR ONE YEAR FROM ACCEPTANCE, WITH FOUR ADDITIONAL YEARS OF WARRANTY ON COMPRESSORS.
- 11. THE CONTRACTOR SHALL PROVIDE THREE COPIES OF SUBMITTAL DATA, SHOP DRAWINGS, AND AT COMPLETION OF THE PROJECT TWO SETS OF OPERATION AND MAINTENANCE MANUALS FOR ALL PROJECT ITEMS.
- 12. PROVIDE ALL CONTROLS, STARTERS, CONTROL WIRING, DISCONNECTS, AND OTHER ELECTRICAL EQUIPMENT AS REQUIRED FOR A COMPLETE AND OPERATIONAL SYSTEM.
- 13. THE HVAC CONTRACTOR IS RESPONSIBLE FOR MAINTAINING, ON SITE, A DETAILED AS-BUILT PLAN SHOWING ACTUAL INSTALLATIONS. THE CONTRACTOR IS TO PROVIDE A NEATLY DRAWN COMPREHENSIVE AS-BUILT SET OF PLANS UPON COMPLETION, WHICH ARE SUITABLE FOR SUBMISSION TO THE BUILDING DEPARTMENT AND TO THE OWNER.
- 14. PRIOR TO ACCEPTANCE BY THE OWNER THE SYSTEMS SHALL BE TESTED AND BALANCED BY AN INDEPENDENT NEBB CERTIFIED T&B CONTRACTOR EXPERIENCED WITH THIS SYSTEM, AND CERTIFIED T&B REPORTS SUBMITTED.
- 15. SUPPLY AND INSTALL DUCT MOUNTED SMOKE DETECTORS AS REQUIRED.
- 16. COORDINATE LOCATION OF CEILING DIFFUSERS, GRILLES AND REGISTERS IN THE FIELD WITH LIGHTS AND ARCHITECTURAL ELEMENTS.
- 17. ALL GRILLES TO BE TITUS OR METALLAIRE UNLESS OTHERWISE NOTED, SIZES AS SHOWN ON PLANS, ALUMINUM CONSTRUCTION.
- 18. ALL DUCT WORK SHALL BE BUILT AND INSTALLED IN ACCORDANCE WITH SMACNA STANDARDS AND LOCAL BUILDING CODES.
- 19. ALL DUCT SIZES ARE CLEAR INSIDE DIMENSIONS.
- 20. ALL OUTSIDE AIR DUCTWORK SHALL BE SHEETMETAL WITH EXTERIOR R-6 INSULATION. PROVIDE BLANKET TYPE INSULATION IN CONCEALED SPACES, AND BOARD TYPE IN EXPOSED AREAS.
- 21. ALL EXHAUST AIR DUCT SHALL BE GALVANIZED SHEET METAL CONSTRUCTED AND INSTALLED IN ACCORDANCE WITH ASHRAE AND SMACNA STANDARDS.
- 22. FLEXIBLE DUCT, WHERE SHOWN, SHALL BE U.L. CLASS 1, R-6 INSULATION. 23. LOW PRESSURE SUPPLY AND RETURN DUCTWORK IS RIGID DUCTBOARD WITH

VAPOR BARRIER, 1 IN. THICK, R-4.2 INSULATION, EXCEPT AS NOTED.


- 24. PROVIDE ELBOW TURNING VANES IN ALL RECTANGULAR DUCTS WHERE TURNS ARE GREATER THAN 45 DEGREES.
- 25. PROVIDE BACKDRAFT DAMPERS FOR ALL EXHAUST FANS.
- 26. VERIFY ALL THERMOSTAT LOCATIONS WITH THE ARCHITECT.
- 27. CONDENSATE DRAIN PIPING IS COPPER WITH SOLDERED FITTINGS AND ARMAFLEX INSULATION.

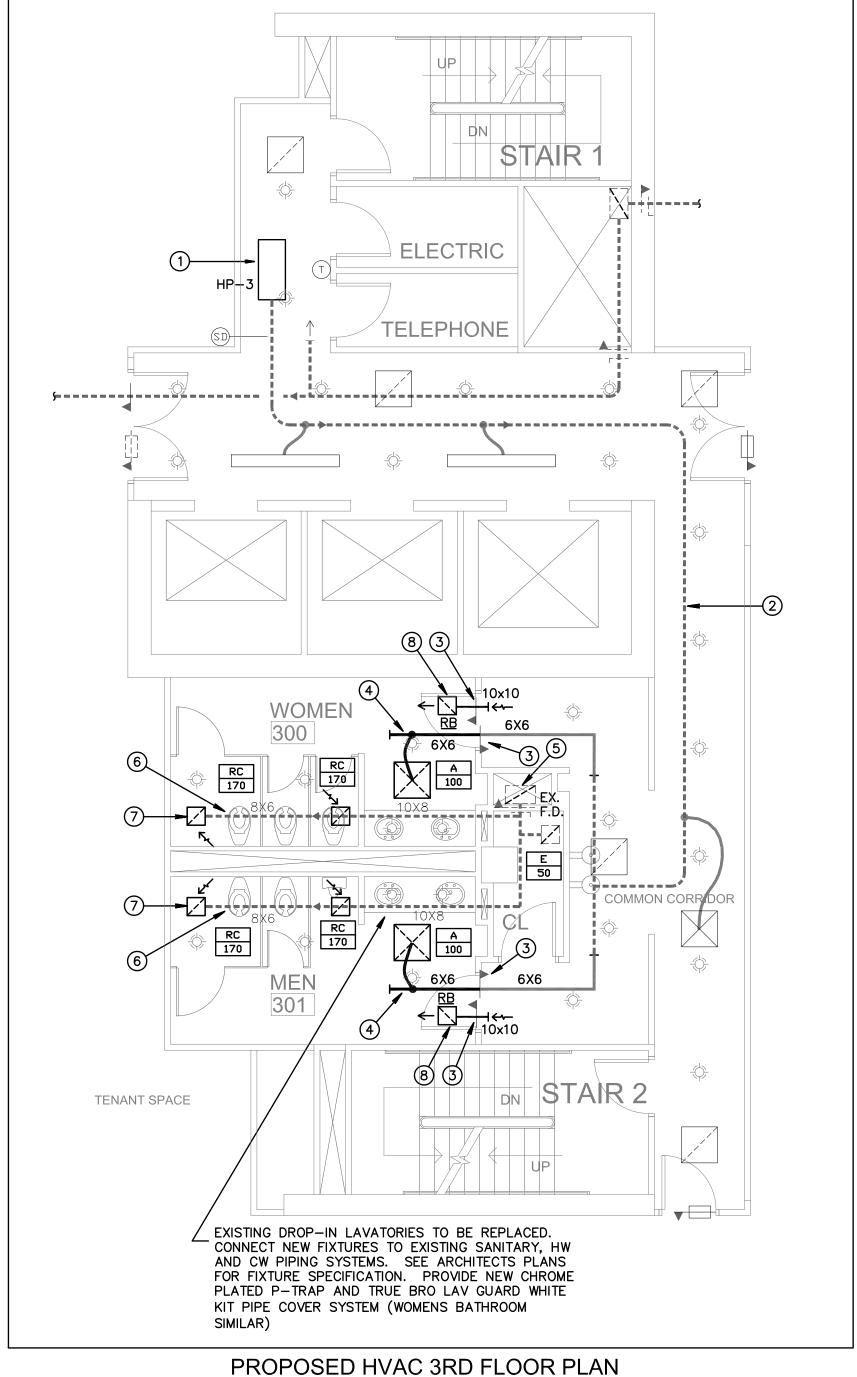

SCALE: 3/16" = 1'-0"

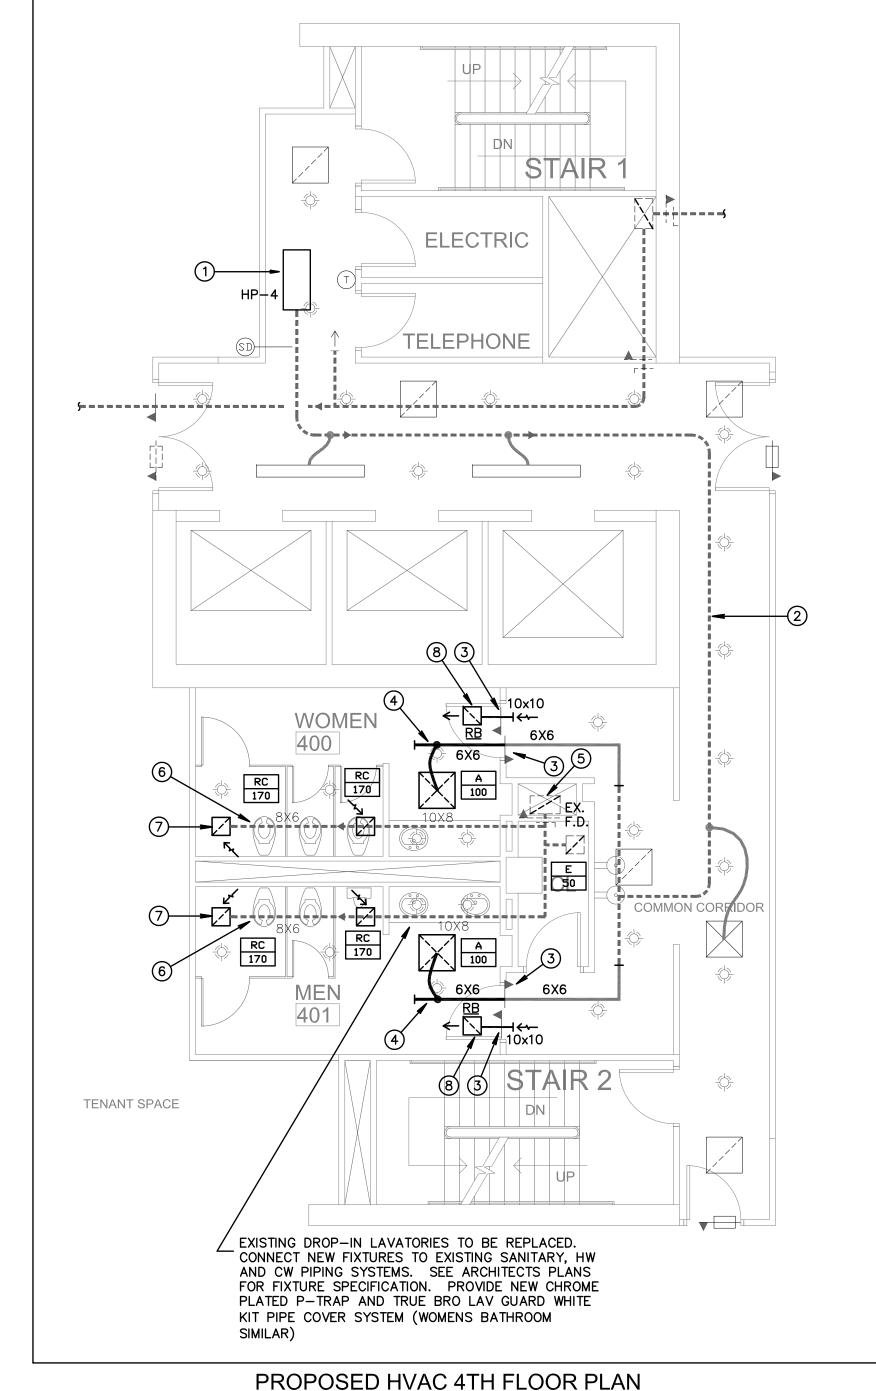

SCALE: 3/16" = 1'-0"

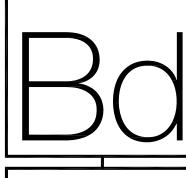

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REVISIONS

DRAWN BY GD

ELECTRICAL NOTES

- DO NOT SCALE THE ELECTRICAL DRAWINGS. REFER TO ARCHITECTURAL PLANS AND ELEVATIONS FOR EXACT LOCATION OF ALL EQUIPMENT. CONFIRM WITH OWNERS REPRESENTATIVE.
- ALL WORK SHALL BE DONE IN ACCORDANCE WITH NATIONAL ELECTRICAL CDDE NFPA-70 (2005), THE LIFE SAFETY CDDE NFPA-101 (2003),

BUILDING CODE (FBC 2004, WITH 2007 SUPPLEMENTS).

THE NATIONAL FIRE ALARM CODE NFPA-72 (2002), AND THE FLORIDA

- MINIMUM WIRE SIZE SHALL BE #12 A.W.G., EXCLUDING CONTROL WIRING. UNLESS OTHERWISE NOTED ALL CONDUCTORS SHALL BE COPPER WITH THWN
- 4. DUTLET BOXES SHALL BE SHEET STEEL IN DRY LOCATIONS, CAST ALLOY WITH THREADED HUBS IN WET OR DAMP LOCATIONS AND SPECIAL ENCLOSURES AS REQUIRED FOR OTHER CLASSIFIED AREAS.
- 5. DISCONNECT SWITCHES SHALL BE H.P. RATED , HEAVY DUTY, QUICK-MAKE, QUICK-BREAK ENCLOSURES AS REQUIRED BY EXPOSURE.
- 6. MOTOR STARTERS SHALL BE MANUAL OR MAGNETIC , WITH OVERLOAD RELAYS
- 7. IT IS NOT THE INTENT OF THESE PLANS TO SHOW EVERY MINOR DETAIL OF CONSTRUCTION. THE CONTRACTOR IS EXPECTED TO FURNISH AND INSTALL ALL ITEMS FOR A COMPLETE ELECTRICAL SYSTEM AND PROVIDE ALL RE-QUIREMENTS NECCESSARY FOR EQUIPMENT TO BE PLACED IN PROPER WORKING ORDER.
- 8. ELECTRICAL SYSTEM SHALL BE COMPLETE AND EFFECTIVELY GROUNDED AS REQUIRED BY THE LATEST EDITION OF THE N.E.C.
- 9. ALL MATERIALS SHALL BE NEW AND BEAR UNDERWRITERS' LABELS WHERE APPLICABLE.
- 10. ALL WORK SHALL BE PERFORMED BY A LICENSED ELECTRICAL CONTRACTOR IN A FIRST CLASS WORKMANLIKE MANNER. THE COMPLETED SYSTEM SHALL BE FULLY OPERATIVE, AND ACCEPTED BY ENGINEER/ARCHITECT.
- ALL WORK SHALL BE COORDINATED WITH OTHER TRADES TO AVOID INTERFERENCE WITH THE PROGESS OF CONSTRUCTION.

- 12. CONTRACTOR SHALL GUARANTEE ALL MATERIALS AND WORKMANSHIP FREE FROM DEFECTS FOR A PERIOD OF NOT LESS THAN ONE YEAR FROM DATE OF ACCEPTANCE.
- 13. CORRECTION OF ANY DEFECTS SHALL BE COMPLETED WITHOUT ADDITIONAL CHARGE AND SHALL INCLUDE REPLACEMENT OR REPAIR OF ANY OTHER PHASE OF THE INSTALLATION WHICH MAY HAVE BEEN DAMAGED THEREBY.
- 14. ALL REQUIRED INSURANCE SHALL BE PROVIDED FOR PROTECTION AGAINST

PUBLIC LIABILTY AND PROPERTY DAMAGE FOR THE DURATION OF THE WORK.

- 15. CONTRACTOR SHALL PAY FOR ALL PERMITS , FEES , INSPECTIONS , AND TESTING.
- 16. THE ELECTRICAL INSTALLATION SHALL MEET ALL STANDARD REQUIREMENTS OF POWER AND TELEPHONE COMPANIES.
- 17. FURNISH AND INSTALL DISCONNECT SWITCHES AND WIRING FOR AIR CONDITIONING SYSTEM AS PER MANUFACTURERS RECOMMENDATIONS, CONTROLS ARE TO BE SUPPLIED BY AIR CONDITIONING CONTRACTOR AND CONNECTED BY ELECTRICAL CONTRACTOR.
- 18. ALL RACEWAYS UNDERGROUND SHALL BE A MINIMUM OF 3/4"CONDUIT.

WHERE STANDARDS HAVE BEEN ESTABLISHED BY UL.

- 19. ALL CIRCUIT BREAKERS , TWO AND THREE POLE , TO BE COMMON TRIP. NO TIE HANDLES , OR TANDEMS WILL BE ACCEPTED.
- 20. ALL FUSES , UNLESS NOTED ON DRAWING , SHALL BE CURRENT LIMITING
- (C.L.) RATED FOR 200,000 A.I.C. 21. ALL ELECTRICAL EQUIPMENT, DEVICES, WIRE, ETC., SHALL BE LISTED, FOR THE INTENDED USE, WITH UNDERWRITER'S LABORATORIES, INC. (UL),
- THE CONTRACTOR IS RESPONSIBLE TO MAINTAIN, ON SITE, A DETAILED AS-BUILT PLAN SHOWING ACTUAL INSTALLATIONS. THE CONTRACTOR IS TO PROVIDE A NEATLY DRAWN COMPREHENSIVE AS-BUILT SET OF PLANS UPON COMPLETION, WHICH ARE SUITABLE FOR SUBMISSION TO THE BUILDING DEPARTMENT AND THE OWNER.

LIGHTING FIXTURE SCHEDULE								
SYMBOL	TYPE	MOUNT	LAMP	VOLT	MANUFACTURER	CATALOG	REMARKS	
A	FLUORESCENT DOWNLIGHT	RECESSED	(1)26WTT 35K	277	PRESCOLITE	CFT632HEB-STF602H	2	
•	EXIT LIGHT	SURFACE	BY MFGR.	277	DUAL LITE	LXURW	1	

- (1) PROVIDE SINGLE OR DUAL FACE, WALL OR CEILING MOUNT, AS SHOWN ON PLANS. CONNECT FIXTURES TO UNSWITCHED HOT LEG OF CIRCUIT.
- (2) PROVIDE MANUFACTURERS LABEL FOR MAXIMUM OF 26 WATT LAMP. TOTAL FIXTURE INPUT POWER TO BE 28 WATTS MAXIMUM.

KEYNOTES

- ① CONNECT DESIGNATED EMERGENCY LIGHTING FIXTURES TO EXISTING EMERGENCY POWER LIGHTING CIRCUIT SERVING THIS AREA. SEE PLANS OF CORRIDOR IMPROVEMENTS PROVIDED UNDER SEPARATE PERMIT FOR WORK OUTSIDE OF THE REST ROOMS.
- (2) CONNECT NORMAL POWER LIGHTING FIXTURES TO EXISTING NORMAL POWER LIGHTING CIRCUIT SERVING THIS AREA.
- 3 EXISTING FIRE ALARM STROBE @ 72" A.F.F. TO BE REMOVED AND REPLACED WITH NEW 75 CANDELA DEVICES MOUNTED @ 80" A.F.F. FIELD VERIFY THE EXACT QUANTITY OF DEVICES REQUIRED. (THERE ARE SOME COMPLIANT DEVICES EXISTING, MATCH THESE
- REPLACE EXISTING DEVICES IN THE AREA OF WORK WITH NEW DEVICES AND FACEPLATES, VERIFY COLOR WITH ARCHITECT.

DEVICES). TYPICAL FOR ALL STROBES SHOWN.

(5) PROVIDE RELAYS, POWER PACKS AND ANY OTHER EQUIPMENT AS REQUIRED TO CONNECT OCCUPANCY SENSOR FOR CONTROL OF MULTIPLE LIGHTING CIRCUITS AS INDICATED.

LIGHTING POWER COMPLIANCE

(PER TABLE 13-415.2.B, FBC CHAPTER 13)									
SPACE TYPE TOTAL AREA ALLOWANCE SUB-TOTAL DESIGN (SQ.FT.) PER SQ.FT. ALLOWANCE									
RESTROOMS	714	0.9	643	560					
TOTALS		643	560						

- LIGHTING FIXTURE IDENTIFICATION
- RECTANGULAR LIGHTING FIXTURE AS NOTED

ELECTRICAL LEGEND

- RECTANGULAR LIGHTING FIXTURE EXISTING AS NOTED
- \circ ROUND LIGHTING FIXTURE

IN EACH HOT LEG.

- OH WALL MOUNTED LIGHTING FIXTURE
- EXIT LIGHT ON EMERGENCY POWER CIRCUIT
- RECTANGULAR LIGHTING FIXTURE ON EMERGENCY POWER CIRCUIT.
- ROUND LIGHTING FIXTURE ON EMERGENCY POWER CIRCUIT DUPLEX RECEPT - 20 AMP (18" A.F.F.)
- DUPLEX RECEPT MOUNTED ABOVE COUNTER 20 AMP (42" A.F.F.)
- SINGLE POLE TOGGLE SWITCH, 48" AFF
- JU JUNCTION BOXES
- ELECTRICAL PANELBOARD
- CIRCUIT HOME RUN TO PANELBOARD OR OTHER DEVICE AS INDICATED
- CONDUIT CONCEALED
- EXISTING DUPLEX RECEPTACLE TO REMAIN.
- ▼ TELEPHONE/DATA OUTLET EXISTING TO REMAIN
- EXISTING DEVICE TO REMAIN AS IS
- EXISTING DEVICE TO BE RELOCATED AS SHOWN.
- NEW DEVICE IN EXISTING DUTLET BOX (REPLACE EXISTING DEVICE)
- EXISTING SINGLE POLE TOGGLE SWITCH TO REMAIN.
- / CONCEALED CIRCUIT AS NOTED
- DCCUPANCY SENSOR, CEILING MOUNT, HUBBELL OMNI DT-2000
- LIGHTING CONTACTOR
- AFF ABOVE FINISHED FLOOR

GENERAL DEMOLITION NOTES

- UNLESS OTHERWISE NOTED, ALL EQUIPMENT, WIRING DEVICES, LIGHT FIXTURES, CONDUIT AND WIRE IN THE PROJECT AREA WHICH IS NOT INDICATED TO REMAIN, IS TO BE REMOVED. THE CONTRACTOR SHALL INVESTIGATE THE PROJECT AREA PRIOR TO BID TO DETERMINE ALL REQUIRED DEMOLITION.
- 2. EXISTING CONDITIONS SHOWN ON THIS DRAWING ARE TAKEN FROM ORIGINAL DRAWINGS AND FIELD INVESTIGATION. ALL EXISTING CONDITIONS MUST BE VERIFIED PRIOR TO BID. FIELD CONDITIONS SHALL GOVERN.
- DEMOLITION WORK IS NOT SPECIFICALLY IDENTIFIED ON THESE PLANS, AND MAY BE DESCRIBED ON THE ARCHITECTS PLANS. THE CONTRACTOR IS RESPONSIBLE FOR ALL REQUIRED DEMOLITION WHETHER SHOWN ON THE PLANS OR NOT.
- 4. ALL CONDUITS SERVING OTHER SPACES OR FLOORS, THAT RUN THROUGH THE PROJECT AREA SHALL REMAIN ACTIVE DURING CONSTRUCTION, SO AS NOT TO CAUSE ANY DISRUPTION TO THESE OTHER SPACES.
- 5. ALL ITEMS REMOVED UNDER THIS PROJECT SHALL BE DISPOSED OF OR TURNED OVER TO THE OWNER AT THE OWNER'S DISCRETION.
- 5. PROPERLY REMOVE AND DISPOSE OF ALL ELECTRICAL EQUIPMENT, CONDUIT AND WIRING WHICH IS TO BE REMOVED. CONSULT WITH OWNER AND OBTAIN THE OWNERS APPROVAL PRIOR TO DISPOSAL OF REMOVED MATERIAL.
- 7. IT IS THE CONTRACTOR'S RESPONSIBLITY TO ENSURE THAT ALL CONDUITS, NEW OR EXISTING, WITHIN THE PROJECT AREA, ARE PROPERLY SUPPORTED AND PROVIDED WITH BONDING BUSHINGS IN ACCORDANCE WITH THE NATIONAL ELECTRIC CODE.

- FIRE ALARM LEGEND
- F MANUAL PULL STATION
- WALL MOUNT SPEAKER/STROBE
- PHOTOELECTRIC SMOKE DETECTOR
- ADA COMPLIANT STROBE LIGHT
- MONITOR MODULE
- DUCT SMOKE DETECTOR W/O RELAY
- R CONTROL MODULE OUTPUT RELAY
- HD HEAT DETECTOR
- (S) CEILING SPEAKER
- ◀ FIREMAN'S TELEPHONE OUTLET


AUDIBLE ALARMS SHALL HAVE A MINIMUM LEVEL OF 15 DBA IN EXCESS OF THE AMBIENT SOUND LEVEL OF THE ROOM, AND SHALL OTHERWISE BE IN ACCORDANCE WITH FBC 11-4.28.2.

VISUAL ALARMS SHALL HAVE A MINIMUM LEVEL OF 75 CANDELA AND SHALL OTHERWISE BE IN ACCORDANCE WITH FBC 11-4.28.3.

PROVIDE A RE-CERTIFICATION OF THE FIRE ALARM SYSTEM UPON COMPLETION OF WORK.


NEW FIRE ALARM DEVICES ARE TO BE COMPATIBLE WITH EXISTING SYSTEM. PROVIDE ADDITIONAL POWER SUPPLIES AS REQUIRED. PROVIDE ADDITIONAL HORNS AND STROBES AS REQUIRED TO MEET AUDIBLE AND VISIBLE REQUIREMENTS OF NFPA 72, ADA, AND NFPA 101. VERIFY EXISTING POINT OF CONNECTION TO EXISTING SYSTEM. EXISTING DEVICES MAY BE RE-USED AT THE DISCRETION OF THE LANDLORD, VERIFY ALL SUCH EQUIPMENT PRIOR TO BID.

THE CONTRACTOR IS RESPONSIBLE FOR ENSURING THAT ALL NEW AND EXISTING ELECTRICAL SYSTEMS, FIXTURES, DEVICES, AND OTHER EQUIPMENT RELATED TO THE AREA OF WORK ARE IN GOOD WORKING ORDER. REPAIR AS NEEDED.

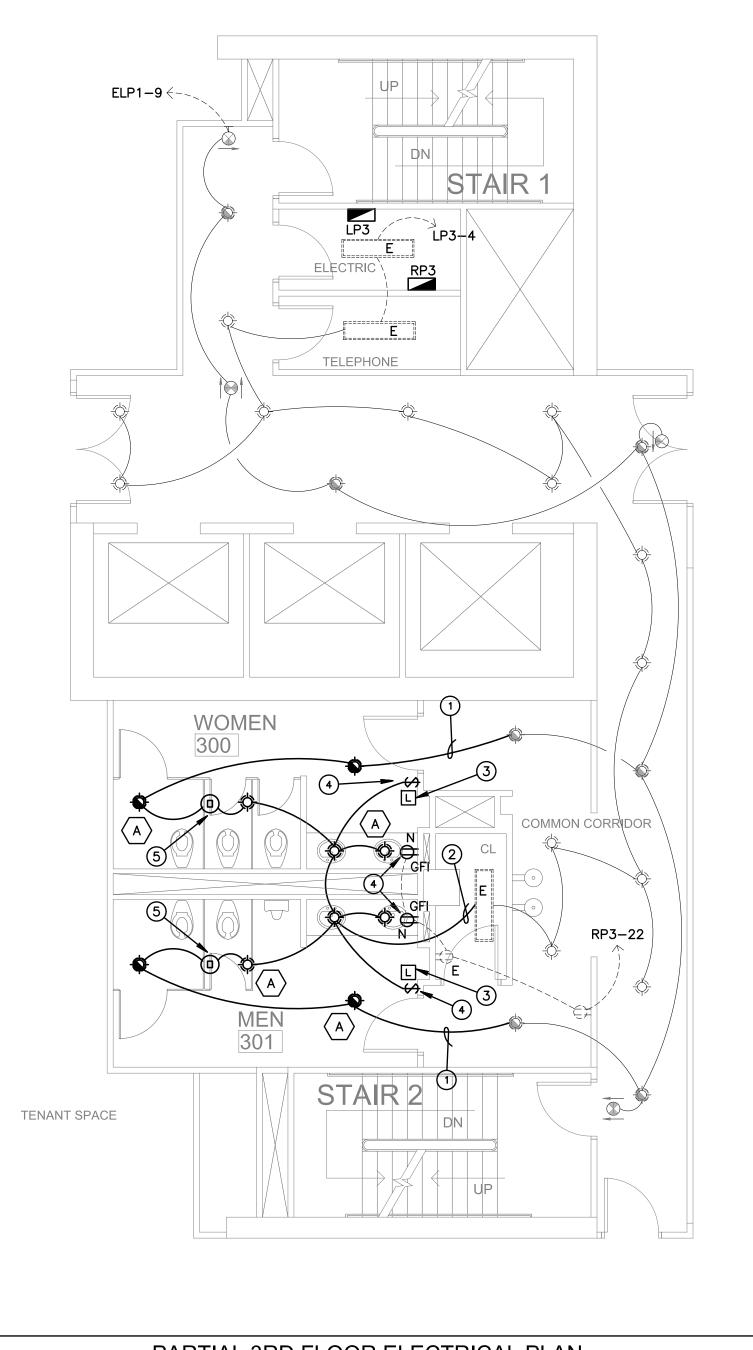

PARTIAL 3RD FLOOR ELECTRICAL PLAN


SCALE: 3/16" = 1'-0"

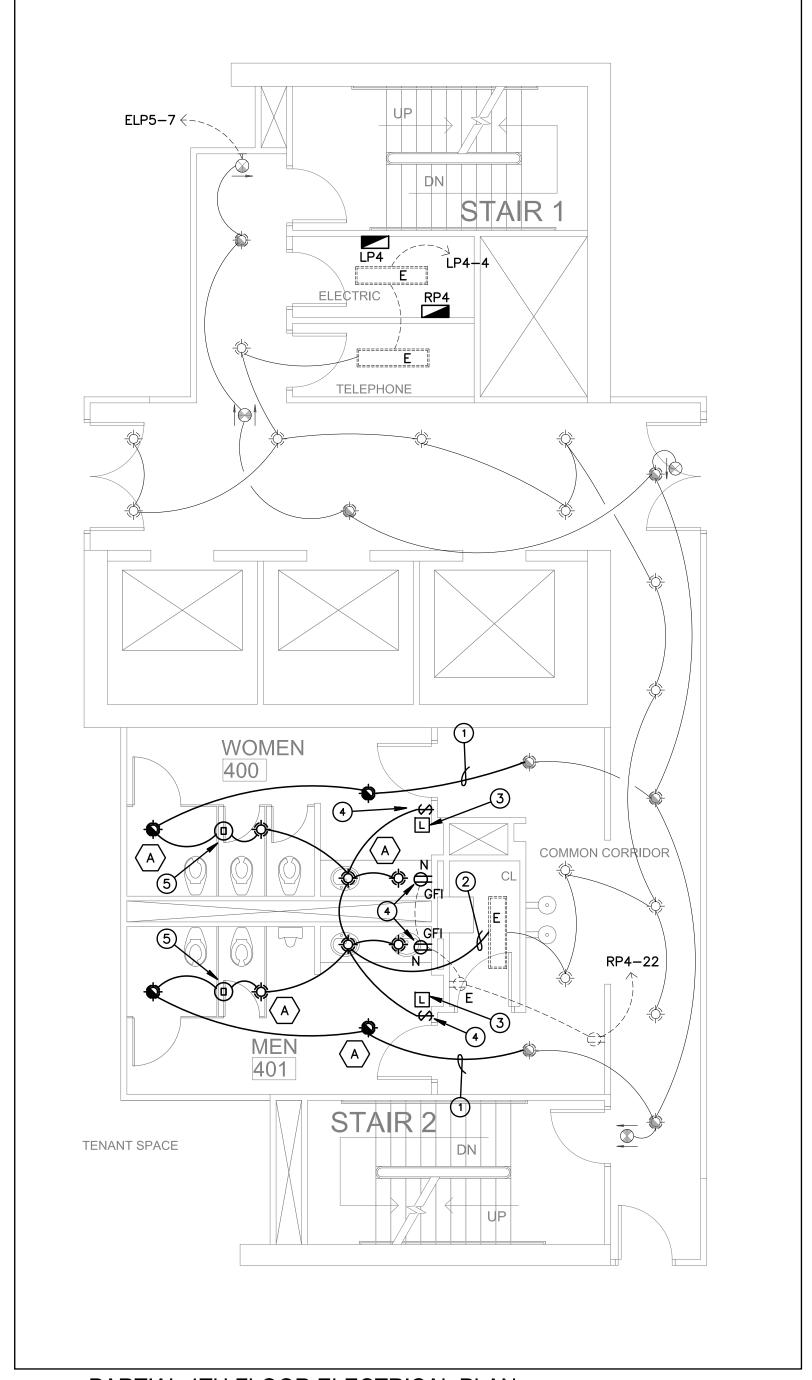

PARTIAL 4TH FLOOR ELECTRICAL PLAN

SCALE: 3/16" = 1'-0"



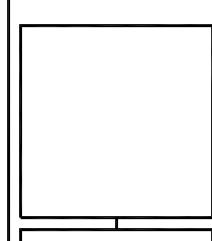

GRAD

TROOM

REVISIONS HIS DESIGN AND THESE DRAWINGS ARE THE PROPE F BIRSE DESIGN INC. NO PART OF THIS WORK MAY B

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ROM BIRSE DESIGN INC.

PROJ.# 11-018