birse design inc + architecture + interior design + planning


5300 woodland lakes drive palm beach gardens, fl 33418

phone 561-249-4001 fax 772-409-8684 AA26001615

MECHANICAL ENGINEER / ELECTRICAL / PLUMBING



129 N. FEDERAL HWY. SUITE 211 LAKE WORTH, FL 33460 (561) 582-0210 P.E. 37933

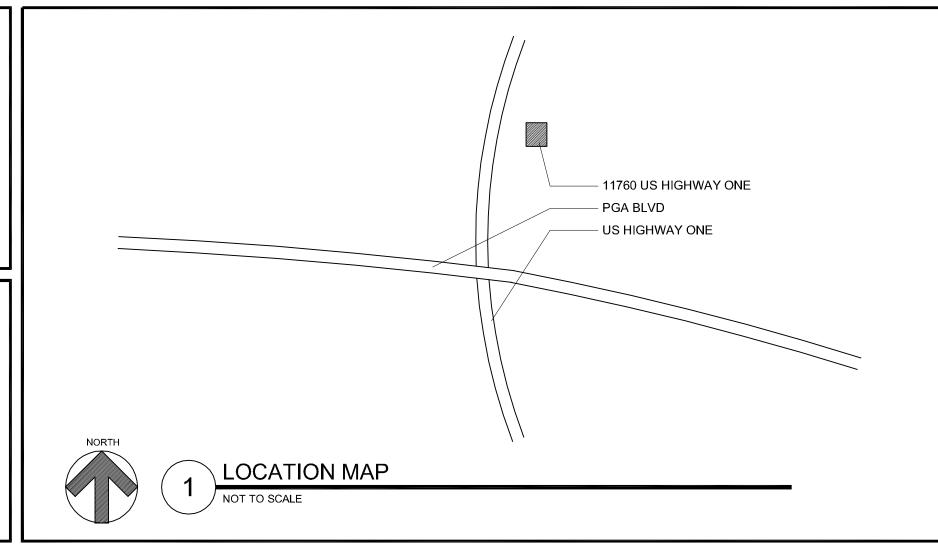

INDEX OF SHEETS:


TITLE SHEET

ARCHITECTURAL SHEETS

FLOOR PLANS DETAILS

MECHANICAL/ELECTRICAL/PLUMBING SHEETS

MECHANICAL PLUMBING ELECTRICAL PLAN

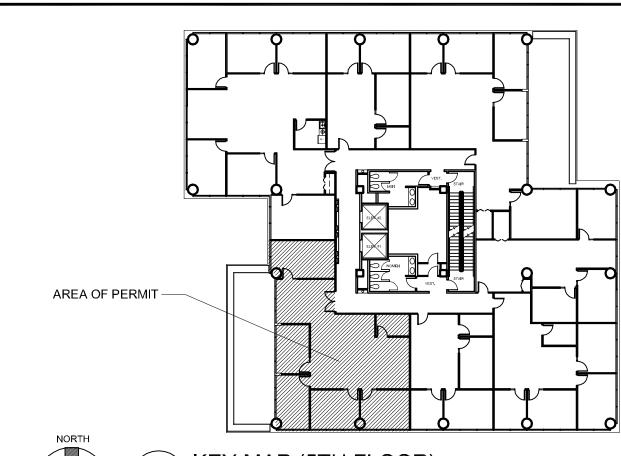

* AREA FOR THIS PERMIT IS HATCHED * AREA FOR THIS PERMIT = 1,824 SF

KEY MAP (5TH FLOOR)

SYMBOL INDEX:

- ROOM NAME

- DOOR MARK/NUMBER

WINDOW MARK/NUMBER

- WALL SECTION/SHEET NUMBER

- ROOM NUMBER

BUILDING SECTION/SHEET NUMBER

- ELEVATION TARGET/SHEET NUMBER

DETAIL NUMBER/SHEET NUMBER

CEILING HEIGHT

- 2'x4' FLUORESCENT LIGHT FIXTURE

- FIRE EXTINGUISHER

RECESSED LIGHT DOWN FIXTURE

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WALL MOUNTED LIGHT FIXTURE

PROJECT DATA:

* PROJECT ADDRESS: GOLDEN BEAR PLAZA 11760 US HIGHWAY ONE #501W PALM BEACH GARDENS, FL 33408

* EXISTING BUILDING IS TYPE I "A"

* EXISTING BUILDING IS A 6 STORY BUILDING

* EXISTING BUILDING CLASSIFICATION IS GROUP "B"

* LEVEL 2 ALTERATION PER "EXISTING BUILDING CODE 2007"

* 5TH FLOOR IS A MULTI TENANT FLOOR

* SUITES #501W = 1,824 SF

* TOTAL NEW SUITE = 1,824 SF/100 = 18 OCCUPANTS

* DESIGN OCCUPANT LOAD = 18 OCCUPANTS

|--|

INCLUDED IN HIS BID. M. PROVIDE FIRE DEPARTMENT KNOX BOX ADJACENT TO FRONT DOOR OF BLDG. N. CONTRACTOR TO PROVIDE AS BUILT DRAWINGS. PROVIDE TWO COPIES

REFERENCE STANDARDS:

THIS PROJECT IS DESIGNED IN ACCORDANCE WITHE FOLLOWING CODES:

I. THE FLORIDA BUILDING CODE (FBC), 2007 EDITION WITH 2009 SUPPLEMENTS (BUILDING, MECHANICAL, PLUMBING, FUEL GAS,

2. NATIONAL ELECTRIC CODE (NEC), 2008 EDITION.

3. FLORIDA FIRE PREVENTION CODE, 2007 EDITION.

4. NATIONAL FIRE PROTECTION ASSOCIATION (NFPA) 101, LIFE SAFETY CODE, 2006 EDITION.

5. NATIONAL FIRE PROTECTION ASSOCIATION (NFPA) 1, UNIFORM FIRE CODE, 2006 EDITION.

GENERAL NOTES:

THE CONTRACTOR SHALL AS A PART OF THIS CONTRACT FURNISH ALL MATERIALS, LABOR, TOOLS, EQUIPMENT, TRANSPORTATION, AND INSURANCE NECESSARY TO PROPERLY EXECUTE AND COMPLETE THE WORK ACCORDING TO THE PLANS AND SPECIFICATIONS.

THE CONTRACTOR IN THE WORK OF ALL TRADES SHALL PROTECT ALL EXISTING BUILDING AND PROPERTY FROM DAMAGE CAUSED BY THE ACTIVITIES OF THE CONTRACTOR AND SUBCONTRACTORS. THE CONTRACTOR SHALL REPAIR AND RESTORE THE JOB SITE AND SURROUNDING AREAS TO IT'S ORIGINAL CONDITION. OWNER TO VERIFY SATISFACTION.

. THE CONTRACTOR SHALL VISIT THE JOB SITE TO VERIFY ALL EXISTING CONDITIONS PRIOR TO BID. CONTRACTOR TO NOTIFY ARCHITECT OF

ANY DISCREPANCIES, INCONSISTENCIES OR OMISSIONS BEFORE PROCEEDING WITH ANY WORK. f 4. THE CONTRACTOR SHALL MAKE NO CHANGES TO THE CONSTRUCTION DRAWINGS WITHOUT $\,$ WRITTEN APPROVAL FROM THE ARCHITECT.

5. ALL CONSTRUCTION SHALL CONFORM WITH THE LATEST CODES AND ORDINANCES.

THESE CONSTRUCTION DOCUMENTS ARE DIAGRAMATIC AND ARE TO CONVEY DESIGN INTENT. IT IS NOT THE INTENT OF THESE CONSTRUCTION DRAWINGS TO SHOW ALL DETAILS OF THE EXISTING CONDITIONS. THE CONTRACTOR SHALL VISIT THE SITE TI VERIFY DIMENSIONS PRIOR

7. EACH CONTRACTOR SHALL ESTABLISH AND VERIFY ALL OPENINGS AND INSERTS FOR MECHANICAL, ELECTRICAL, AND PLUMBING WITH THE APPROPRIATE TRADES.

8. ALL INDICATED UTILITY AND STUB-IN LOCATIONS ARE FOR REFERENCE ONLY. THE EXACT LOCATIONS SHALL BE VERIFIED ON THE JOB SITE.

9. THE CONTRACTOR SHALL BE RESPONSIBLE FOR COORDINATING WITH ENGINEERING AND THE ARCHITECTURAL DRAWINGS FOR THE ACTUAL

PLACEMENT OF THE WORK RELATIVE TO FIELD CONDITIONS.

10. THE CONTRACTOR SHALL BE RESPONSIBLE FOR THE OBTAINING INSTALLATION REQUIREMENTS FOR ALL BUILT-IN APPLIANCES, FIXTURES, AND EQUIPMENT. VERIFY EXACT ROUGH-IN DIMENSIONS AND NOTIFY ARCHITECT OF ANY DISCREPANCIES PRIOR TO ROUGH-IN FRAME.

11. THE COST OF ADDITIONAL DESIGN WORK DUE TO ERRORS OR OMMISIONS IN CONSTRUCTION SHALL BE BORNE BY THE RESPECTIVE

10. DETAILS ON THE STRUCTURAL DRAWINGS (IF PROVIDED) ARE TYPICAL. VERIFY ALL DIMENSIONS WITH THE STRUCTURAL DRAWINGS.

12. CONTRACTOR TO BE RESPONSIBLE FOR CHECKING STRUCTURAL CALCULATIONS FOR SPECIFIC REQUIREMENTS OF STRUCTURAL

CONNECTIONS. SUBMIT STEEL TRUSS CALCULATIONS AND SHOP DRAWINGS OF ALL STRUCTURAL STEEL AND MISCELLANEOUS METAL FABRICATION BEFORE COMMENCING FABRICATION. 13. BIRSE DESIGN, INC. SHALL IN NO WAY BE RESPONSIBLE FOR THE CONSTRUCTION MEANS, METHODS, TECHNOLOGIGES, SEQUENCES OR

PROCEDURES, OR FOR SAFETY PRECAUTIONS AND PROGRAMS IN CONNECTION WITH THE WORK. (THESE ARE SOLELY THE CONTRACTORS RESPONSIBILITY UNDER THE CONTRACT FOR CONSTRUCTION.

14. EACH CONTRACTOR SHALL PROVIDE ALL NECESSARY TEMPORARY BRACING, SHORING, GUYING, OR OTHER MEANS TO AVOID EXCESSIVE STRESSES AND TO HOLD STRUCTURAL ELEMENTS ASSOCIATED WITH WORK IN PLACE DURING CONSTRUCTION.

15. PROVIDE PORTABLE FIRE EXTINGUISHERS DURING CONSTRUCTION AS REQUIRED BY LOCAL CODES.

16. SPRINKLER SYSTEM: INSTALL FULL BUILDING SPRINKLER SYSTEM IN COMPLIANCE WITH THE REQUIREMENTS OF NFPA 13. SHOP DRAWINGS MUST BE APPROVED BEFORE INSTALLATIONS. PROVIDE OWNER WITH 2 COPIES OF PERMIT SETS.

. ALL CONTRACTORS AND SUBCONTRACTORS SHALL BE RESPONSIBLE FOR MEETING THE REQUIREMENTS OF ALL CURRENT APPLICABLE BUILDING CODES AND ENFORCEMENT AGENCIES, FIRE MARSHALL, OR ANY OTHER BUILDING CODE ENFORCEMENT OFFICER AT NO EXTRA COST TO THE OWNER. NOTIFY THE ARCHITECT IN WRITING OF ANY DISCREPHANCIES PRIOR TO SUBMITTING A BID FOR THE PROJECT.

18. BASE BID SHALL INCLUDE BUT NOT BE LIMITED TO THE FOLLOWING:

A. ALL PERMITS AND FEES FOR ALL 1. BUILDING AND TRADE PERMITS.

2. ALL ACCESSORY AND SITE IMPROIVEMENT PERMITS.

B. ALL FILL REQUIRED TO MEET MINIMUM FINISHED FLOOR SLAB ELEVATION AND COMPACTION.

C. WATER METER HOOK-UP AND METER DEPOSITS. - OWNER RESPONSIBILITY

D. HOOK-UP AND FEES FOR UNDERGROUND SERVICE FROM FPL

LOCAL PHONE & CABLE T.V. - OWNER RESPONSIBILITY

E. SOIL, CONCRETE AND ANY OTHER NECESSARY TESTING.

F. ENGINEERING STAKE OUTS AND SURVEYS INCLUDING FINAL TIE - IN SURVEY.

G. CLEARING, GRUB, AND SITE PREPARATION, INCLUDING GRADING. H. ALL BIDDERS AND THEIR SUBCONTRACTORS SHALL BE CURRENTLY LICENSED

IN THE STATE OF FLORIDA.

I. THE OWNER RESERVES THE RIGHT TO REJECT ANY BIDS. J. THE G.C. SHALL PROVIDE AN ESTIMATE OF TIME FOR COMPLETION.

K. THE GENERAL CONTRACTOR SHALL PROVIDE PROOF OF INSURANCE FOR

WORKMANS' COMPENSATION AND ANY OTHER INSURANCES REQUIRED BY THE OWNER FOR ALL EMPLOYEES EITHER DIRECTLY EMPLOYED BY THE GENERAL CONTRACTOR OR BY HIS SUBCONTRACTORS.

. THE CONTRACTOR SHALL CLEARLY LIST ANY WORK NOT

OF PERMIT SET TO OWNER


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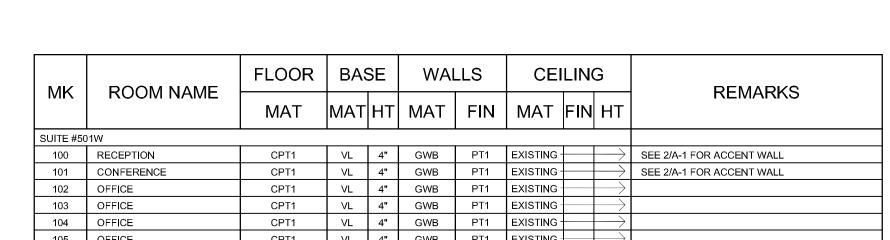
REVISIONS

DRAWN BY ASB

OM BIRSE DESIGNING.

04/22/11



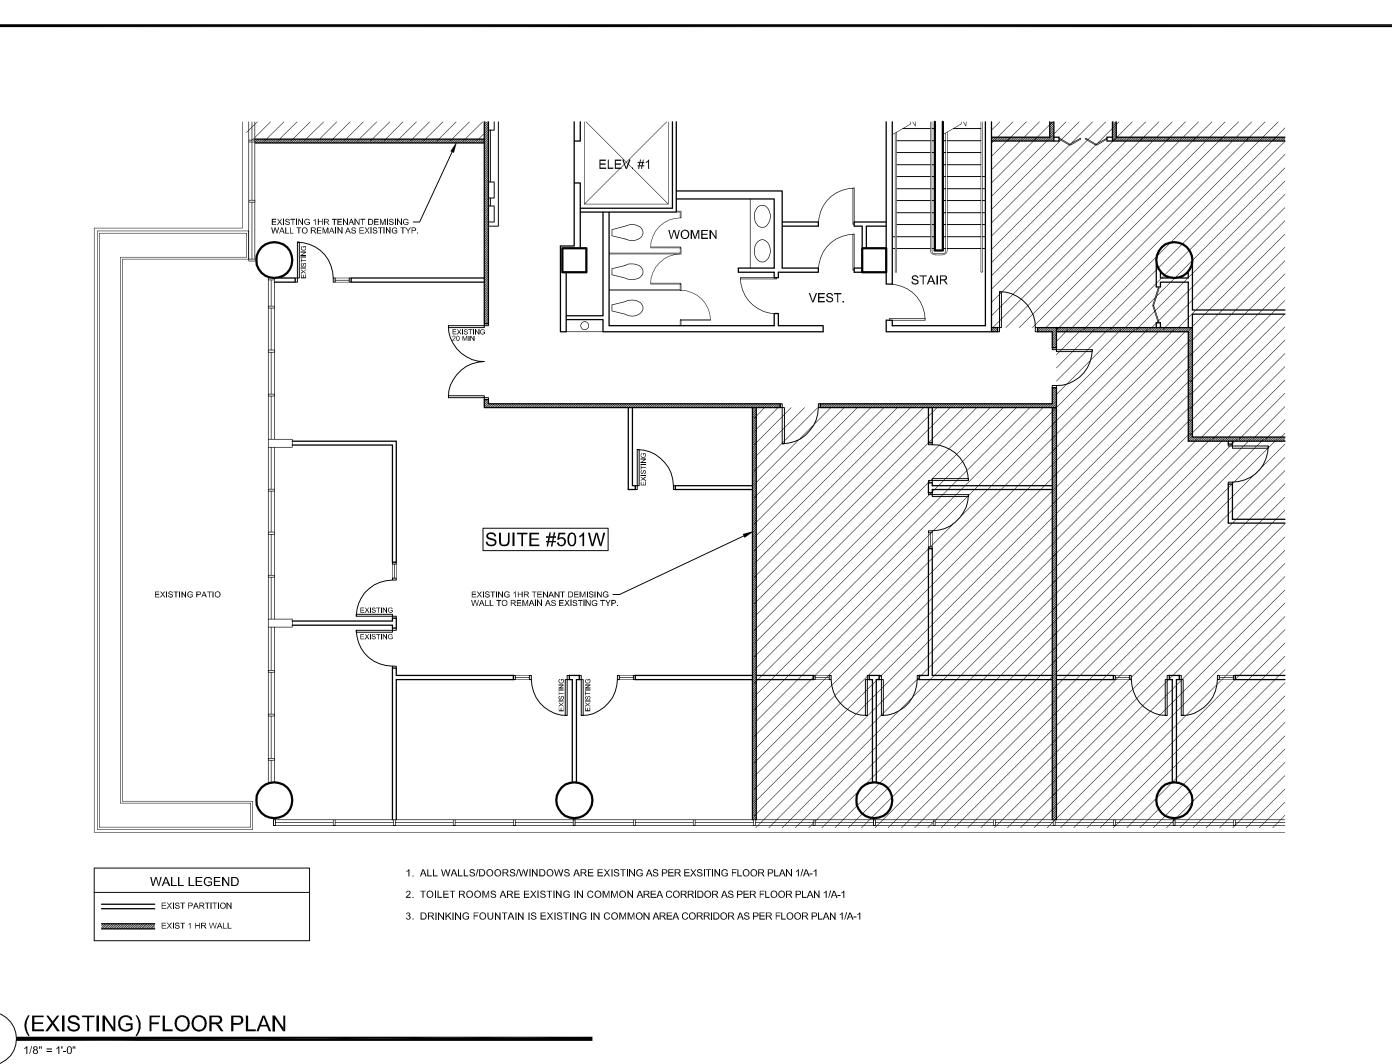

* ALL INTERIOR WALL AND CEILING FINISHES TO HAVE A MIN CLASS "C" FLAME SPREAD CLASSIFICATION

* ALL INTERIOR FLOOR FINISH SHALL BE NOT LESS THAN CLASS II

EXISTING PATIO

WALL LEGEND

NEW METAL STUD PARTITION

(PROPOSED) FLOOR PLAN

EXIST PARTITION TO REMAIN

F.E. INDICATES NEW 10 LB. ABC TYPE FIRE EXTINGUISHER WITH HANGER BRACKET

* SAMPLES ARE REQUIRED TO BE APPROVED PRIOR TO ORDERING/ TENANT TO APPROVE FINISH SCHCEDULE PRIOR TO ORDERING

FINISH SELECTIONS

VINYL BASE (VL)

CARPET (CPT1) (1ST CHOICE) MANUFACTURER: PATCRAFT STYLE: OPPORTUNITY KNOCKS #10162

CARPET (CPT1) (2ND CHOICE)

MANUFACTURER: JOHNSONITE

COLOR: ANIMAL CRACKERS #52523 FIELD PAINT (PT1)

ACCENT PAINT (PT2)

ACOUSTIC CEILING TILE (ACT1) MANUFACTURER: MATCH EXISTING

COLOR: AMATCH EXISTING LAMINATE (COUNTERTOP)

MANUFACTURER: FORMICA COLOR: COLORADO SLATE #7014-77 FINISH: MATTE

LAMINATE (CABS) MANUFACTURER: FORMICA COLOR: PUMICE #858-58 FINISH: MATTE

B 41.7	DOOM NAME	FLOOR	BASE		WALLS		CEILING			DEMARKS
MK	ROOM NAME	MAT	МАТ	нт	MAT	FIN	MAT	FIN	НТ	REMARKS
SUITE #50)1W									
100	RECEPTION	CPT1	VL	4"	GWB	PT1	EXISTING -		\longrightarrow	SEE 2/A-1 FOR ACCENT WALL
101	CONFERENCE	CPT1	VL	4"	GWB	PT1	EXISTING -		\longrightarrow	SEE 2/A-1 FOR ACCENT WALL
102	OFFICE	CPT1	VL	4"	GWB	PT1	EXISTING -		\longrightarrow	
103	OFFICE	CPT1	VL	4"	GWB	PT1	EXISTING -		\longrightarrow	
104	OFFICE	CPT1	VL	4"	GWB	PT1	EXISTING -		\longrightarrow	
105	OFFICE	CPT1	VL	4"	GWB	PT1	EXISTING -		\longrightarrow	
106	OPEN OFFICE	CPT1	VL	4"	GWB	PT1	EXISTING -		\longrightarrow	
107	BREAK	VCT	VL	4"	GWB	PT1	ACT1		MATCH	
108	OFFICE	CPT1	VL	4"	GWB	PT1	ACT1		MATCH	
100	TELCO	VCT	1 1/1	4"	CMB	DT1	EVICTING :			

ELEX #1

MAXIMUM TRAVEL DISTANCE IS 70'

1. PROVIDE NEW PARTITIONS AND NEW DOOR AS INDICATED IN 2/A-1

2. PROVIDE NEW SINK/CABS IN BREAK ROOM AS PER 2/A-2

4. PATCH/REPAIR/PAINT EXISTING WALLS AS NECESSARY

3. NEW FINISHES AS PER FINISH SCHEUDLE 4/A-1

SUITE #501W

CONFERENCE

RECEPTION 100

OFFICE 103

COLOR: OPEN POSITION #62208

MANUFACTURER: PATCRAFT STYLE: SOUND INVESTMENTS #10050 COLOR: MASSAGE #50508

COLOR: #101 SEAWEED VINYL COMPOSITION TILE (VCT) MANUFACTURER: ARMSTRONG

MANUFACTURER: SHERWIN WILLIAMS COLOR: SW #6505 ATMOSPHERIC

MANUFACTURER: SHERWIN WILLIAMS COLOR: SW #6507 RESOLUTE BLUE

FINISH SCHEDULE

AMREICA ONE REVISIONS ROM BIRSE DESIGNING. DRAWN BY ASB 04/22/11

design

ALLEN S BIRSE AR94279

WOMEN

ELEX #1

WALL LEGEND EXIST PARTITION TO REMAIN NEW METAL STUD PARTITION


NEW / RELOCATED LIGHT

1. PROVIDE NEW CEILING GRID/LIGHTS AS PER PROPOSED CEILING PLAN 3/A-2

EXISTING LIGHT TO REMAIN

2. REUSE ALL EXISTING CEILING TILE/GRID/LIGHTS IF POSSIBLE 3. NEW CEILING TILES TO MATCH EXISTING 4. ALL NEW CEILING HEIGHTS TO MATCH EXISTING

(PROPOSED) CEILING PLAN

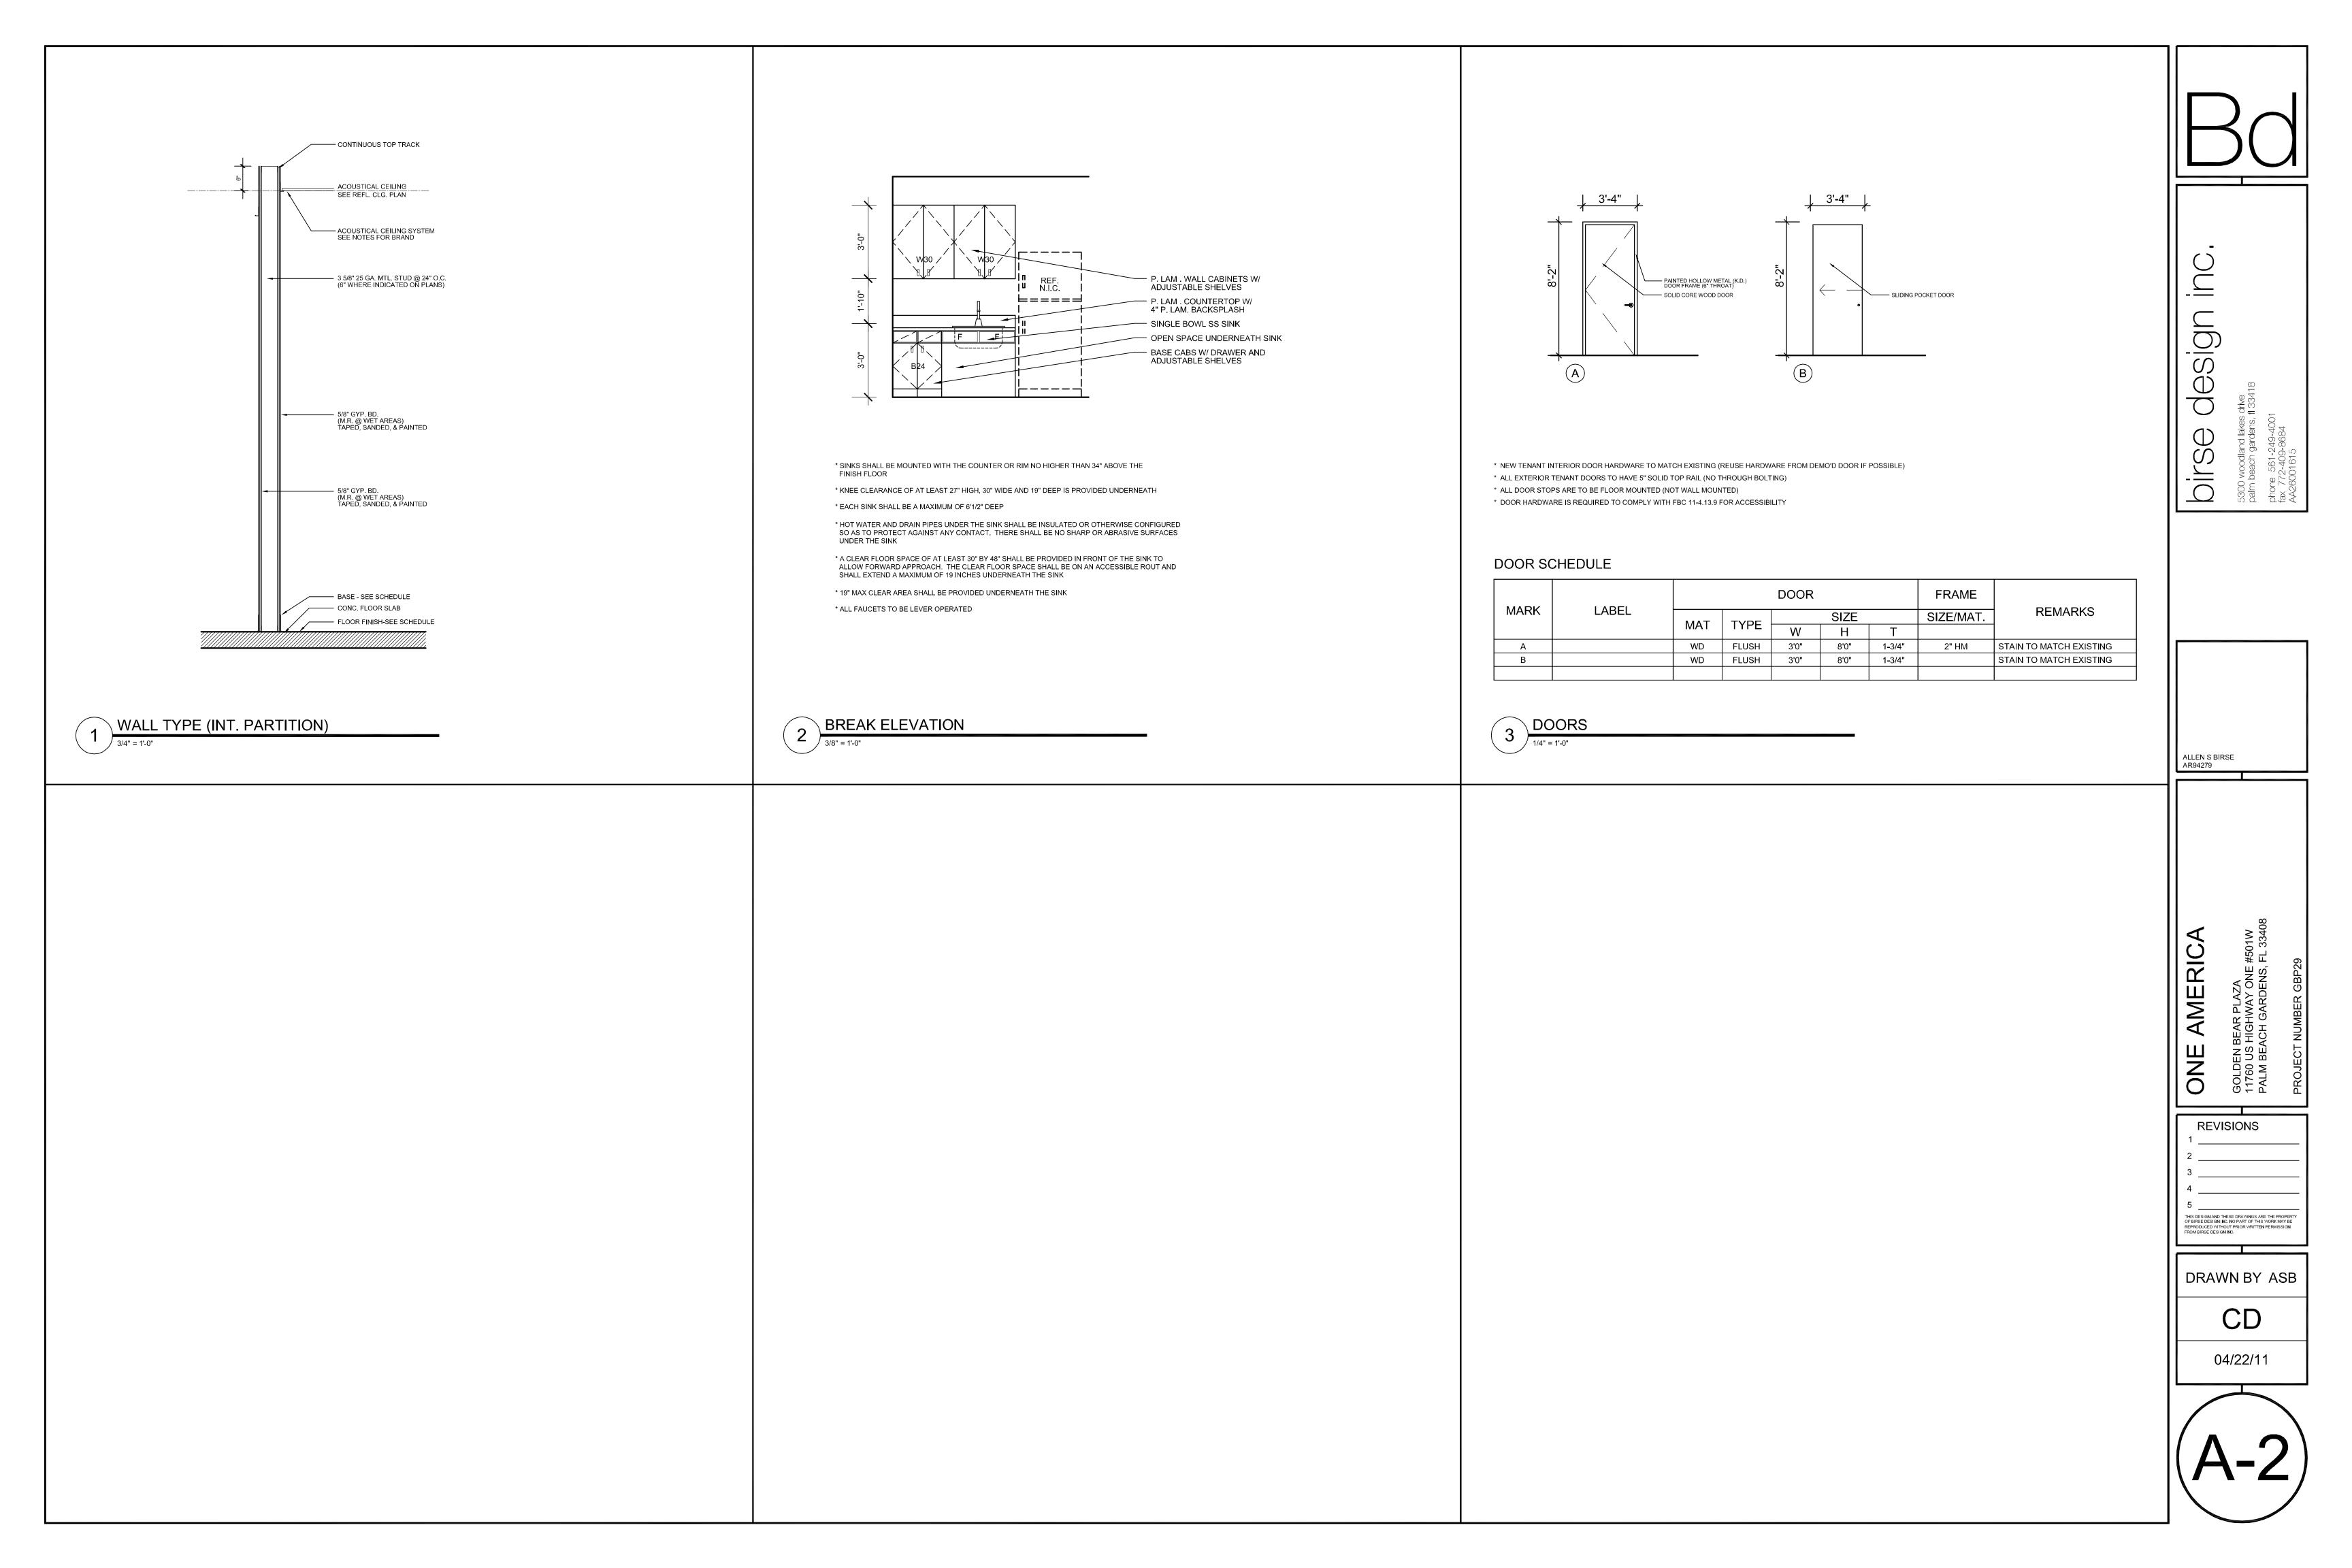


GENERAL DEMOLITION NOTES

- 1. UNLESS OTHERWISE NOTED, ALL EQUIPMENT AND DUCTWORK IN THE PROJECT AREA WHICH IS NOT INDICATED TO REMAIN, IS TO BE REMOVED. THE CONTRACTOR SHALL INVESTIGATE THE PROJECT AREA PRIOR TO BID TO DETERMINE ALL REQUIRED DEMOLITION.
- 2. EXISTING CONDITIONS SHOWN ON THIS DRAWING ARE TAKEN FROM ORIGINAL DRAWINGS AND FIELD INVESTIGATION. ALL EXISTING CONDITIONS MUST BE VERIFIED PRIOR TO BID. FIELD CONDITIONS SHALL GOVERN.
- 3. DEMOLITION WORK IS NOT SPECIFICALLY IDENTIFIED ON THESE PLANS, AND MAY BE DESCRIBED ON THE ARCHITECTS PLANS. THE CONTRACTOR IS RESPONSIBLE FOR ALL REQUIRED DEMOLITION WHETHER SHOWN ON THE PLANS OR NOT.
- 4. ALL MECHANICAL SYSTEMS SERVING OTHER SPACES OR FLOORS, THAT RUN THROUGH THE PROJECT AREA SHALL REMAIN ACTIVE DURING CONSTRUCTION, SO AS NOT TO CAUSE ANY DISRUPTION TO THESE OTHER SPACES.
- 5. ALL ITEMS REMOVED UNDER THIS PROJECT SHALL BE DISPOSED OF OR TURNED OVER TO THE OWNER AT THE OWNER'S DISCRETION.
- 6. PROPERLY REMOVE AND DISPOSE OF ALL HVAC DUCTWORK AND AIR DISTRIBUTION DEVICES WHICH ARE TO BE REMOVED. CONSULT WITH OWNER AND OBTAIN THE OWNER'S APPROVAL PRIOR TO DISPOSAL OF REMOVED MATERIAL.
- 7. IT IS THE CONTRACTOR'S RESPONSIBILITY TO ENSURE THAT ALL PIPING AND DUCTS, NEW OR EXISTING, WITHIN THE PROJECT AREA, ARE PROPERLY SUPPORTED.
- 8. ALL OCCUPIED SPACES ARE TO REMAIN OPERATIONAL DURING BUSINESS HOURS THROUGHOUT THE DEMOLITION AND CONSTRUCTION PERIOD. COORDINATE ALL WORK AS DESCRIBED IN THE ARCHITECTS DOCUMENTS.

HVAC PROJECT SPECIFIC NOTES

CONTRACTOR IS TO INSPECT ALL EXISTING DUCTWORK SHOWN ON THESE PLANS AS REMAINING. REPAIR AS REQUIRED ANY DAMAGED DUCTWORK OR INSULATION. WHERE DUCTWORK IS SHOWN TO BE PARTIALLY REMOVED, CAP, SEAL, AND INSULATE TO MATCH EXISTING METHODS AND MATERIALS.

EXISTING VAV UNITS WHICH ARE REMAINING ARE TO BE INSPECTED, ADJUSTED AND REPAIRED WHERE NECESSARY.

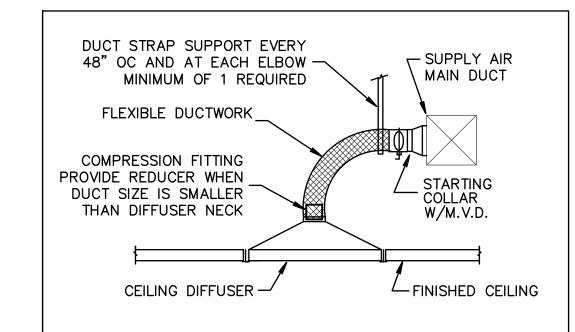

CEILING DIFFUSER DETAIL

MECHANICAL GENERAL NOTES:

- 1. THESE DRAWINGS ARE DIAGRAMMATIC. ALL OFFSETS, FITTINGS, TRANSITIONS AND ACCESSORIES ARE NOT SHOWN. THE CONTRACTOR SHALL INCLUDE IN HIS BID ALL ITEMS REQUIRED TO PROVIDE A COMPLETE AND OPERATIONAL SYSTEM. DO NOT SCALE DRAWINGS FOR INSTALLATION.
- 2. ALL WORK SHALL BE PERFORMED IN A FIRST CLASS WORKMANLIKE MANNER BY LICENSED CONTRACTORS.
- 3. THE CONTRACTOR SHALL OBTAIN AT HIS EXPENSE ALL NECESSARY FEES PERMITS, AND TESTS.
- 4. ALL WORK SHALL CONFORM TO ALL APPLICABLE LOCAL, STATE AND NATIONAL CODES. NO CONTRACTOR SHALL BID UNLESS FAMILIAR WITH THESE CODES.
- 5. CORRECTION OF DEFECTS TO THIS WORK SHALL BE MADE PROMPTLY WITHOUT CHARGE TO THE OWNER. REPAIR AND REPLACEMENT FOR DAMAGE CAUSED BY THIS CONTRACTOR SHALL BE MADE PROMPTLY WITHOUT CHARGE TO THE OWNER.
- ALL WORK OF THIS TRADE SHALL BE COORDINATED WITH ALL OTHER TRADES TO AVOID ANY INTERFERENCES THAT MAY DELAY PROGRESS OF CONSTRUCTION.
- 7. THE CONTRACTOR SHALL INCLUDE THE WORK OF ALL REQUIRED SUB—CONTRACTORS, SUCH AS ELECTRICAL, INSULATING, TEST & BALANCE, ETC., AS REQUIRED FOR A COMPLETE AND OPERATIONAL SYSTEM.
- 8. EQUIPMENT SHALL BEAR A U.L. OR OTHER RECOGNIZED LABEL, NAMEPLATES, WIRING DIAGRAMS, AND ENERGY RATINGS AS APPLICABLE.
- 9. THE CONTRACTOR SHALL INSTALL ALL EQUIPMENT AND ACCESSORIES TO BE READLY ACCESSIBLE FOR SERVICING, TESTING, BALANCING, AND REPLACEMENT.
- 10. THE CONTRACTOR SHALL PROVIDE A WRITTEN GUARANTEE AGAINST DEFECTS IN ALL MATERIALS AND WORKMANSHIP FOR ONE YEAR FROM ACCEPTANCE, WITH FOUR ADDITIONAL YEARS OF WARRANTY ON COMPRESSORS.
- 11. THE CONTRACTOR SHALL PROVIDE THREE COPIES OF SUBMITTAL DATA, SHOP DRAWINGS, AND AT COMPLETION OF THE PROJECT TWO SETS OF OPERATION AND MAINTENANCE MANUALS FOR ALL PROJECT ITEMS.
- 12. PROVIDE ALL CONTROLS, STARTERS, CONTROL WIRING, DISCONNECTS, AND OTHER ELECTRICAL EQUIPMENT AS REQUIRED FOR A COMPLETE AND OPERATIONAL SYSTEM.
- 13. THE HVAC CONTRACTOR IS RESPONSIBLE FOR MAINTAINING, ON SITE, A DETAILED AS—BUILT PLAN SHOWING ACTUAL INSTALLATIONS. THE CONTRACTOR IS TO PROVIDE A NEATLY DRAWN COMPREHENSIVE AS—BUILT SET OF PLANS UPON COMPLETION, WHICH ARE SUITABLE FOR SUBMISSION TO THE BUILDING DEPARTMENT AND TO THE OWNER.
- 14. PRIOR TO ACCEPTANCE BY THE OWNER THE SYSTEMS SHALL BE TESTED AND BALANCED BY THE CONTRACTOR. PROVIDE A WRITTEN REPORT.
- 15. SUPPLY AND INSTALL DUCT MOUNTED SMOKE DETECTORS AS REQUIRED.
- 16. COORDINATE LOCATION OF CEILING DIFFUSERS, GRILLES AND REGISTERS
- IN THE FIELD WITH LIGHTS AND ARCHITECTURAL ELEMENTS.
- 17. ALL GRILLES TO BE TITUS OR METALLAIRE UNLESS OTHERWISE NOTED, SIZES AS SHOWN ON PLANS, ALUMINUM CONSTRUCTION.
- 18. ALL DUCT WORK SHALL BE BUILT AND INSTALLED IN ACCORDANCE WITH SMACNA STANDARDS AND LOCAL BUILDING CODES.
- 19. ALL DUCT SIZES ARE CLEAR INSIDE DIMENSIONS.
- 20. ALL OUTSIDE AIR DUCTWORK SHALL BE SHEETMETAL WITH EXTERIOR R-6 INSULATION. PROVIDE BLANKET TYPE INSULATION IN CONCEALED SPACES, AND BOARD TYPE IN EXPOSED AREAS.
- 21. ALL EXHAUST AIR DUCT SHALL BE GALVANIZED SHEET METAL CONSTRUCTED AND INSTALLED IN ACCORDANCE WITH ASHRAE AND SMACNA STANDARDS.
- 22. FLEXIBLE DUCT, WHERE SHOWN, SHALL BE U.L. CLASS 1, R-6 INSULATION.
- 23. LOW PRESSURE SUPPLY AND RETURN RECTANGULAR DUCTWORK IS RIGID DUCTBOARD, 1 IN. THICK, R-4.2 INSULATION.
- 24. PROVIDE ELBOW TURNING VANES IN ALL RECTANGULAR DUCTS WHERE TURNS ARE GREATER THAN 45 DEGREES.
- 25. PROVIDE BACKDRAFT DAMPERS FOR ALL EXHAUST FANS.
- 26. VERIFY ALL THERMOSTAT LOCATIONS WITH THE LANDLORD.
- 27. CONDENSATE DRAIN PIPING SHALL BE ABOVE GRADE COPPER DRAIN, WASTE AND VENT FITINGS. INSULATE ALL CONDENSATE PIPING W/3/4" IMCOA IMCOLOCK PIPE INSULATION.

ABBREVIATIONS

- VAV VARIABLE AIR VOLUME
- /A SUPPLY AIR
- R/A RETURN AIR
- O/A OUTSIDE AIR
- E/A EXHAUST AIR
- CFM CUBIC FEET PER MINUTE.

 MVD MANUAL VOLUME DAMPER (OPPOSED BLADE TYPE).
- FD FIRE DAMPER
- E EXISTING TO REMAIN
- R RE-LOCATED EXISTING EQUIPMENT

SYMBOL LEGEND

EQUIPMENT TO REMAIN

EQUIPMENT AS NOTED

SUPPLY AIR DIFFUSER TO REMAIN

RETURN/TRANSFER GRILLE TO REMAIN

SUPPLY AIR DIFFUSER AS NOTED

RETURN/TRANSFER GRILLE AS NOTED

--- EXISTING DUCTWORK TO REMAIN

OVERTIME A/C KEYPAD

TYPE B FIRE DAMPER W/ACCESS DOOR.

DUCTWORK AS NOTED

→ MANUAL VOLUME DAMPER


THERMOSTAT TO REMAIN

THERMOSTAT AS NOTED

FLEXIBLE DUCT, U.L. CLASS 1


→ DUCT TRANSITION

CONNECTION TO EXISTING EQUIPMENT

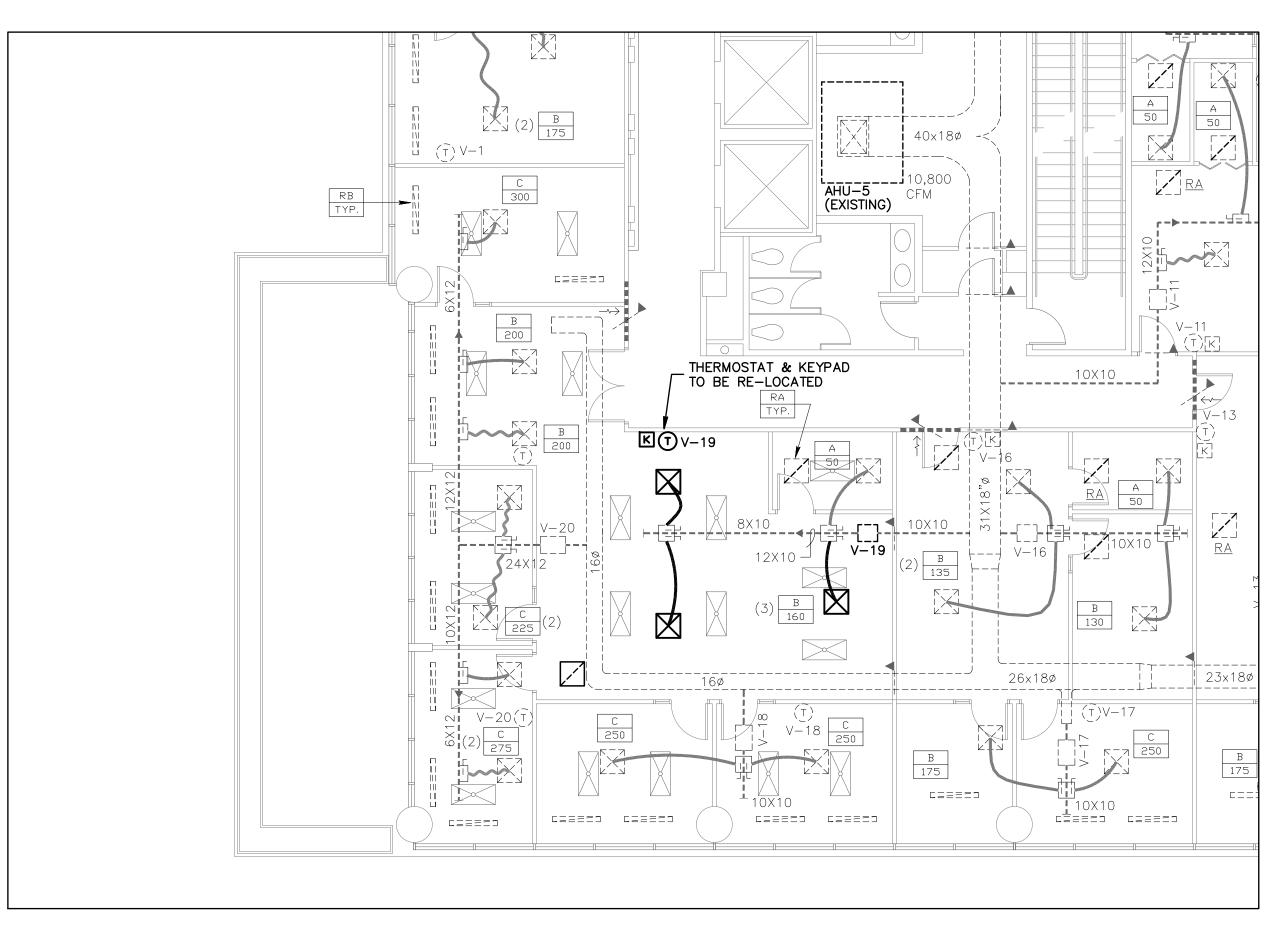

HVAC FLOOR PLAN - EXISTING

SCALE: 1/8" = 1'-0"

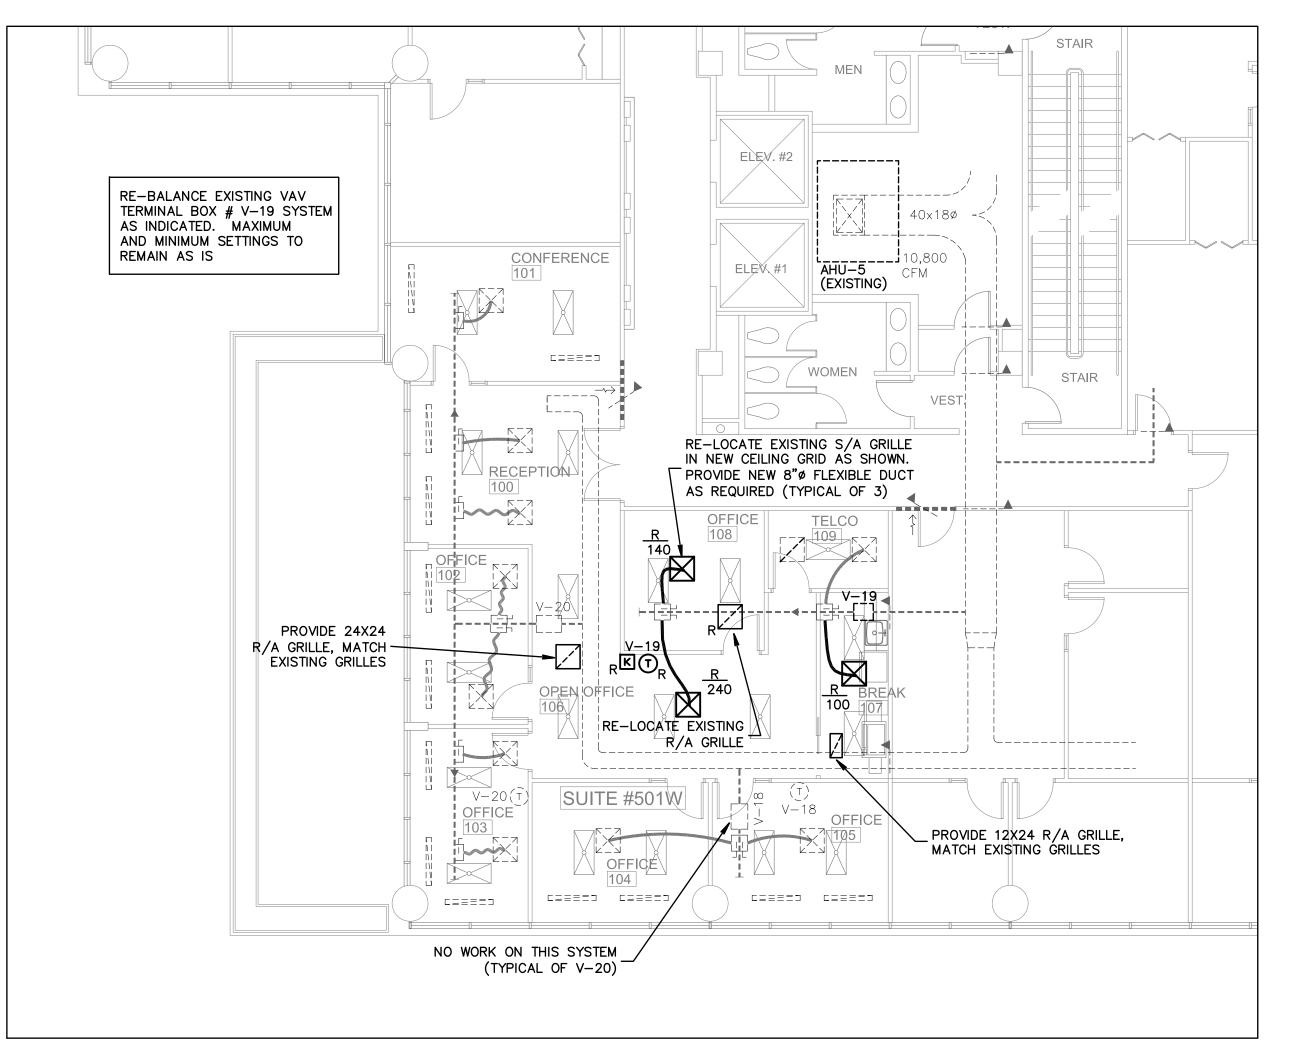

HVAC FLOOR PLAN - PROPOSED

SCALE: 1/8" = 1'-0"

30

DIRSE CESIGN 5300 woodland lakes drive palm beach gardens, fl 33418

ONE AMBEICA

ONE AMBEICA

ONE AMBEICA

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1

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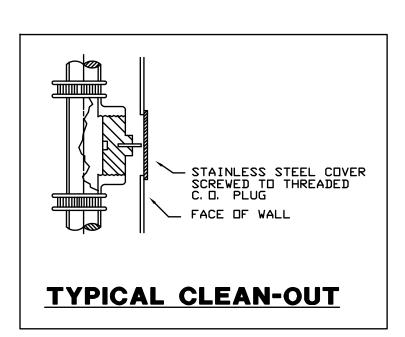
THOURS HIGHWAY ONE #501W
PALM BEACH GARDENS, FL 33408


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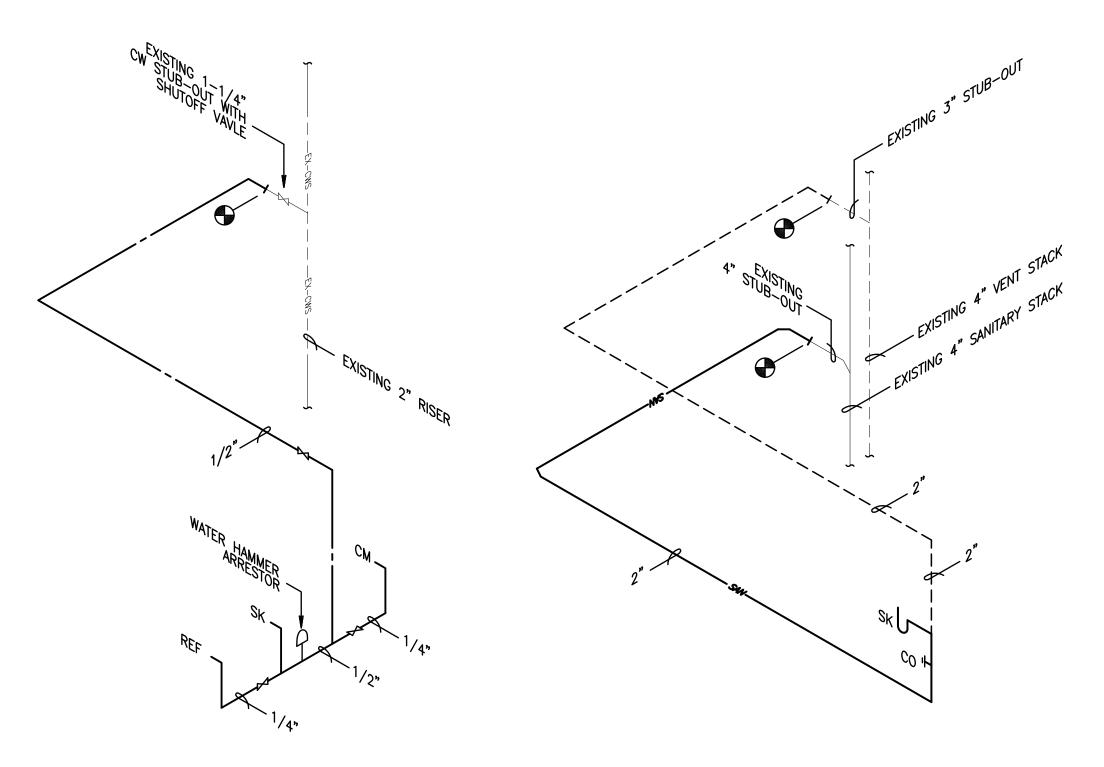
M-1

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4-14-11







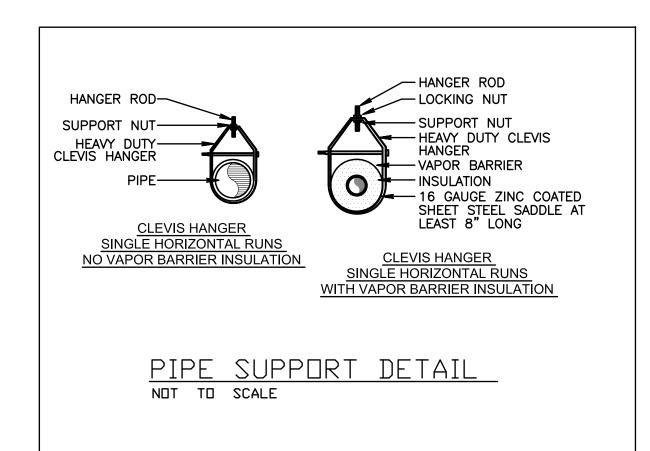

WATER ISOMETRIC

SANITARY ISOMETRIC

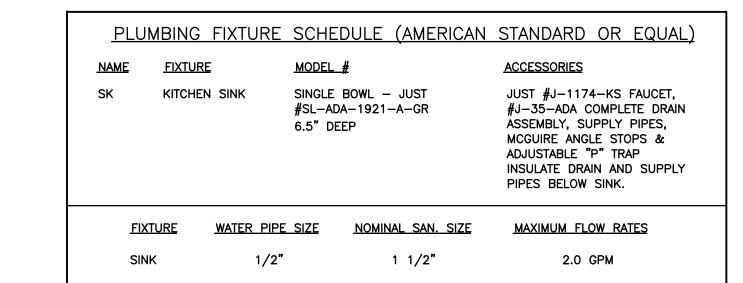

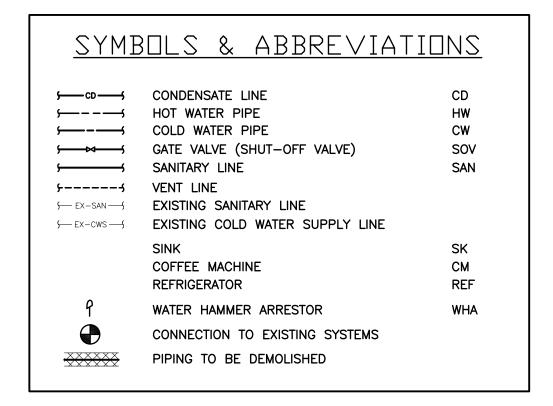

ELEV. #2 CONFERENCE ELEX.#1 CONNECT TO EXISTING STUB-OUTS AT WET COLUMN, FIELD VERIFY EXACT LOCATIONS RECEPTION PROVIDE 1/4" CW SUPPLY FOR COFFEE MACHINE, WATER & VENT WITH SHUTOFF VALVE IN CABINET BELOW SINK. COIL 10 FEET OF COPPER TUBING INSIDE CABINET. PIPING RUN ABOVE -DROPPED CEILING OFFICE OFFICE SUITE #501W SANITARY PIPING RUNS BELOW SLAB IN 4TH — FLOOR CEILING SPACE OPEN OFFICE PROVIDE 1/4" CW SUPPLY FOR REFRIGERATOR ICE MAKER, WITH SHUTOFF VALVE IN CABINET _ BELOW SINK. COIL 10 FT. OF COPPER TUBING ON WALL AT THIS LOCATION. OFFICE OFFICE OFFICE

PLUMBING FLOOR PLAN

SCALE: 1/8" = 1'-0"


AMREIC

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REVISIONS

DRAWN BY DR

4-14-11



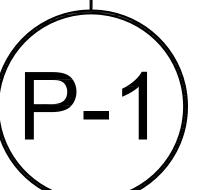

- 1. ALL WORKMANSHIP AND MATERIAL SHALL BE IN STRICT ACCORDANCE WITH APPLICABLE LOCAL CODES, RULES AND ORDINANCES. CONTRACTOR SHALL VISIT THE JOB SITE AND THOROUGHLY FAMILIARIZE HIMSELF WITH ALL EXISTING CONDITIONS.
- ALL MATERIAL SHALL BE NEW. ALL WORK SHALL BE PERFORMED BY A LICENSED PLUMBING CONTRACTOR IN A FIRST CLASS WORKMANLIKE MANNER. THE COMPLETED SYSTEM SHALL BE
- 5. ALL EXCAVATION AND BACKFILL AS REQUIRED FOR THIS PHASE OF CONSTRUCTION SHALL BE A PART OF THIS CONTRACT.
- REQUIRED INSURANCE SHALL BE PROVIDED BY THE CONTRACTOR FOR PROTECTION AGAINST PUBLIC LIABILITY AND PROPERTY DAMAGE FOR THE DURATION OF WORK.
- CONTRACTOR SHALL SECURE AND PAY FOR ALL PERMITS, FEES, INSPECTION & TESTS.
- DRAWINGS ARE DIAGRAMMATIC. DO NOT SCALE FOR THE EXACT LOCATION OF FIXTURES, PIPING, EQUIPMENT, ETC.
- 9. ALL WORK SHALL BE COORDINATED WITH OTHER TRADES TO AVOID INTERFERENCE WITH THE PROGRESS OF CONSTRUCTION. REPORT ANY DISCREPANCY TO ENGINEER/ ARCHITECT PRIOR TO BEGINNING CONSTRUCTION.
- 10 VERIFY LOCATION, SIZE, INVERTS OF ALL EXISTING UTILITIES PRIOR TO BEGINING CONSTRUCTION. ADVISE ENGINEER OF ANY DISCREPANCIES. 11. WATER PIPING SHALL BE TYPE "L" COPPER FOR 2" & UNDER & TYPE "K"
- COPPER FOR 2-1/2" AND ABOVE. ALL UNDERGROUND WATER PIPING SHALL BE 12 SOIL, WASTE, VENT AND STORM DRAIN PIPING SHALL BE CAST IRON NO HUB
- 301-72 ABOVE GRADE AND SCH. 40 PVC BELOW GRADE. 13. CONDENSATE DRAIN TO BE COPPER DRAIN, WASTE & VENT FITTINGS. INSULATE ALL CONDENSATE EXCEPT UNDERGROUND.
- 14. INSULATE PER A.D.A. ALL EXPOSED HANDICAP LAVATORIES DRAIN PIPING AND HOT & COLD STOP AND SUPPLIES. COVERS SHALL BE SOFT, REMOVABLE AND UPC APPROVED. MANUFACTURE: PLUMBEREX HANDY-SHIELD, TRU-BRO OR PRO-SERIES.
- 15. ALL FIXTURES MUST BE PROVIDED WITH READILY ACCESSIBLE STOPS & APPROPRIATELY MARKED ACCESS PANELS. COORDINATE LOCATIONS WITH GENERAL CONTRACTOR PRIOR
- 16. FURNISH AND INSTALL A SIOUX CHIEF HYDRA-RESTER AT EACH GROUP OF FIXTURES. DIELECTRIC COUPLINGS ARE REQUIRED BETWEEN ALL DISSIMILAR METAL IN PIPING
- AND EQUIPMENT CONNECTIONS. 18. ISOLATE COPPER PIPE FROM HANGER OR SUPPORTS WITH ISOLATOR PAD.
- (HAIR FELT LINING). 19. ÀLL FIRE RATED FLOOR AND WALL PENETRATIONS SHALL BE PROPERLY PROTECTED FROM FIRE, SMOKE AND WATER PENETRATION BY FILLING VOIDS BETWEEN PIPE & WALL/FLOOR SLEEVES WITH U.L. APPROVED FIRE/SMOKE/WATER SEALANT.
- 20. CONTRACTOR SHALL GUARANTEE ALL MATERIALS & WORKMANSHIP FREE FROM DEFECTS FOR A PERIOD OF NOT LESS THAN ONE (1) YEAR FROM DATE OF ACCEPTANCE BY OWNER. CORRECTION OF ANY DEFECTS SHALL BE COMPLETED WITHOUT ADDITIONAL CHARGE AND SHALL INCLUDE REPLACEMENT OR REPAIR OF ANY OTHER PHASE OF THE INSTALLATION WHICH MAY HAVE BEEN DAMAGED.
- 21. PROVIDE 1/2" TRAP PRIMER LINE FOR ALL FLOOR DRAINS FROM THE NEAREST PLUMBING FIXTURE OR PROVIDE SIOUX CHIEF #695 TRAP PRIMER. 22. PROVIDE ACCESS PANELS FOR ALL CONCEALED" VALVES AND ALL WATER HAMMER
- ARRESTERS. ACCESS PANELS IN RATED WALLS MUST MAINTAIN THE SAME RATING & MUST MATCH THE FINISH OF THE WALL IN WHICH IT IS INSTALLED. 23. PROVIDE CHROME PLATED COMBINATION COVER PLATE & CLEANOUT PLUG OR
- ACCESS PANEL FOR ALL WALL CLEANOUTS ZURN ZS-1469 SERIES C.O. OR OTHER APPROVED ACCESS PANEL. 24. NO COMBUSTIBLE MATERIAL TO BE USED IN MECHANICAL ROOMS OR IN CEILING
- SPACES WHERE USED AS RETURN AIR PLENUMS.
- 25. ALL PLUMBING FIXTURES SHALL MEET STATE AND LOCAL CODES.

ELECTRICAL LEGEND

LIGHTING FIXTURE IDENTIFICATION

RECTANGULAR LIGHTING FIXTURE - AS NOTED

RECTANGULAR LIGHTING FIXTURE - EXISTING AS NOTED

EXIT LIGHT WITH EMERGENCY BATTERY BACKUP

EMERGENCY LIGHTING FIXTURE WITH BATTERY BACKUP

DUPLEX RECEPT - 20 AMP (18" A.F.F.)

SINGLE RECEPT - 20 AMP (18" A.F.F.)

DUPLEX RECEPT MOUNTED ABOVE COUNTER - 20 AMP (42" A.F.F.)

SINGLE POLE TOGGLE SWITCH, 48" AFF

 $\$_3$ 3-WAY TOGGLE SWITCH, 48" AFF

ELECTRICAL PANELBOARD

✓ MOTOR LOAD

CIRCUIT HOME RUN TO PANELBOARD OR AS INDICATED

CONDUIT CONCEALED

EXISTING CIRCUIT AS NOTED

E CAPPED CONDUIT

TESTING.

TELEVISION OUTLET (18" A.F.F.)

TELEPHONE/DATA OUTLET (18" A.F.F.)

TEL/DATA OUTLET FLUSH FLOOR MOUNTED

EXISTING DUPLEX RECEPTACLE TO REMAIN. EXISTING TELEPHONE/DATA OUTLET TO REMAIN

EXISTING DEVICE TO REMAIN, UNLESS NOTED OTHERWISE

EXISTING DEVICE, RELOCATED AS SHOWN

EXISTING DEVICE TO BE DEMOLISHED OR RELOCATED

OCCUPANCY SENSOR WITH MANUAL SWITCH, HUBBELL LHMTS1, 48" AFF

DCCUPANCY SENSOR, CEILING MOUNT, HUBBELL OMNI DT-2000

FIRE ALARM LEGEND


F MANUAL PULL STATION 48" AFF

WALL MOUNT HORN/STROBE 80" AFF TO BOTTOM

ADA COMPLIANT STROBE LIGHT 80" AFF TO BOTTOM

CEILING SMOKE DETECTOR PHOTOELECTRIC TYPE


ALL DEVICES ARE EXISTING, TO REMAIN AS IS, SHOWN FOR REFERENCE ONLY

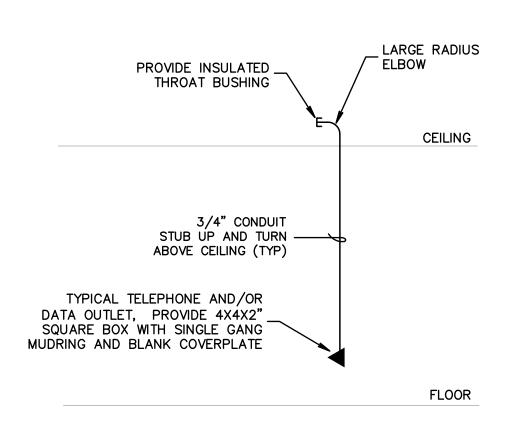

COMMUNICATIONS OUTLET DETAIL NO SCALE

EXISTING FIXTURE TO BE RE-LOCATED _ IN NEW CEILING GRID AS SHOWN

LIGHTING FLOOR PLAN SCALE: 1/8" = 1'-0"

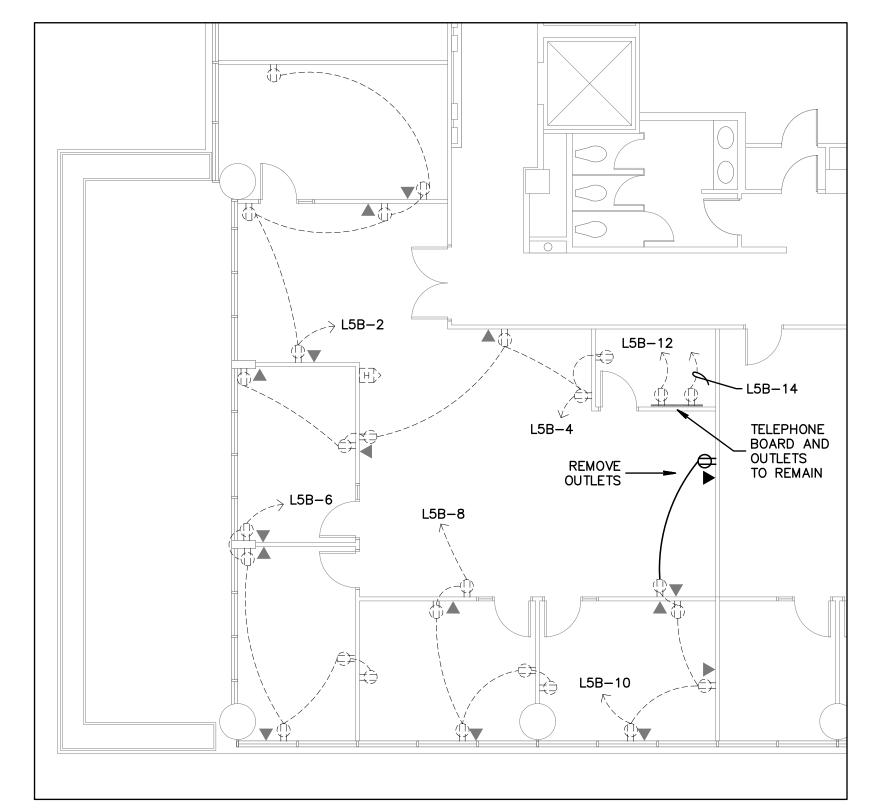

EXISTING ELECTRICAL FLOOR PLAN

SCALE: 1/8" = 1'-0"

ELECTRICAL GENERAL NOTES

DO NOT SCALE THE ELECTRICAL DRAWINGS. REFER TO ARCHITECTURAL PLANS AND ELEVATIONS FOR EXACT LOCATION OF ALL EQUIPMENT. CONFIRM WITH OWNERS REPRESENTATIVE.

ALL WORK SHALL BE DONE IN ACCORDANCE WITH NATIONAL ELECTRICAL CDDE NFPA-70 (2008), THE LIFE SAFETY CDDE NFPA-101 (2006), THE NATIONAL FIRE ALARM CODE NFPA-72 (2002), AND THE FLORIDA BUILDING CODE (FBC 2007 WITH 2009 SUPPLEMENTS).

MINIMUM WIRE SIZE SHALL BE #12 A.W.G., EXCLUDING CONTROL WIRING. UNLESS OTHERWISE NOTED ALL CONDUCTORS SHALL BE COPPER WITH THWN

4. DUTLET BOXES SHALL BE SHEET STEEL IN DRY LOCATIONS, CAST ALLOY WITH THREADED HUBS IN WET OR DAMP LOCATIONS AND SPECIAL ENCLOSURES AS REQUIRED FOR OTHER CLASSIFIED AREAS.

5. DISCONNECT SWITCHES SHALL BE H.P. RATED , HEAVY DUTY, QUICK-MAKE, QUICK-BREAK ENCLOSURES AS REQUIRED BY EXPOSURE.

6. MOTOR STARTERS SHALL BE MANUAL OR MAGNETIC , WITH OVERLOAD RELAYS IN EACH HOT LEG.

7. IT IS NOT THE INTENT OF THESE PLANS TO SHOW EVERY MINOR DETAIL OF CONSTRUCTION, THE CONTRACTOR IS EXPECTED TO FURNISH AND INSTALL ALL ITEMS FOR A COMPLETE ELECTRICAL SYSTEM AND PROVIDE ALL RE-QUIREMENTS NECCESSARY FOR EQUIPMENT TO BE PLACED IN PROPER WORKING

8. ELECTRICAL SYSTEM SHALL BE COMPLETE AND EFFECTIVELY GROUNDED AS REQUIRED BY THE LATEST EDITION OF THE N.E.C.

9. ALL MATERIALS SHALL BE NEW AND BEAR UNDERWRITERS' LABELS

WHERE APPLICABLE. 10. ALL WORK SHALL BE PERFORMED BY A LICENSED ELECTRICAL CONTRACTOR IN A FIRST CLASS WORKMANLIKE MANNER. THE COMPLETED SYSTEM SHALL BE FULLY OPERATIVE, AND ACCEPTED BY ENGINEER/ARCHITECT.

11. ALL WORK SHALL BE COORDINATED WITH OTHER TRADES TO AVOID INTERFERENCE WITH THE PROGESS OF CONSTRUCTION.

12. CONTRACTOR SHALL GUARANTEE ALL MATERIALS AND WORKMANSHIP FREE FROM DEFECTS FOR A PERIOD OF NOT LESS THAN ONE YEAR FROM DATE

13. CORRECTION OF ANY DEFECTS SHALL BE COMPLETED WITHOUT ADDITIONAL CHARGE AND SHALL INCLUDE REPLACEMENT OR REPAIR OF ANY OTHER PHASE OF THE INSTALLATION WHICH MAY HAVE BEEN DAMAGED THEREBY.

14. ALL REQUIRED INSURANCE SHALL BE PROVIDED FOR PROTECTION AGAINST PUBLIC LIABILTY AND PROPERTY DAMAGE FOR THE DURATION OF THE WORK. 15. CONTRACTOR SHALL PAY FOR ALL PERMITS , FEES , INSPECTIONS , AND

16. THE ELECTRICAL INSTALLATION SHALL MEET ALL STANDARD REQUIREMENTS OF POWER AND TELEPHONE COMPANIES.

17. FURNISH AND INSTALL DISCONNECT SWITCHES AND WIRING FOR AIR CONDITIONING SYSTEM AS PER MANUFACTURERS RECOMMENDATIONS. CONTROLS ARE TO BE SUPPLIED BY AIR CONDITIONING CONTRACTOR AND CONNECTED BY ELECTRICAL CONTRACTOR.

18. ALL RACEWAYS UNDERGROUND SHALL BE A MINIMUM OF 3/4" CONDUIT.

19. ALL CIRCUIT BREAKERS , TWO AND THREE POLE , TO BE COMMON TRIP. NO TIE HANDLES , OR TANDEMS WILL BE ACCEPTED.

20. ALL FUSES , UNLESS NOTED ON DRAWING , SHALL BE CURRENT LIMITING (C.L.) RATED FOR 200,000 A.I.C.

21. ALL ELECTRICAL EQUIPMENT, DEVICES, WIRE, ETC., SHALL BE LISTED, FOR THE INTENDED USE, WITH UNDERWRITER'S LABORATORIES, INC. (UL), WHERE STANDARDS HAVE BEEN ESTABLISHED BY UL.

22. THE CONTRACTOR IS RESPONSIBLE TO MAINTAIN, ON SITE, A DETAILED AS-BUILT PLAN SHOWING ACTUAL INSTALLATIONS. THE CONTRACTOR IS TO PROVIDE A NEATLY DRAWN COMPREHENSIVE AS-BUILT SET OF PLANS UPON COMPLETION, WHICH ARE SUITABLE FOR SUBMISSION TO THE BUILDING DEPARTMENT AND THE OWNER.

23. ALL WIRING IS TO BE IN CONDUIT. CABLES ARE NOT ACCEPTABLE EXCEPT WHERE USED FOR FINAL CONNECTIONS TO RECESSED LIGHTING FIXTURES IN LENGTHS UP TO SIX FEET MAXIMUM.

— 2#C, 4# 3/0, #6G-PANEL PANEL п 3 POLE □ | CIRCUIT BREAKER /5 KVA T5A FIFTH FLOOR

THE CONTRACTOR IS RESPONSIBLE FOR ENSURING THAT ALL NEW AND EXISTING ELECTRICAL SYSTEMS, FIXTURES, DEVICES, AND OTHER EQUIPMENT RELATED TO THESE TENANT SPACES ARE IN GOOD WORKING ORDER. REPAIR AS NEEDED.

> LIGHTING ENERGY CODE COMPLIANCE ALLOWANCE: 830 SQ. FT. X 1.1 WATTS = 913 WATTS

INSTALLED: $10 \times 85W = 850 \text{ WATTS}$

PARTIAL EXISTING RISER DIAGRAM

EXISTING PANEL

	TYPE		ESTIN			10B	<u> </u>	A NII			F E	.				BUS: 4			
		ICE: 12			4W		P	AN	CL	, <u> </u>	<u> </u>	<u> </u>			EUTR		FULL		
		TING: SL		Ε											4INS:		_UGS	ILY	
L	POLE	S: 42	<u>-</u>											<u>. А.</u>	I.C.	1	l0K	1	
	DEM.	NO DEM.	TRIP	CDN-	WIRE		REMAR	RKS	скт.	скт.	R	EMARI	<s< td=""><td>WIRE</td><td>CDN-</td><td>TRIP</td><td>NO DEM.</td><td>DEM.</td><td></td></s<>	WIRE	CDN-	TRIP	NO DEM.	DEM.	
L	K.∨.A.	K.∨.A.	POLE						NO.	NO.					DUIT	POLE	K.∨.A.	K.V.A.	
L		0.9	20-1			SUITE	507	REC.	1	2	SUITE	501	REC.			20-1	0.9		
L		0.9	20-1			SUITE	507	REC.	3	4	SUITE	501	REC.			20-1	0.9		
L		0.9	20-1			SUITE	507	REC.	5	6	SUITE	501	REC.			20-1	0.9		∐ I
L		0.7	20-1			SUITE	507	REC.	7	8	SUITE	501	REC.			20-1	0.9		J I
		0.2	20-1			SUITE	507	TEL.	9	10	SUITE	501	REC.			20-1	0.7		J I
		0.3	20-1			SUITE	507	SERV.	11	12	SUITE	501	TEL.			20-1	0.2		
ſ		0.9	20-1			SUITE	505	REC.	13	14	SUITE	501	SERV.			20-1	0.3] ∤
ſ		0.9	20-1			SUITE	505	REC.	15	16	SUITE	501	REC.	12	1/2	20-1	0.5		2
ſ		0.9	20-1			SUITE	505	REC.	17	18	501 RE	FRIC	٥.	12	1/2	20-1	0.8		1 T
ſ		0.9	20-1			SUITE	505	REC.	19	20	501 AF	PPLIA	ANCE	12	1/2	20-1	1.5		1
ľ		0.2	20-1			SUITE	505	TEL.	21	22	501 C]PY	масн.	12	1/2	20-1	0.8		1 ₩
ľ		0.3	20-1			SUITE	505	SERV.	23	24	SPARE					20-1			1 '
ľ		0.9	20-1			SUITE	503	REC.	25	26	SPARE					20-1			1
ľ		0.9	20-1			SUITE	503	REC.	27	28	SPARE					20-1			1
ľ		0.7	20-1			SUITE	503	REC.	29	30	SPARE					20-1			1
ľ		0.2	20-1			SUITE	503	TEL.	31	32	SPARE					20-1			1
ľ		0.3	20-1			SUITE	503	SERV.	33	34	505 RI	EFRI	G.			20-1	0.6		1
ľ			20-1			SPARE			35	36	505 AI	PPLI	ANCE			20-1	1.5		1 T
ľ			20-2			SPARE			37	38	505 CI	ΠΡΥ	MACH.			20-1	0.8		11
ľ									39	40	505	INST	A-HDT			20-2	4.2		1
ľ		0.2	20-1			VAV	CONT	ROLS	41	42									1 ₩
ľ		11.2			•	•				•				•			15.6		1
٠			J					SECTION	I A LO	DAD:	19.7 k	(VA							1

SECTION B LOAD: 26.8 KVA

TOTAL LOAD: 46.5 KVA = 129 AMPS

(1) EXISTING CIRCUITS TO REMAIN AS IS, SHOWN FOR REFERENCE ONLY. (2) EXISTING SPARE CIRCUIT BREAKER TO BE RE-USED AS SHOWN.



PROPOSED ELECTRICAL FLOOR PLAN

design

AMREIC REVISIONS

ROM BIRSE DESIGN INC.

DRAWN BY DR

4-14-11

